#### **GENERAL LAND USE APPLICATION WORKSHEET**

Name of Proposed				
Project or Subdivision				
Property Owner/Applicant	Name			
очнену друшение	Mailing Address Including City, State and Zip Code			
	Phone Number			
	Email			
Applicant's Representative	Name			
This person will be the primary contact for staff, and is the authorized	Mailing Address Including City, State and Zip Code			
agent in place of the	Phone Number			
property owner	Email			
Neighborhood Group Contact	Organization			
Be sure to include a copy of the letter or e-mail	Contact Name			
that was sent	Phone Number			
	Date letter/e-mail sent			
Council Member Contact  Be sure to include a copy	Name			
of the letter or e-mail that was sent	Ward			
that was sent	Phone Number			
	Date letter/e-mail sent			
Property Information Provide a separate sheet, if needed	Address(es)			
	Identification Number(s)			
	Lot Area (sq ft)			
	Zoning classification(s)			
Building Data  Fill in existing & proposed even when no change is	Gross floor area (square feet)	Existing to remain:	Proposed new:	Total:
proposed	Building footprint area (square feet)	Existing to remain:	Proposed new:	Total:

	Building height	Existing stories:	Proposed stories:
		Existing feet:	Proposed feet:
	Dwelling units	Existing:	Proposed:
	Net residential area		Proposed:
Parking Data	Total number of spaces	Existing:	Proposed:
	Number of standard spaces	Proposed:	
	Number of compact spaces	Proposed:	
	Number of handicap spaces	Proposed:	
	Number of bicycle spaces	Proposed:	
	Number of loading spaces	Proposed:	
Landscaping Data	Landscaped area (square feet)	Existing:	Proposed:
Impervious Surface Data	Impervious surfaces (square feet)	Existing:	Proposed:
Property History	Name of current business:	Beginning / end dates:	Type of business / use:
Fence Data Indicate location on site	First fence (check one): Existing / Proposed	Type / material (i.e. wood, chain-link):	Length (feet):
plan			Height (feet):
	Second fence (check one): Existing / Proposed	Type / material (i.e. wood, chain-link):	Length (feet):
	, , ,	,	Height (feet):
Sign Data Include a sign plan with	Number of signs	Existing:	Proposed:
elevations for new signage	First sign (check one):	Type of sign (circle one):	Length x Width (feet):
Signage	Existing / Proposed	Freestanding / Mounted	
		If lit, how?	Area (square feet):
			Height above grade (feet):
	Second sign (check one):	Type of sign (circle one):	Length x Width (feet):
	Existing / Proposed	Freestanding / Mounted	
	·	If lit, how?	Area (square feet):
			Height above grade (feet):



In Partnership With



802 Lower Johnson Circle St. Peter, MN 56082 507-720-1398 matt@brightpixeldesign.com

#### 4900 Highway 169 Suite #303 New Hope, MN 55428 612-810-9628 763-550-2919 FAX

## Project Narrative 112 E. Lake Street

To: Andrew Frenz
From: Matt Borowy
Date: 12/15/2020

Re: Site Plan Review & Variance

#### Mr Frenz,

I want to thank you for the opportunity to submit the following project narrative for the proposed mixed-use development located at 112 East Lake Street in Minneapolis, MN.

Per our previous correspondence, my team's desire is to work closely with the city staff over the following weeks to carry out the review process. We would like to thank you for the support and patience that has been afforded to our team thus far. The project team requests approval of the building and site designs as specified in the attached drawings.

This project intends to replace a building that was burned down in the civil unrest of 2020. The design team is proposing a 4-story mixed-use building with primarily retail space on the first level with 3 levels of 1 bedroom apartments above. An accessible apartment will be provided on the first level. The total number of apartment units will be 13, and 6 parking stalls are planned for the site.

## **Design Direction**

The design strategy is to provide a handsome addition to the neighborhood that is consistent with the existing urban scale and design languages. Our team has worked with intentionality to fuse existing design elements of the surrounding neighborhood with a current architectural dialect to produce a solution that is compatible with a neighborhood in transition. Moreover, the design team has coordinated the neighborhood group's requests with the owner's needs.

The proposed materials are brick, metal panels, aluminum & glass, wood-look metal siding and metal trim. The building blends of linear metal panels as well as accents of wood-look siding and color-shifting metal panels. The west elevation provides a large area to allow for a mural in lieu of windows openings. (see variance number 2 below and exterior elevations for more information).

Interior circulation has been designed with a focus on life-safety, access to exterior views and unit efficiency. We have identified the south elevation along Lake Street as the most prominent of the building and have located the south stair shaft accordingly. The traditional urban language of a zero lot line mixed-use building has been preserved with organized fenestration and clear separation of uses between the retail and residential components. The north stair tower has been shifted north of the residential units to allow for ample separation between exit paths and to provide a semi-private courtyard on the north end of the property by using the stair shaft as a "wing wall".

The north stair location has been extensively studied, and this resourceful layout provides the best compromise between code-required items such as the minimum distance between exits and quality-of-life items such as natural light and views.

The north side of the building has also been denoted as the location for vehicular parkings as well as a shared courtyard. The designated enclosure is designed to accommodate a compost container as well as (2) 4 yard containers: one with trash and one with recycled materials. The area required for this operation has been denoted on sheets C2.0 and L1.0. The existing alleyways bordering the north and east property lines provide convenient access for recycling/trash vehicles and automobiles (see variance number 1 below for more information).

#### Sustainable Initiative

Reduction of initial resources and ongoing utilities are important from both a cost containment standpoint and overall environmental stewardship. The design team has targeted several items that work toward that aim. Key sustainable items area as follows:

- Mechanical system featuring high-efficiency units with individually controlled heating and cooling to reduce energy usage
- 2) Electrical system featuring LED lighting to reduce power usage
- 3) Plumbing system featuring low-flow fixtures to reduce water usage
- 4) Maintenance free exterior materials that will reduce product waste and mobilization impacts over the lifetime of the building
- Exterior skin with upgraded R-value that will exceed the current energy code to reduce overall energy use for heating and cooling

## Pedestrian Impact

The proposed development has been designed for efficient and safe pedestrian flow parallel to vehicular flow. Foot and bicycle traffic has been prioritized by providing access on both the north and south ends of the building for retail and residential tenants.

The design team understands that the city is currently undergoing an extensive Lake Street Reconstruction Project. The design engineering team has reviewed the location of these

improvements and has located the building and site elements accordingly to ensure orderly integration with adjacent elements.

#### Variance

#### Findings:

- (1) Practical difficulties exist in complying with the ordinance because of circumstances unique to the property. The unique circumstances were not created by persons presently having an interest in the property and are not based on economic considerations alone.
- (2) The property owner or authorized applicant proposes to use the property in a reasonable manner that will be in keeping with the spirit and intent of the ordinance and the comprehensive plan.
- (3) The proposed variance will not alter the essential character of the locality or be injurious to the use or enjoyment of other property in the vicinity. If granted, the proposed variance will not be detrimental to the health, safety, or welfare of the general public or of those utilizing the property or nearby properties.

Variance number 1: Allow for maneuverability in north and east alleyways for parking access.

Response to finding (1)The project site is 40' wide. Previously the east 18' of the site was used for a row of parking stalls accessed by the existing alleyway. Per feedback from city staff, the building has been designed to include full width of the property along the south elevation facing Lake Street. The resulting space for parking is located to the north behind the building. The effect of this orientation is to hide the vehicular parking and help to separate vehicular traffic from foot traffic on the sidewalk. However, for this solution to work, vehicular circulation is dependent on the use of the alleyways.

Response to finding (2) The design team understands the ordinance is intended to ensure that the alleyways remain open and functional for vehicular, cycling and pedestrian traffic. A large, busy parking area that is reliant on maneuverability in the alleyways could impede flow and create a dangerous space. We feel that the proposed site plan with 6 stalls does not create a hazardous condition and actually reduces the load from the previous usage.

Response to finding (3) The essential character of the locality is set to be improved through acceptance of this variance. Street scape frontage is preserved, utilities are discretely hidden away, ada route is direct, and public & private entrances are separated.

Variance number 2: Request for alternative compliance for maximum floor area ratio.

Response to finding (1) The current zoning requires at a minimum a 4 story building.

Response to finding (2) A mixed use retail and apartment building is in-keeping with the present and future spirit of the neighborhood

Response to finding (3) This is a neighborhood in transition, and the current ordinance is not written for 4-15 story developments. The design team requests approval of floor area ratio per the updated ordinances that will be forthcoming. Granting this variance request will not be detrimental to the safety of the building users or the general public.

## Alternative Compliance

Number 1: Request alternative compliance for first-floor north elevation window coverage requirements

The width of the building on the north elevation is 44' and contains three entrance points. Fenestration has been designed to maintain the rhythm of the upper floors of the building on the first level. Full-glass aluminum doors have been suggested in-lieu of windows to provide access to building and to comply with the spirit of the ordinance.

Number 2: Request alternative compliance for mural panel on west elevation in lieu of window openings

With an adjacent lot to the west, it is the owner's expectation that a 4-story building will be constructed that will fully-obscure the west elevation. The design team understands the ordinance is intended to ensure that proposed developments do not focus design efforts on the "front" of the building while neglecting the other elevations. A mural space has been proposed in the solid wall to provide visual interest as a substitute. The proposed design incorporates primarily the same materials as the rest of the building to maintain visual consistency.

Number 3: Request for alternative compliance for exterior material types

The project team has worked closely with the Whittier Alliance to incorporate the design and materials that the group is looking for. This will be the first major development in this neighborhood following the civil unrest of 2020 and will set the stage for subsequent projects. We have agreed that vertically oriental metal panels with accents of wood and brick provide the right balance of cost, durability and design aesthetic.

Once again, thank you for this opportunity to submit this preliminary site/building plan package. If you have any questions regarding this submittal, please do not hesitate to call.

Sincerely,

Matt J. Borowy
Bright Pixel Design

507.720.1398

www.brightpixeldesign.com

Borowy

# 112 EAST LAKE STREET

MINNEAPOLIS, MINNESOTA

ISSUED FOR: MIXED USE BUILDING



## ARCHITECT:

BRIGHTPIXEL DESIGN 802 LOWER JOHNSON CIR, ST PETER, MN 56082 CONTACT: MATT BOROWY MATT@BRIGHTPIXELDESIGN.COM 507-7201398

## <u>DEVELOPER</u> / PROPERTY OWNER:

JWT LAKE ST, LLC 2400 BLAISDELL AVE MINNEAPOLIS, MN 55404

## ENGINEER / LANDSCAPE ARCHITECT:

CIVIL SITE GROUP 4931 W 35TH STREET SUITE 200 ST LOUIS PARK, MN 55416 612-615-0060

## SURVEYOR:

CIVIL SITE GROUP 4931 W 35TH STREET SUITE 200 ST LOUIS PARK, MN 55416 CONTACT: RORY SYNSTELIEN 612-615-0060

## GEOTECHNICAL ENGINEER:

ALL EXISTING UTILITY LOCATIONS SHOWN ARE APPROXIMATE. CONTACT "GOPHER STATE ONE CALL" (651-454-0002 OR 800-252-1166) FOR UTILITY LOCATIONS. 48 HOURS PRIOR TO CONSTRUCTION. THE CONTRACTOR SHALL REPAIR OR REPLACE ANY UTILITIES THAT ARE DAMAGED DURING CONSTRUCTION AT NO COST TO THE OWNER.

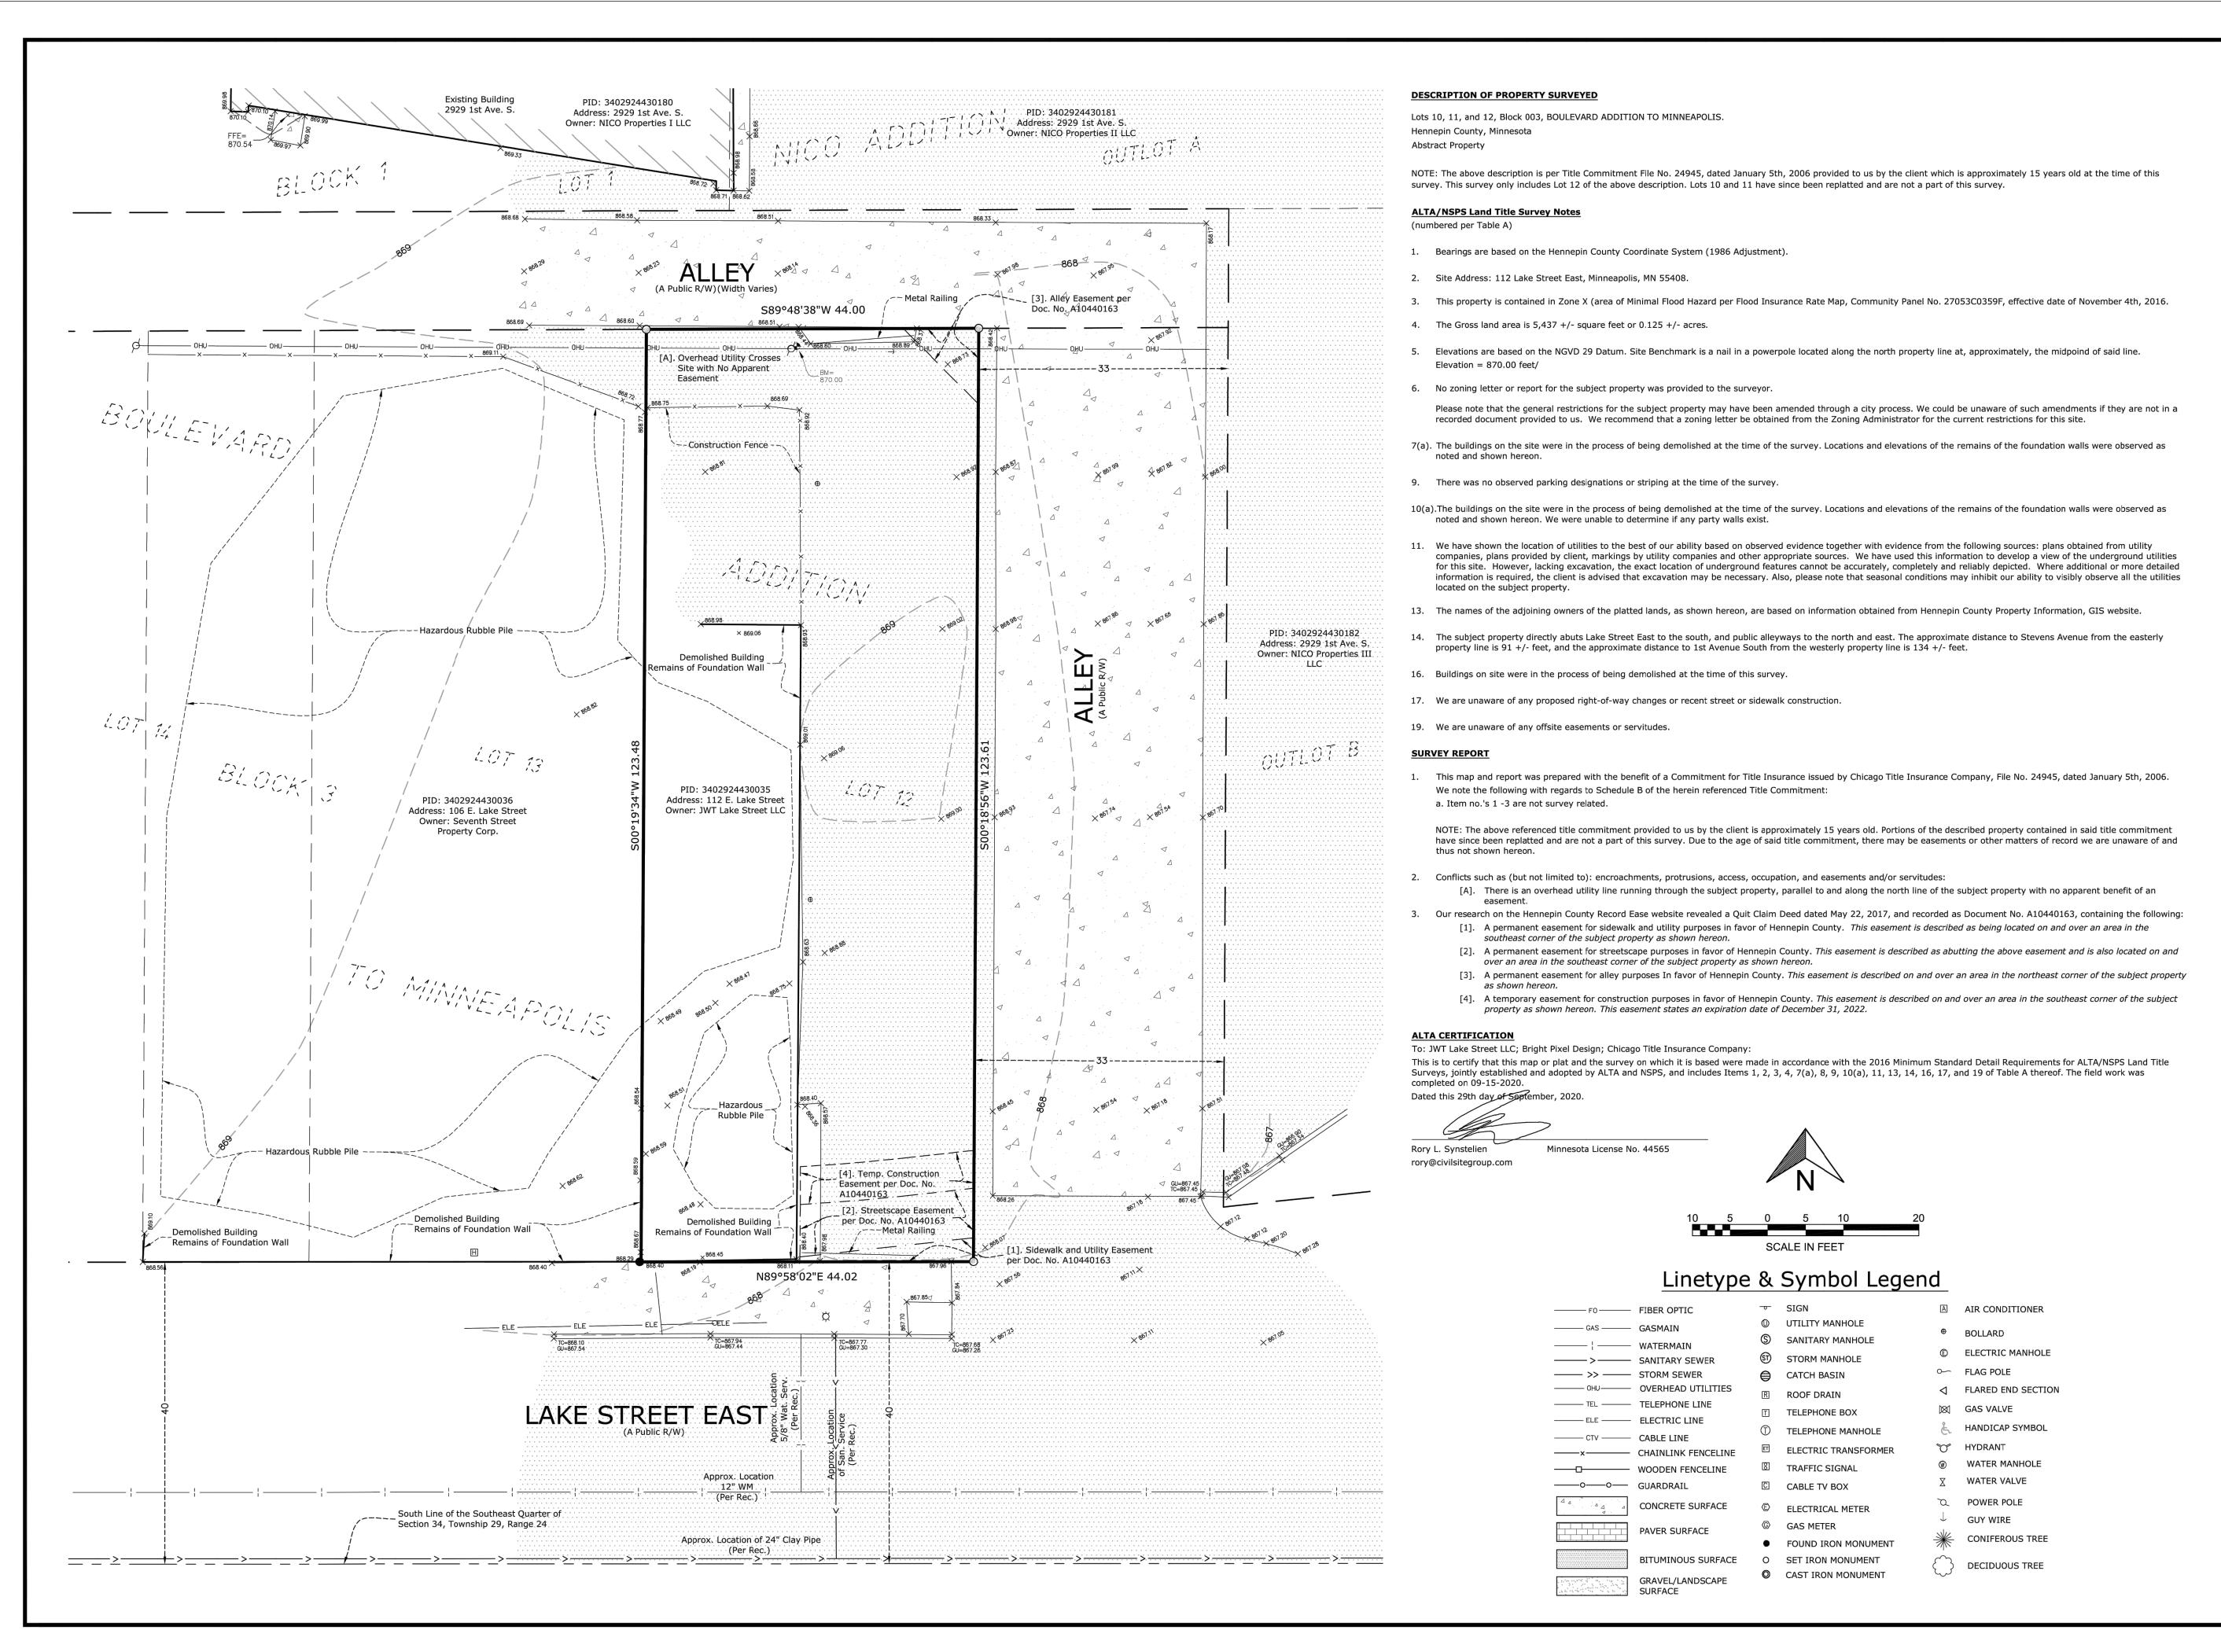


DATE 12/14/20 LICENSE NO. 44263 ISSUE/SUBMITTAL SUMMARY DATE DESCRIPTION 10/08/2020 PDR SUBMITTAL 10/20/20 PDR SUBMITTAL 11/02/20 PDR SUBMITTAL SHEET INDEX 12/14/20 MIXED USE BUILDING SHEET NUMBER | SHEET TITLE C0.0 TITLE SHEET V1.0 SITE SURVEY C1.0 REMOVALS PLAN C2.0 SITE PLAN C3.0 GRADING PLAN C4.0 UTILITY PLAN C5.0 CIVIL DETAILS C5.1 CIVIL DETAILS L1.0 LANDSCAPE PLAN L1.1 LANDSCAPE PLAN NOTES & DETAILS DRAWN BY:KB, KW REVIEWED BY: MP SW1.0 SWPPP - EXISTING CONDITIONS PROJECT NUMBER: 20267 SW1.1 SWPPP - PROPOSED CONDITIONS **REVISION SUMMARY** SW1.2 | SWPPP - DETAILS DATE DESCRIPTION SW1.3 SWPPP - NARRATIVE TITLE SHEET

STREET

St. Louis Park, MN 55416

I HEREBY CERTIFY THAT THIS PLAN, SPECIFICATION, OR REPORT WAS PREPARED BY ME OR UNDER MY DIRECT SUPERVISION AND THAT I AM A DULY LICENSED PROFESSIONAL ENGINEER UNDER THE LAWS OF THE STATE OF



Civil Engineering • Surveying • Landscape Architecture
4931 W. 35th Street, Suite 200

St. Louis Park, MN 55416 ivilsitegroup.com 612-615-0060

**;** 88

Street East pin County, Minnesota 55408

Design

Pixel

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112 Lake
Minneapolis, Henne

BY CERTIFY THAT THIS SURVER REPORT WAS PREPARED B

I HEREBY CERTIFY THAT THIS SURVEY, PLAN, OR REPORT WAS PREPARED BY ME OR UNDER MY DIRECT SUPERVISION AND THAT I AM A DULY LICENSED LAND SURVEYOR UNDER THE LAWS OF THE STATE OF MINNESOTA.



FIELD CREW MS/AS
DRAWN BY SW
REVIEWED BY CJ
UPDATED BY .

VICINITY MAP

W.ZTIII. SL.

W.ZSIII. SL.

W.ZZIII. SL.

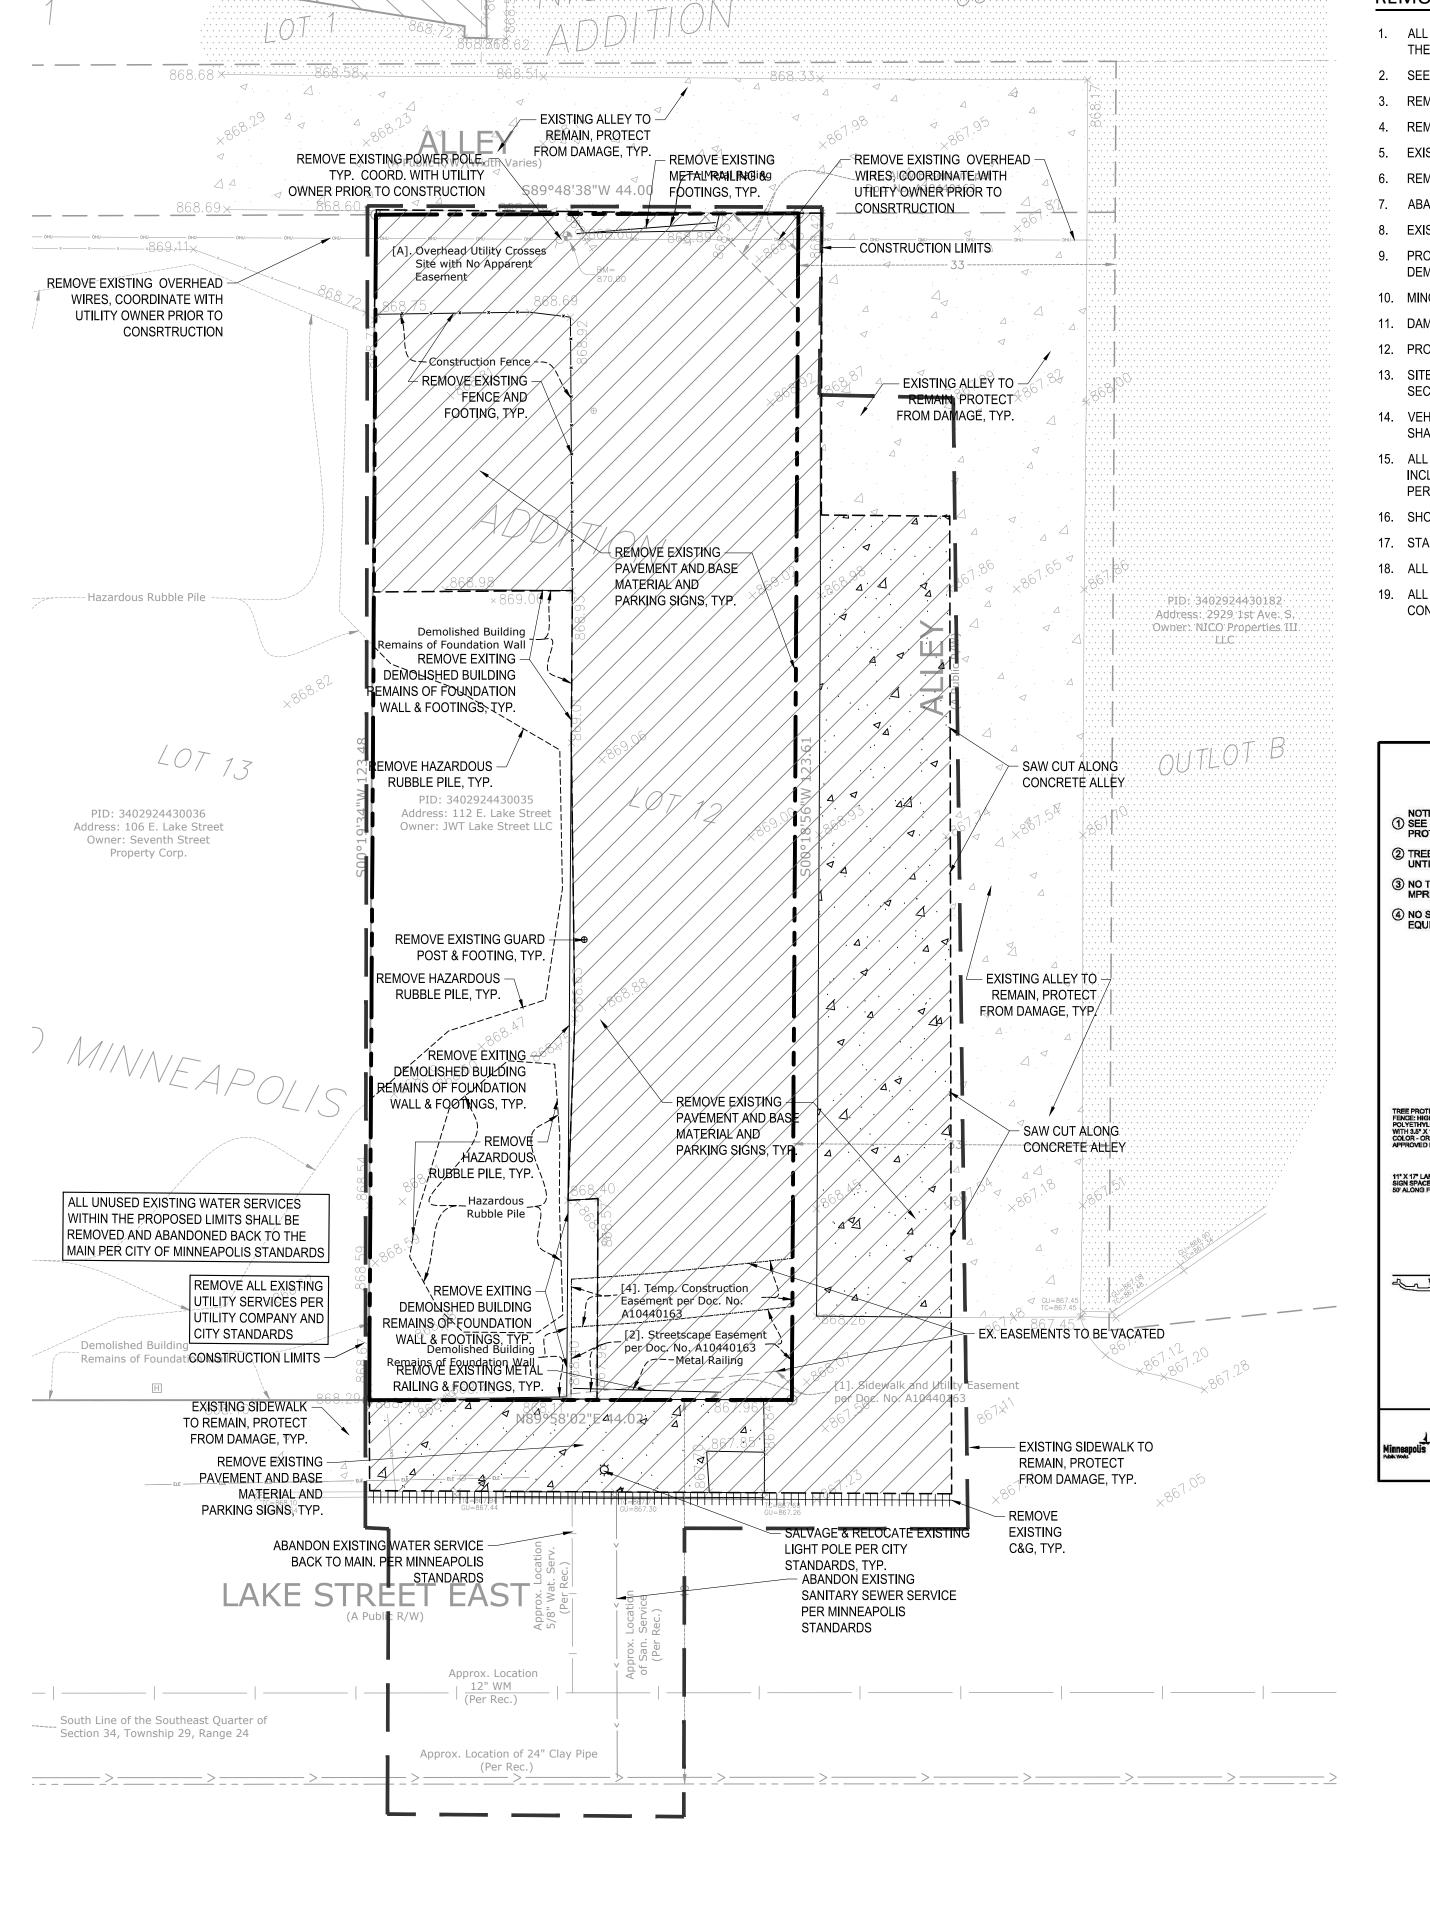
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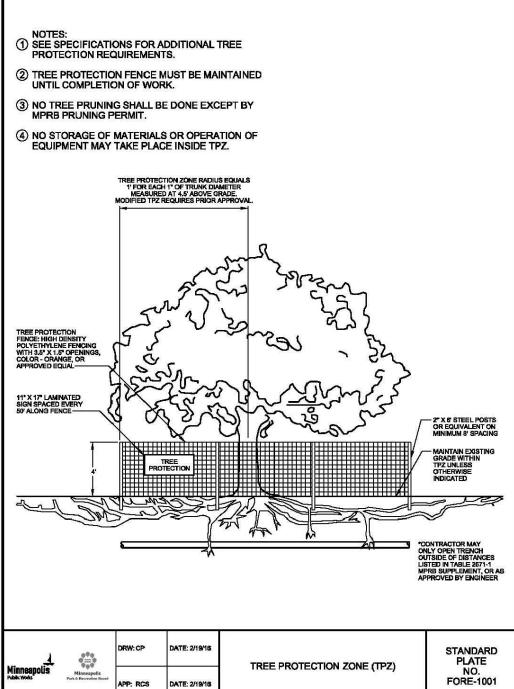
> ALTA/NSPS LAND TITLE SURVEY

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### **REMOVAL NOTES:**

- 1. ALL EXISTING UTILITY LOCATIONS SHOWN ARE APPROXIMATE. CONTACT "GOPHER STATE ONE CALL" (651-454-0002 OR 800-252-1166) FOR UTILITY LOCATIONS, 48 HOURS PRIOR TO CONSTRUCTION THE CONTRACTOR SHALL REPAIR OR REPLACE ANY UTILITIES THAT ARE DAMAGED DURING CONSTRUCTION AT NO COST TO THE OWNER.
- 2. SEE STORM WATER POLLUTION PREVENTION PLAN (SWPPP) PLAN FOR CONSTRUCTION STORM WATER MANAGEMENT PLAN.
- REMOVAL OF MATERIALS NOTED ON THE DRAWINGS SHALL BE IN ACCORDANCE WITH MNDOT, STATE AND LOCAL REGULATIONS.
- 4. REMOVAL OF PRIVATE UTILITIES SHALL BE COORDINATED WITH UTILITY OWNER PRIOR TO CONSTRUCTION ACTIVITIES.
- 5. EXISTING PAVEMENTS SHALL BE SAWCUT IN LOCATIONS AS SHOWN ON THE DRAWINGS OR THE NEAREST JOINT FOR PROPOSED PAVEMENT CONNECTIONS.
- 6. REMOVED MATERIALS SHALL BE DISPOSED OF TO A LEGAL OFF-SITE LOCATION AND IN ACCORDANCE WITH STATE AND LOCAL REGULATIONS.
- 7. ABANDON, REMOVAL, CONNECTION, AND PROTECTION NOTES SHOWN ON THE DRAWINGS ARE APPROXIMATE. COORDINATE WITH PROPOSED PLANS.
- 8. EXISTING ON-SITE FEATURES NOT NOTED FOR REMOVAL SHALL BE PROTECTED THROUGHOUT THE DURATION OF THE CONTRACT.
- 9. PROPERTY LINES SHALL BE CONSIDERED GENERAL CONSTRUCTION LIMITS UNLESS OTHERWISE NOTED ON THE DRAWINGS. WORK WITHIN THE GENERAL CONSTRUCTION LIMITS SHALL INCLUDE STAGING, DEMOLITION AND CLEAN-UP OPERATIONS AS WELL AS CONSTRUCTION SHOWN ON THE DRAWINGS.
- 10. MINOR WORK OUTSIDE OF THE GENERAL CONSTRUCTION LIMITS SHALL BE ALLOWED AS SHOWN ON THE PLAN AND PER CITY REQUIREMENTS.
- 11. DAMAGE BEYOND THE PROPERTY LIMITS CAUSED BY CONSTRUCTION ACTIVITY SHALL BE REPAIRED IN A MANNER APPROVED BY THE ENGINEER/LANDSCAPE ARCHITECT OR IN ACCORDANCE WITH THE CITY.
- 12. PROPOSED WORK (BUILDING AND CIVIL) SHALL NOT DISTURB EXISTING UTILITIES UNLESS OTHERWISE SHOWN ON THE DRAWINGS AND APPROVED BY THE CITY PRIOR TO CONSTRUCTION.
- 13. SITE SECURITY MAY BE NECESSARY AND PROVIDED IN A MANNER TO PROHIBIT VANDALISM, AND THEFT, DURING AND AFTER NORMAL WORK HOURS, THROUGHOUT THE DURATION OF THE CONTRACT. SECURITY MATERIALS SHALL BE IN ACCORDANCE WITH THE CITY.
- 14. VEHICULAR ACCESS TO THE SITE SHALL BE MAINTAINED FOR DELIVERY AND INSPECTION ACCESS DURING NORMAL OPERATING HOURS. AT NO POINT THROUGHOUT THE DURATION OF THE CONTRACT SHALL CIRCULATION OF ADJACENT STREETS BE BLOCKED WITHOUT APPROVAL BY THE CITY PRIOR TO CONSTRUCTION ACTIVITIES.
- 15. ALL TRAFFIC CONTROLS SHALL BE PROVIDED AND ESTABLISHED PER THE REQUIREMENTS OF THE MINNESOTA MANUAL ON UNIFORM TRAFFIC CONTROL DEVICES (MMUTCD) AND THE CITY. THIS SHALL INCLUDE, BUT NOT BE LIMITED TO, SIGNAGE, BARRICADES, FLASHERS, AND FLAGGERS AS NEEDED. ALL PUBLIC STREETS SHALL REMAIN OPEN TO TRAFFIC AT ALL TIMES. NO ROAD CLOSURES SHALL BE PERMITTED WITHOUT APPROVAL BY THE CITY.
- 16. SHORING FOR BUILDING EXCAVATION MAY BE USED AT THE DISCRETION OF THE CONTRACTOR AND AS APPROVED BY THE OWNERS REPRESENTATIVE AND THE CITY PRIOR TO CONSTRUCTION ACTIVITIES.
- 17. STAGING, DEMOLITION, AND CLEAN-UP AREAS SHALL BE WITHIN THE PROPERTY LIMITS AS SHOWN ON THE DRAWINGS AND MAINTAINED IN A MANNER AS REQUIRED BY THE CITY.
- 18. ALL EXISTING SITE TRAFFIC/REGULATORY SIGNAGE TO BE INVENTORIED AND IF REMOVED FOR CONSTRUCTION SHALL BE RETURNED TO LGU.
- 19. ALL EXISTING UTILITY LOCATIONS SHOWN ARE APPROXIMATE. CONTACT "GOPHER STATE ONE CALL" (651-454-0002 OR 800-252-1166) FOR UTILITY LOCATIONS, 48 HOURS PRIOR TO CONSTRUCTION. THE CONTRACTOR SHALL REPAIR OR REPLACE ANY UTILITIES THAT ARE DAMAGED DURING CONSTRUCTION AT NO COST TO THE OWNER.



## CITY OF MINNEAPOLIS REMOVAL NOTES:

- ALL EXISTING AND PROPOSED UNDERGROUND PUBLIC UTILITIES (WATER, SANITARY, AND STORM DRAIN) SHALL BE SHOWN ON THE SITE PLAN WITH CORRESPONDING PIPE SIZES AND TYPES. FOR PUBLIC WATERMAIN INFRASTRUCTURE RECORDS CALL (612)673-2865. ANY EXISTING WATER SERVICE CONNECTIONS TO THE SITE SHALL BE NOTED ON THE PLANS FOR REMOVAL, AND SHALL BE REMOVED PER THE REQUIREMENTS OF THE UTILITY CONNECTIONS DEPARTMENT BEFORE ANY NEW SERVICES LINES CAN BE INSTALLED, CALL (612)673-2451 FOR MORE INFORMATION.
- ANY EXISTING CONCRETE INFRASTRUCTURE IN THE PUBLIC RIGHT OF WAY, INCLUDING BUT NOT LIMITED TO PUBLIC SIDEWALKS, CURB AND GUTTER, AND ADA PEDESTRIAN RAMPS, THAT IS EITHER CURRENTLY DEFECTIVE OR THAT IS DAMAGED DURING THE TIME OF SITE RE-DEVELOPMENT, MUST BE REMOVED AND REPLACED AT THE TIME OF SITE RE-DEVELOPMENT.

## OWNER INFORMATION

OWNER: JWT LAKE ST. LLC 2400 BLAISDELL AVE MINNEAPOLIS, MN 55404

## OWNER, DEVELOPER, CONTRACTOR SIGNED STATEMENT

ALL CLEARING, GRADING, CONSTRUCTION OR DEVELOPMENT WILL BE DONE PURSUANT TO THE PLAN. SIGNED BY PARTIES BELOW:

OWNER: \_

CONTRACTOR:

4931 W. 35th Street, Suite 200

civilsitegroup.com

St. Louis Park, MN 55416

612-615-0060

I HEREBY CERTIFY THAT THIS PLAN,

SPECIFICATION, OR REPORT WAS PREPARED BY ME OR UNDER MY DIRECT SUPERVISION AND THAT I AM A DULY LICENSED PROFESSIONAL ENGINEER UNDER THE LAWS OF THE STATE OF

Matthew R. Pavek

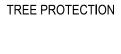
DATE 12/14/20 LICENSE NO. 44263 ISSUE/SUBMITTAL SUMMARY

DATE DESCRIPTION 10/08/2020 PDR SUBMITTAL 10/20/20 PDR SUBMITTAL 11/02/20 PDR SUBMITTAL

12/14/20 MIXED USE BUILDING

PROJECT NUMBER: 20267

COORDINATE WITH LOCAL GOVERNING UNIT.



EX. 1' CONTOUR ELEVATION INTERVAL

FOOTINGS AND FOUNDATIONS.

REMOVAL OF PAVEMENT AND ALL BASE MATERIAL,

REMOVE CURB AND GUTTER. IF IN RIGHT-OF-WAY,

INCLUDING BIT., CONC., AND GRAVEL PVMTS. REMOVAL OF STRUCTURE INCLUDING ALL

TREE REMOVAL - INCLUDING ROOTS AND STUMPS




**REMOVALS LEGEND:** 
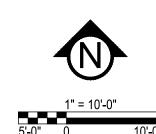
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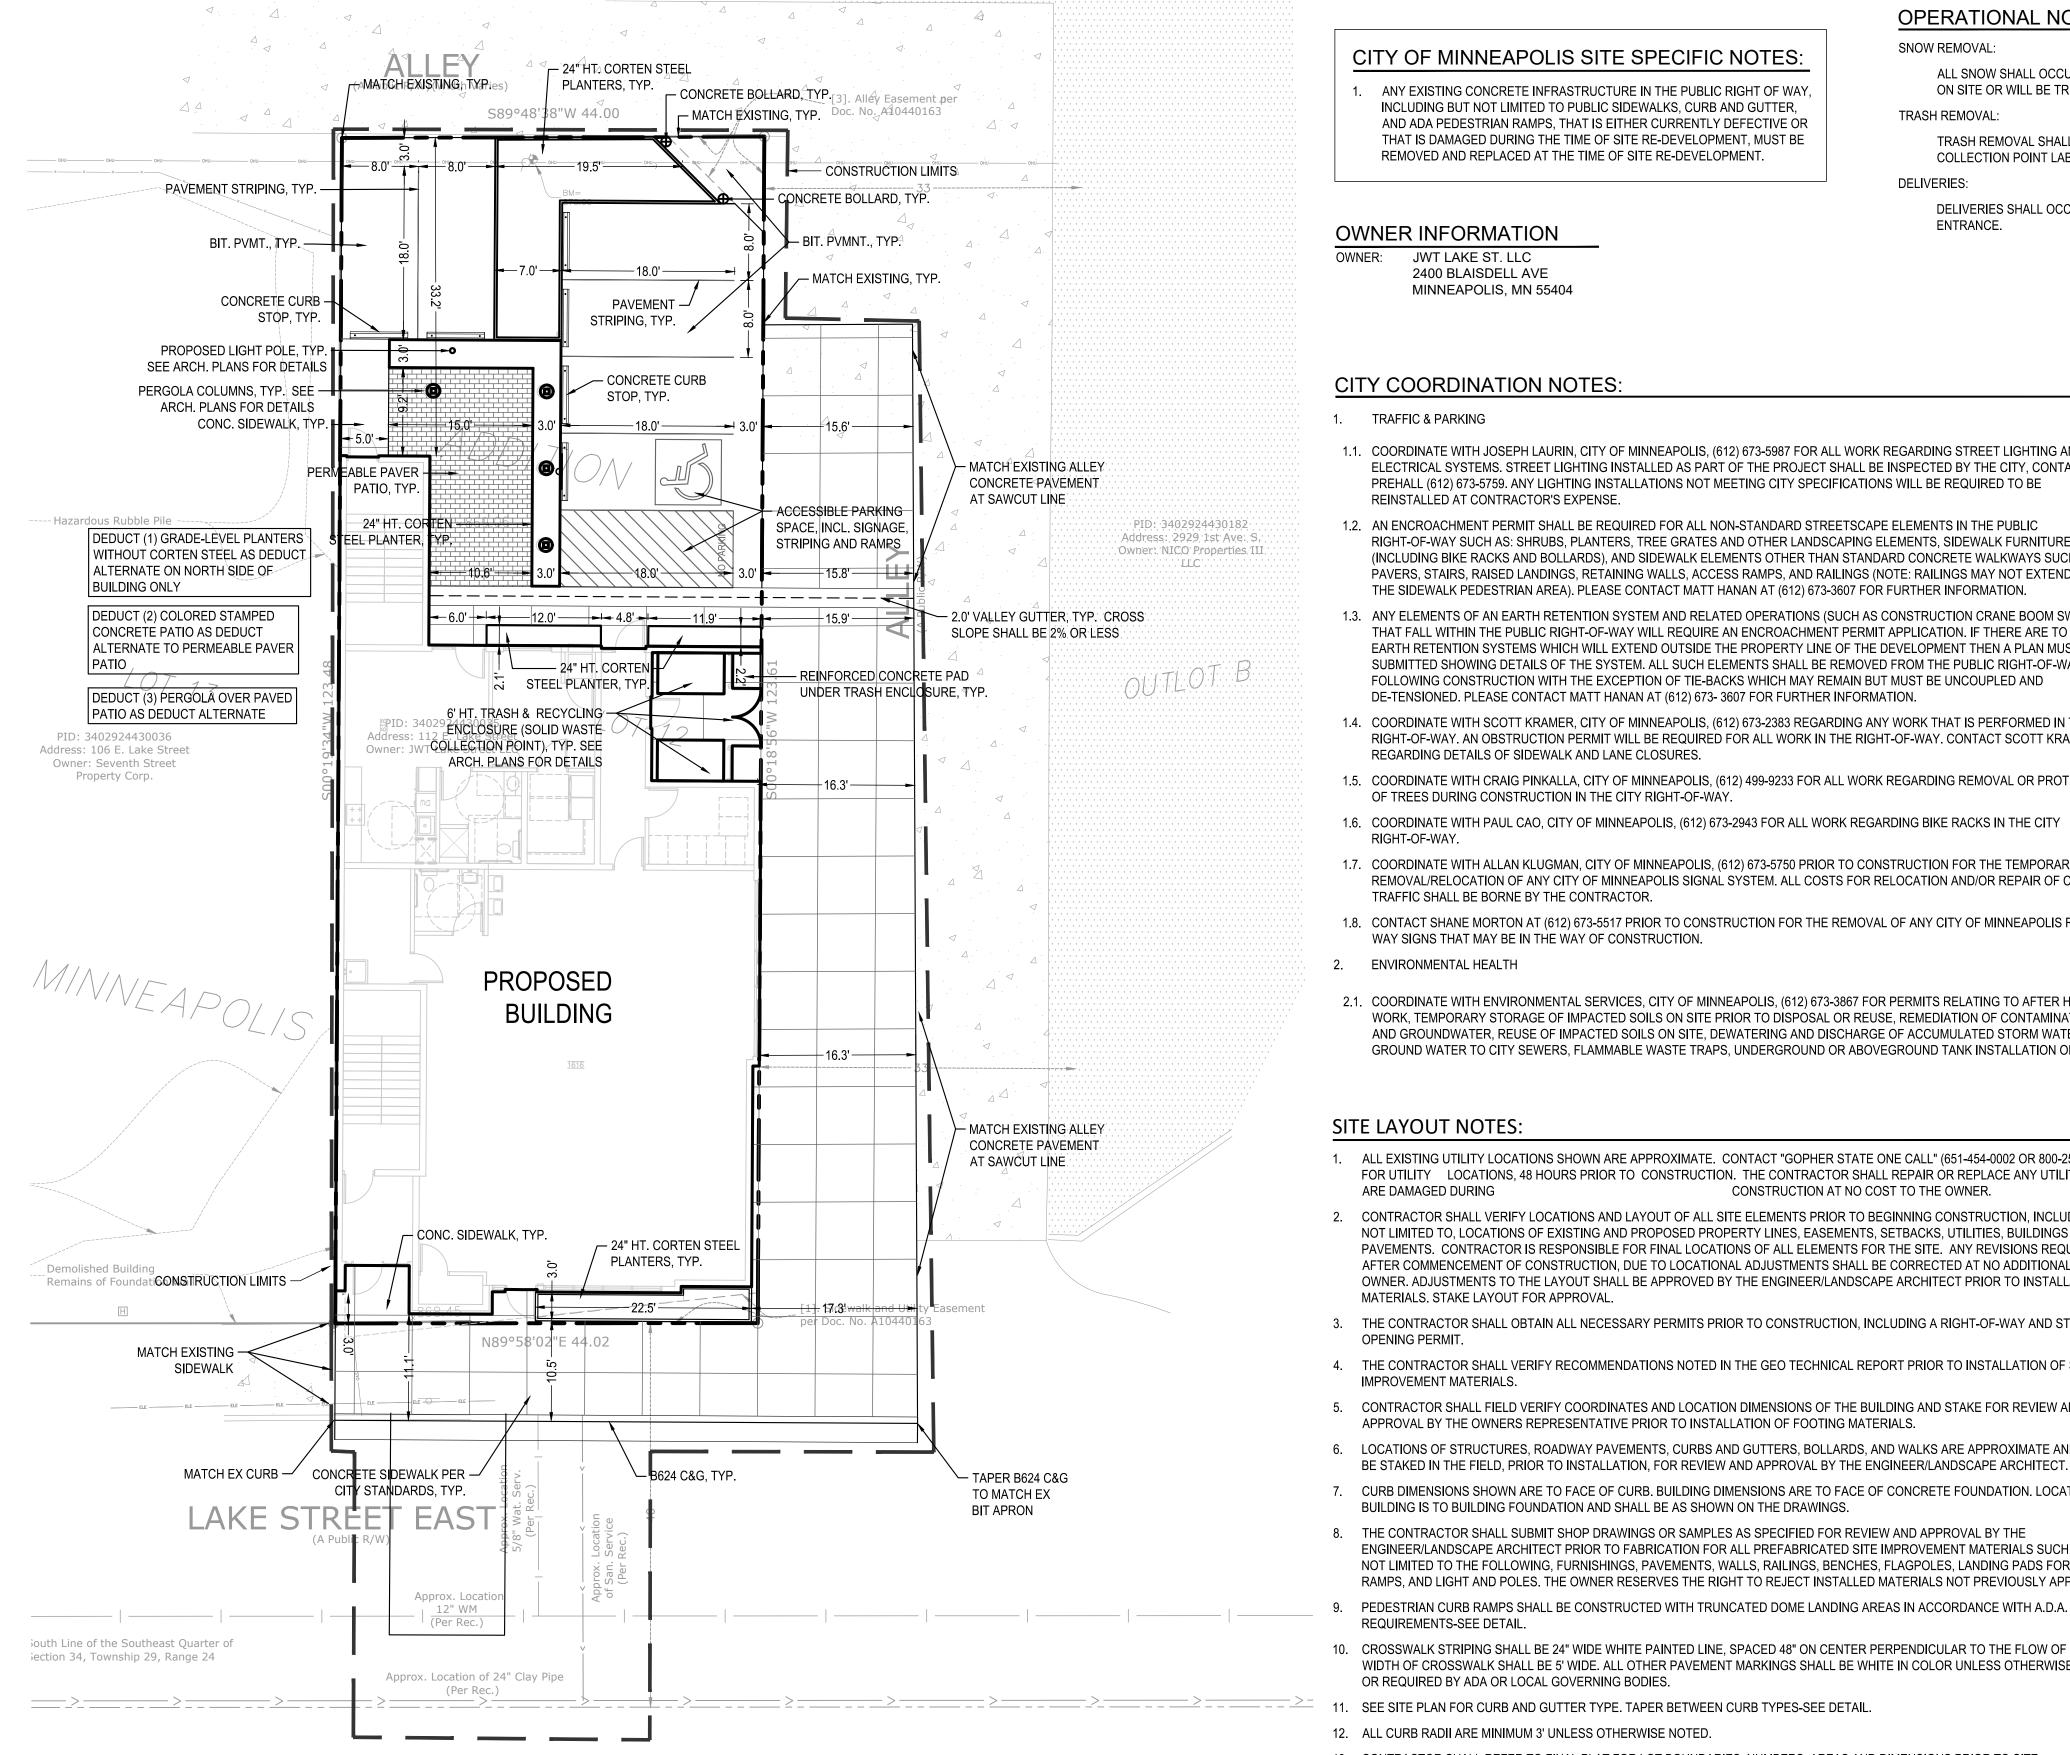
EROSION CONTROL NOTES:

SEE SWPPP ON SHEETS SW1.0 - SW1.3



DRAWN BY:KB, KW REVIEWED BY: MP **REVISION SUMMARY** DATE DESCRIPTION

REMOVALS PLAN



## CITY OF MINNEAPOLIS SITE SPECIFIC NOTES:

ANY EXISTING CONCRETE INFRASTRUCTURE IN THE PUBLIC RIGHT OF WAY, INCLUDING BUT NOT LIMITED TO PUBLIC SIDEWALKS, CURB AND GUTTER, AND ADA PEDESTRIAN RAMPS, THAT IS EITHER CURRENTLY DEFECTIVE OR THAT IS DAMAGED DURING THE TIME OF SITE RE-DEVELOPMENT, MUST BE REMOVED AND REPLACED AT THE TIME OF SITE RE-DEVELOPMENT.

TRASH REMOVAL SHALL OCCUR AT SOLID WASTE COLLECTION POINT LABELED ON SITE PLAN. DELIVERIES:

DELIVERIES SHALL OCCUR AT BUILDING MAIN

ALL SNOW SHALL OCCUR IN LANDSCAPE AREAS

ON SITE OR WILL BE TRUCKED OFF-SITE.

**OPERATIONAL NOTES:** 

SNOW REMOVAL:

TRASH REMOVAL:

ENTRANCE.

# OWNER INFORMATION

JWT LAKE ST. LLC 2400 BLAISDELL AVE MINNEAPOLIS, MN 55404

## CITY COORDINATION NOTES:

## TRAFFIC & PARKING

- 1.1. COORDINATE WITH JOSEPH LAURIN. CITY OF MINNEAPOLIS. (612) 673-5987 FOR ALL WORK REGARDING STREET LIGHTING AND ELECTRICAL SYSTEMS. STREET LIGHTING INSTALLED AS PART OF THE PROJECT SHALL BE INSPECTED BY THE CITY, CONTACT DAVE PREHALL (612) 673-5759. ANY LIGHTING INSTALLATIONS NOT MEETING CITY SPECIFICATIONS WILL BE REQUIRED TO BE REINSTALLED AT CONTRACTOR'S EXPENSE.
- 1.2. AN ENCROACHMENT PERMIT SHALL BE REQUIRED FOR ALL NON-STANDARD STREETSCAPE ELEMENTS IN THE PUBLIC RIGHT-OF-WAY SUCH AS: SHRUBS, PLANTERS, TREE GRATES AND OTHER LANDSCAPING ELEMENTS, SIDEWALK FURNITURE (INCLUDING BIKE RACKS AND BOLLARDS), AND SIDEWALK ELEMENTS OTHER THAN STANDARD CONCRETE WALKWAYS SUCH AS PAVERS, STAIRS, RAISED LANDINGS, RETAINING WALLS, ACCESS RAMPS, AND RAILINGS (NOTE: RAILINGS MAY NOT EXTEND INTO THE SIDEWALK PEDESTRIAN AREA). PLEASE CONTACT MATT HANAN AT (612) 673-3607 FOR FURTHER INFORMATION.
- 1.3. ANY ELEMENTS OF AN EARTH RETENTION SYSTEM AND RELATED OPERATIONS (SUCH AS CONSTRUCTION CRANE BOOM SWINGS) THAT FALL WITHIN THE PUBLIC RIGHT-OF-WAY WILL REQUIRE AN ENCROACHMENT PERMIT APPLICATION. IF THERE ARE TO BE ANY EARTH RETENTION SYSTEMS WHICH WILL EXTEND OUTSIDE THE PROPERTY LINE OF THE DEVELOPMENT THEN A PLAN MUST BE SUBMITTED SHOWING DETAILS OF THE SYSTEM. ALL SUCH ELEMENTS SHALL BE REMOVED FROM THE PUBLIC RIGHT-OF-WAY FOLLOWING CONSTRUCTION WITH THE EXCEPTION OF TIE-BACKS WHICH MAY REMAIN BUT MUST BE UNCOUPLED AND DE-TENSIONED. PLEASE CONTACT MATT HANAN AT (612) 673- 3607 FOR FURTHER INFORMATION.
- 1.4. COORDINATE WITH SCOTT KRAMER, CITY OF MINNEAPOLIS, (612) 673-2383 REGARDING ANY WORK THAT IS PERFORMED IN THE RIGHT-OF-WAY. AN OBSTRUCTION PERMIT WILL BE REQUIRED FOR ALL WORK IN THE RIGHT-OF-WAY. CONTACT SCOTT KRAMER REGARDING DETAILS OF SIDEWALK AND LANE CLOSURES.
- 1.5. COORDINATE WITH CRAIG PINKALLA, CITY OF MINNEAPOLIS, (612) 499-9233 FOR ALL WORK REGARDING REMOVAL OR PROTECTION OF TREES DURING CONSTRUCTION IN THE CITY RIGHT-OF-WAY.
- 1.6. COORDINATE WITH PAUL CAO, CITY OF MINNEAPOLIS, (612) 673-2943 FOR ALL WORK REGARDING BIKE RACKS IN THE CITY RIGHT-OF-WAY.
- 1.7. COORDINATE WITH ALLAN KLUGMAN, CITY OF MINNEAPOLIS, (612) 673-5750 PRIOR TO CONSTRUCTION FOR THE TEMPORARY REMOVAL/RELOCATION OF ANY CITY OF MINNEAPOLIS SIGNAL SYSTEM. ALL COSTS FOR RELOCATION AND/OR REPAIR OF CITY TRAFFIC SHALL BE BORNE BY THE CONTRACTOR.
- 1.8. CONTACT SHANE MORTON AT (612) 673-5517 PRIOR TO CONSTRUCTION FOR THE REMOVAL OF ANY CITY OF MINNEAPOLIS RIGHT OF WAY SIGNS THAT MAY BE IN THE WAY OF CONSTRUCTION.
- 2. ENVIRONMENTAL HEALTH
- 2.1. COORDINATE WITH ENVIRONMENTAL SERVICES, CITY OF MINNEAPOLIS, (612) 673-3867 FOR PERMITS RELATING TO AFTER HOURS WORK, TEMPORARY STORAGE OF IMPACTED SOILS ON SITE PRIOR TO DISPOSAL OR REUSE, REMEDIATION OF CONTAMINATED SOIL AND GROUNDWATER, REUSE OF IMPACTED SOILS ON SITE, DEWATERING AND DISCHARGE OF ACCUMULATED STORM WATER OR GROUND WATER TO CITY SEWERS. FLAMMABLE WASTE TRAPS. UNDERGROUND OR ABOVEGROUND TANK INSTALLATION OR

## **SITE LAYOUT NOTES:**

- ALL EXISTING UTILITY LOCATIONS SHOWN ARE APPROXIMATE. CONTACT "GOPHER STATE ONE CALL" (651-454-0002 OR 800-252-1166) FOR UTILITY LOCATIONS, 48 HOURS PRIOR TO CONSTRUCTION. THE CONTRACTOR SHALL REPAIR OR REPLACE ANY UTILITIES THAT ARE DAMAGED DURING CONSTRUCTION AT NO COST TO THE OWNER.
- CONTRACTOR SHALL VERIFY LOCATIONS AND LAYOUT OF ALL SITE ELEMENTS PRIOR TO BEGINNING CONSTRUCTION, INCLUDING BUT NOT LIMITED TO, LOCATIONS OF EXISTING AND PROPOSED PROPERTY LINES, EASEMENTS, SETBACKS, UTILITIES, BUILDINGS AND PAVEMENTS. CONTRACTOR IS RESPONSIBLE FOR FINAL LOCATIONS OF ALL ELEMENTS FOR THE SITE. ANY REVISIONS REQUIRED AFTER COMMENCEMENT OF CONSTRUCTION, DUE TO LOCATIONAL ADJUSTMENTS SHALL BE CORRECTED AT NO ADDITIONAL COST TO OWNER. ADJUSTMENTS TO THE LAYOUT SHALL BE APPROVED BY THE ENGINEER/LANDSCAPE ARCHITECT PRIOR TO INSTALLATION OF MATERIALS. STAKE LAYOUT FOR APPROVAL.
- 3. THE CONTRACTOR SHALL OBTAIN ALL NECESSARY PERMITS PRIOR TO CONSTRUCTION, INCLUDING A RIGHT-OF-WAY AND STREET
- 4. THE CONTRACTOR SHALL VERIFY RECOMMENDATIONS NOTED IN THE GEO TECHNICAL REPORT PRIOR TO INSTALLATION OF SITE IMPROVEMENT MATERIALS.
- 5. CONTRACTOR SHALL FIELD VERIFY COORDINATES AND LOCATION DIMENSIONS OF THE BUILDING AND STAKE FOR REVIEW AND APPROVAL BY THE OWNERS REPRESENTATIVE PRIOR TO INSTALLATION OF FOOTING MATERIALS.
- 6. LOCATIONS OF STRUCTURES, ROADWAY PAVEMENTS, CURBS AND GUTTERS, BOLLARDS, AND WALKS ARE APPROXIMATE AND SHALL
- 7. CURB DIMENSIONS SHOWN ARE TO FACE OF CURB. BUILDING DIMENSIONS ARE TO FACE OF CONCRETE FOUNDATION. LOCATION OF
- 8. THE CONTRACTOR SHALL SUBMIT SHOP DRAWINGS OR SAMPLES AS SPECIFIED FOR REVIEW AND APPROVAL BY THE ENGINEER/LANDSCAPE ARCHITECT PRIOR TO FABRICATION FOR ALL PREFABRICATED SITE IMPROVEMENT MATERIALS SUCH AS, BUT NOT LIMITED TO THE FOLLOWING, FURNISHINGS, PAVEMENTS, WALLS, RAILINGS, BENCHES, FLAGPOLES, LANDING PADS FOR CURB RAMPS, AND LIGHT AND POLES. THE OWNER RESERVES THE RIGHT TO REJECT INSTALLED MATERIALS NOT PREVIOUSLY APPROVED.
- PEDESTRIAN CURB RAMPS SHALL BE CONSTRUCTED WITH TRUNCATED DOME LANDING AREAS IN ACCORDANCE WITH A.D.A. REQUIREMENTS-SEE DETAIL.
- 10. CROSSWALK STRIPING SHALL BE 24" WIDE WHITE PAINTED LINE, SPACED 48" ON CENTER PERPENDICULAR TO THE FLOW OF TRAFFIC. WIDTH OF CROSSWALK SHALL BE 5' WIDE. ALL OTHER PAVEMENT MARKINGS SHALL BE WHITE IN COLOR UNLESS OTHERWISE NOTED OR REQUIRED BY ADA OR LOCAL GOVERNING BODIES.
- 12. ALL CURB RADII ARE MINIMUM 3' UNLESS OTHERWISE NOTED.
- 13. CONTRACTOR SHALL REFER TO FINAL PLAT FOR LOT BOUNDARIES, NUMBERS, AREAS AND DIMENSIONS PRIOR TO SITE IMPROVEMENTS.
- 14. FIELD VERIFY ALL EXISTING SITE CONDITIONS, DIMENSIONS.
- 15. PARKING IS TO BE SET PARALLEL OR PERPENDICULAR TO EXISTING BUILDING UNLESS NOTED OTHERWISE
- 16. ALL PARKING LOT PAINT STRIPPING TO BE WHITE, 4" WIDE TYP.
- 17. BITUMINOUS PAVING TO BE "LIGHT DUTY" UNLESS OTHERWISE NOTED. SEE DETAIL SHEETS FOR PAVEMENT SECTIONS.
- 18. ALL TREES THAT ARE TO REMAIN ARE TO BE PROTECTED FROM DAMAGE WITH A CONSTRUCTION FENCE AT THE DRIP LINE. SEE LANDSCAPE DOCUMENTS.
- 19. ALL EXISTING UTILITY LOCATIONS SHOWN ARE APPROXIMATE. CONTACT "GOPHER STATE ONE CALL" (651-454-0002 OR 800-252-1166) FOR UTILITY LOCATIONS, 48 HOURS PRIOR TO CONSTRUCTION. THE CONTRACTOR SHALL REPAIR OR REPLACE ANY UTILITIES THAT ARE DAMAGED DURING CONSTRUCTION AT NO COST TO THE OWNER.

REMOVAL, WELL CONSTRUCTION OR SEALING, OR ON-SITE ROCK CRUSHING.

- 2.2. NO CONSTRUCTION, DEMOLITION OR COMMERCIAL POWER MAINTENANCE EQUIPMENT SHALL BE OPERATED WITHIN THE CITY BETWEEN THE HOURS OF 6:00 PM AND 7:00 AM ON WEEKDAYS OR DURING ANY HOURS ON SATURDAYS, SUNDAYS AND STATE AND FEDERAL HOLIDAYS, EXCEPT UNDER PERMIT.
- 2.3. IF CONTAMINATED SOIL IS ENCOUNTERED, IT MUST BE REPORTED TO THE MINNESOTA DUTY OFFICER AT (651) 649-5451. PREAPPROVAL FOR REMOVAL OR REUSE MUST OCCUR FROM THE MPCA AND THE CITY OF MINNEAPOLIS.
- 2.4. IF IMPACTED SOIL IS ENCOUNTERED DURING SITE ACTIVITIES WORK WILL NEED TO STOP AND NOTIFICATION PROVIDED TO THE MN STATE DUTY OFFICER AT (615) 649-5451.
- 2.5. THE HIGHEST GROUNDWATER LEVEL EXPECTED FOR THIS SITE SHOULD BE DETERMINED AND USED IN ESTABLISHING THE LOWEST LEVEL FOR SUBGRADE STRUCTURES. IF SOIL BORINGS DEEPER THAN 15 FEET MUST BE DONE A TEMPORARY ENVIRONMENTAL WELL PERMIT MUST BE OBTAINED BY ENVIRONMENTAL SERVICES. IF DEWATERING IS REQUIRED DURING SITE CONSTRUCTION SEE BELOW FOR CITY PERMIT REQUIREMENTS. SUBGRADE STRUCTURES SHOULD BE DESIGNED TO PREVENT INFILTRATION OF GROUNDWATER WITHOUT THE NEED FOR A PERMANENT DEWATERING SYSTEM BEING INSTALLED. IF A CONTINUOUSLY OPERATING PERMANENT DEWATERING SYSTEM IS NEEDED IT MUST BE APPROVED AS PART OF THE SANITARY SEWER AND STORM DRAIN SITE PLAN APPROVAL PRIOR TO CONSTRUCTION BEGINNING.
- 2.6. NO CONSTRUCTION, DEMOLITION OR COMMERCIAL POWER MAINTENANCE EQUIPMENT SHALL BE OPERATED WITHIN THE CITY BETWEEN THE HOURS OF 6:00 P.M. AND 7:00 A.M. ON WEEKDAYS OR DURING ANY HOURS ON SATURDAYS, SUNDAYS AND STATE AND FEDERAL HOLIDAYS, EXCEPT UNDER PERMIT. CONTACT ENVIRONMENTAL SERVICES AT 612-673-3516 FOR PERMIT INFORMATION.
- 2.7. PERMITS AND APPROVAL ARE REQUIRED FROM ENVIRONMENTAL SERVICES FOR THE FOLLOWING ACTIVITIES: TEMPORARY STORAGE OF IMPACTED SOILS ON SITE PRIOR TO DISPOSAL OR REUSE; REUSE OF IMPACTED SOILS ON SITE; DEWATERING AND DISCHARGE OF ACCUMULATED STORM WATER OR GROUND WATER, UNDERGROUND OR ABOVEGROUND TANK INSTALLATION OR REMOVAL, TEMPORARY ENVIRONMENTAL WELLS, WELL CONSTRUCTION OR SEALING. CONTACT TOM FRAME AT 612-673-5807 FOR PERMIT APPLICATIONS AND
- FORESTRY DEPARTMENT
- 3.1. TO PROTECT ROOT ZONES, NO CONSTRUCTION EQUIPMENT OR MATERIALS SHALL BE PLACED, PARKED, OR STORED ON ANY UNPAVED AREA WITHIN THE DRIP LINE OF ANY CITY OWNED TREE. NO CHEMICALS OR PETROLEUM PRODUCTS SHALL BE DEPOSITED ON ANY UNPAVED AREA IN THE CITY RIGHT-OF-WAY.
- 3.2. ANY TREE ROOTS ENCOUNTERED ARE TO BE CLEANLY CUT USING HAND TOOLS.
- 3.3. NO OPEN EXCAVATION OR BORE PITS ALLOWED WITHIN 8 FEET OF CITY STREET TREES.
- 3.4. CARE SHALL BE TAKEN NOT TO DAMAGE TREE TRUNKS OR BRANCHES. CONTRACTOR MUST CONTACT FORESTRY DEPARTMENT INSPECTIONS (CRAIG PINKALLA) AT (612) 499-9233 AT LEAST 3 DAYS PRIOR TO STARTING WORK TO DISCUSS PROBLEMS OF OVERHANGING BRANCHES THAT MAY BE DAMAGED.

## **SITE AREA TABLE:**

BUILDING COVERAGE	2,265 SF	41.7%	2.973 SF	54.
			2,373 31	54.
ALL PAVEMENTS	2,660 SF	48.9%	1,695 SF	31.2
ALL NON-PAVEMENTS	512 SF	9.4%	465 SF	8.6

IMPERVIOUS SURFACE		
EXISTING CONDITION	4,925 SF	90.6%
PROPOSED CONDITION	4,668 SF	85.9%
DIFFERENCE (EX. VS PROP.)	-257 SF	-4.7%
IMPERVIOUS TOTAL	4,668 SF	85.9%

# SITE PLAN LEGEND:

GEOTECHNICAL REPORT FOR AGGREGATE BASE & WEAR COURSE DEPTH, SEE DEATIL. PROPERTY LINE

CONCRETE PAVEMENT (IF APPLICABLE) AS SPECIFIED (PAD OR WALK) SEE GEOTECHNICAL REPORT FOR AGGREGATE BASE & CONCRETE DEPTHS, SEE DETAIL.

BITUMINOUS PAVEMENT (IF APPLICABLE). SEE

CONSTRUCTION LIMITS

CURB AND GUTTER-SEE NOTES (T.O.) TIP OUT GUTTER WHERE APPLICABLE-SEE PLAN



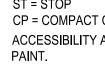
SIGN AND POST ASSEMBLY. SHOP DRAWINGS REQUIRED.

TRAFFIC DIRECTIONAL ARROW PAVEMENT MARKINGS



Know what's **below**.

HC = ACCESSIBLE SIGN NP = NO PARKING FIRE LANE ST = STOP CP = COMPACT CAR PARKING ONLY ACCESSIBILITY ARROW (IF APPLICABLE) DO NOT







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I HEREBY CERTIFY THAT THIS PLAN, SPECIFICATION, OR REPORT WAS PREPARED BY ME OR UNDER MY DIRECT SUPERVISION AND THAT I AM A DULY LICENSED PROFESSIONAL ENGINEER UNDER THE LAWS OF THE STATE OF

Matthew R. Pavek

DATE 12/14/20 LICENSE NO. 44263

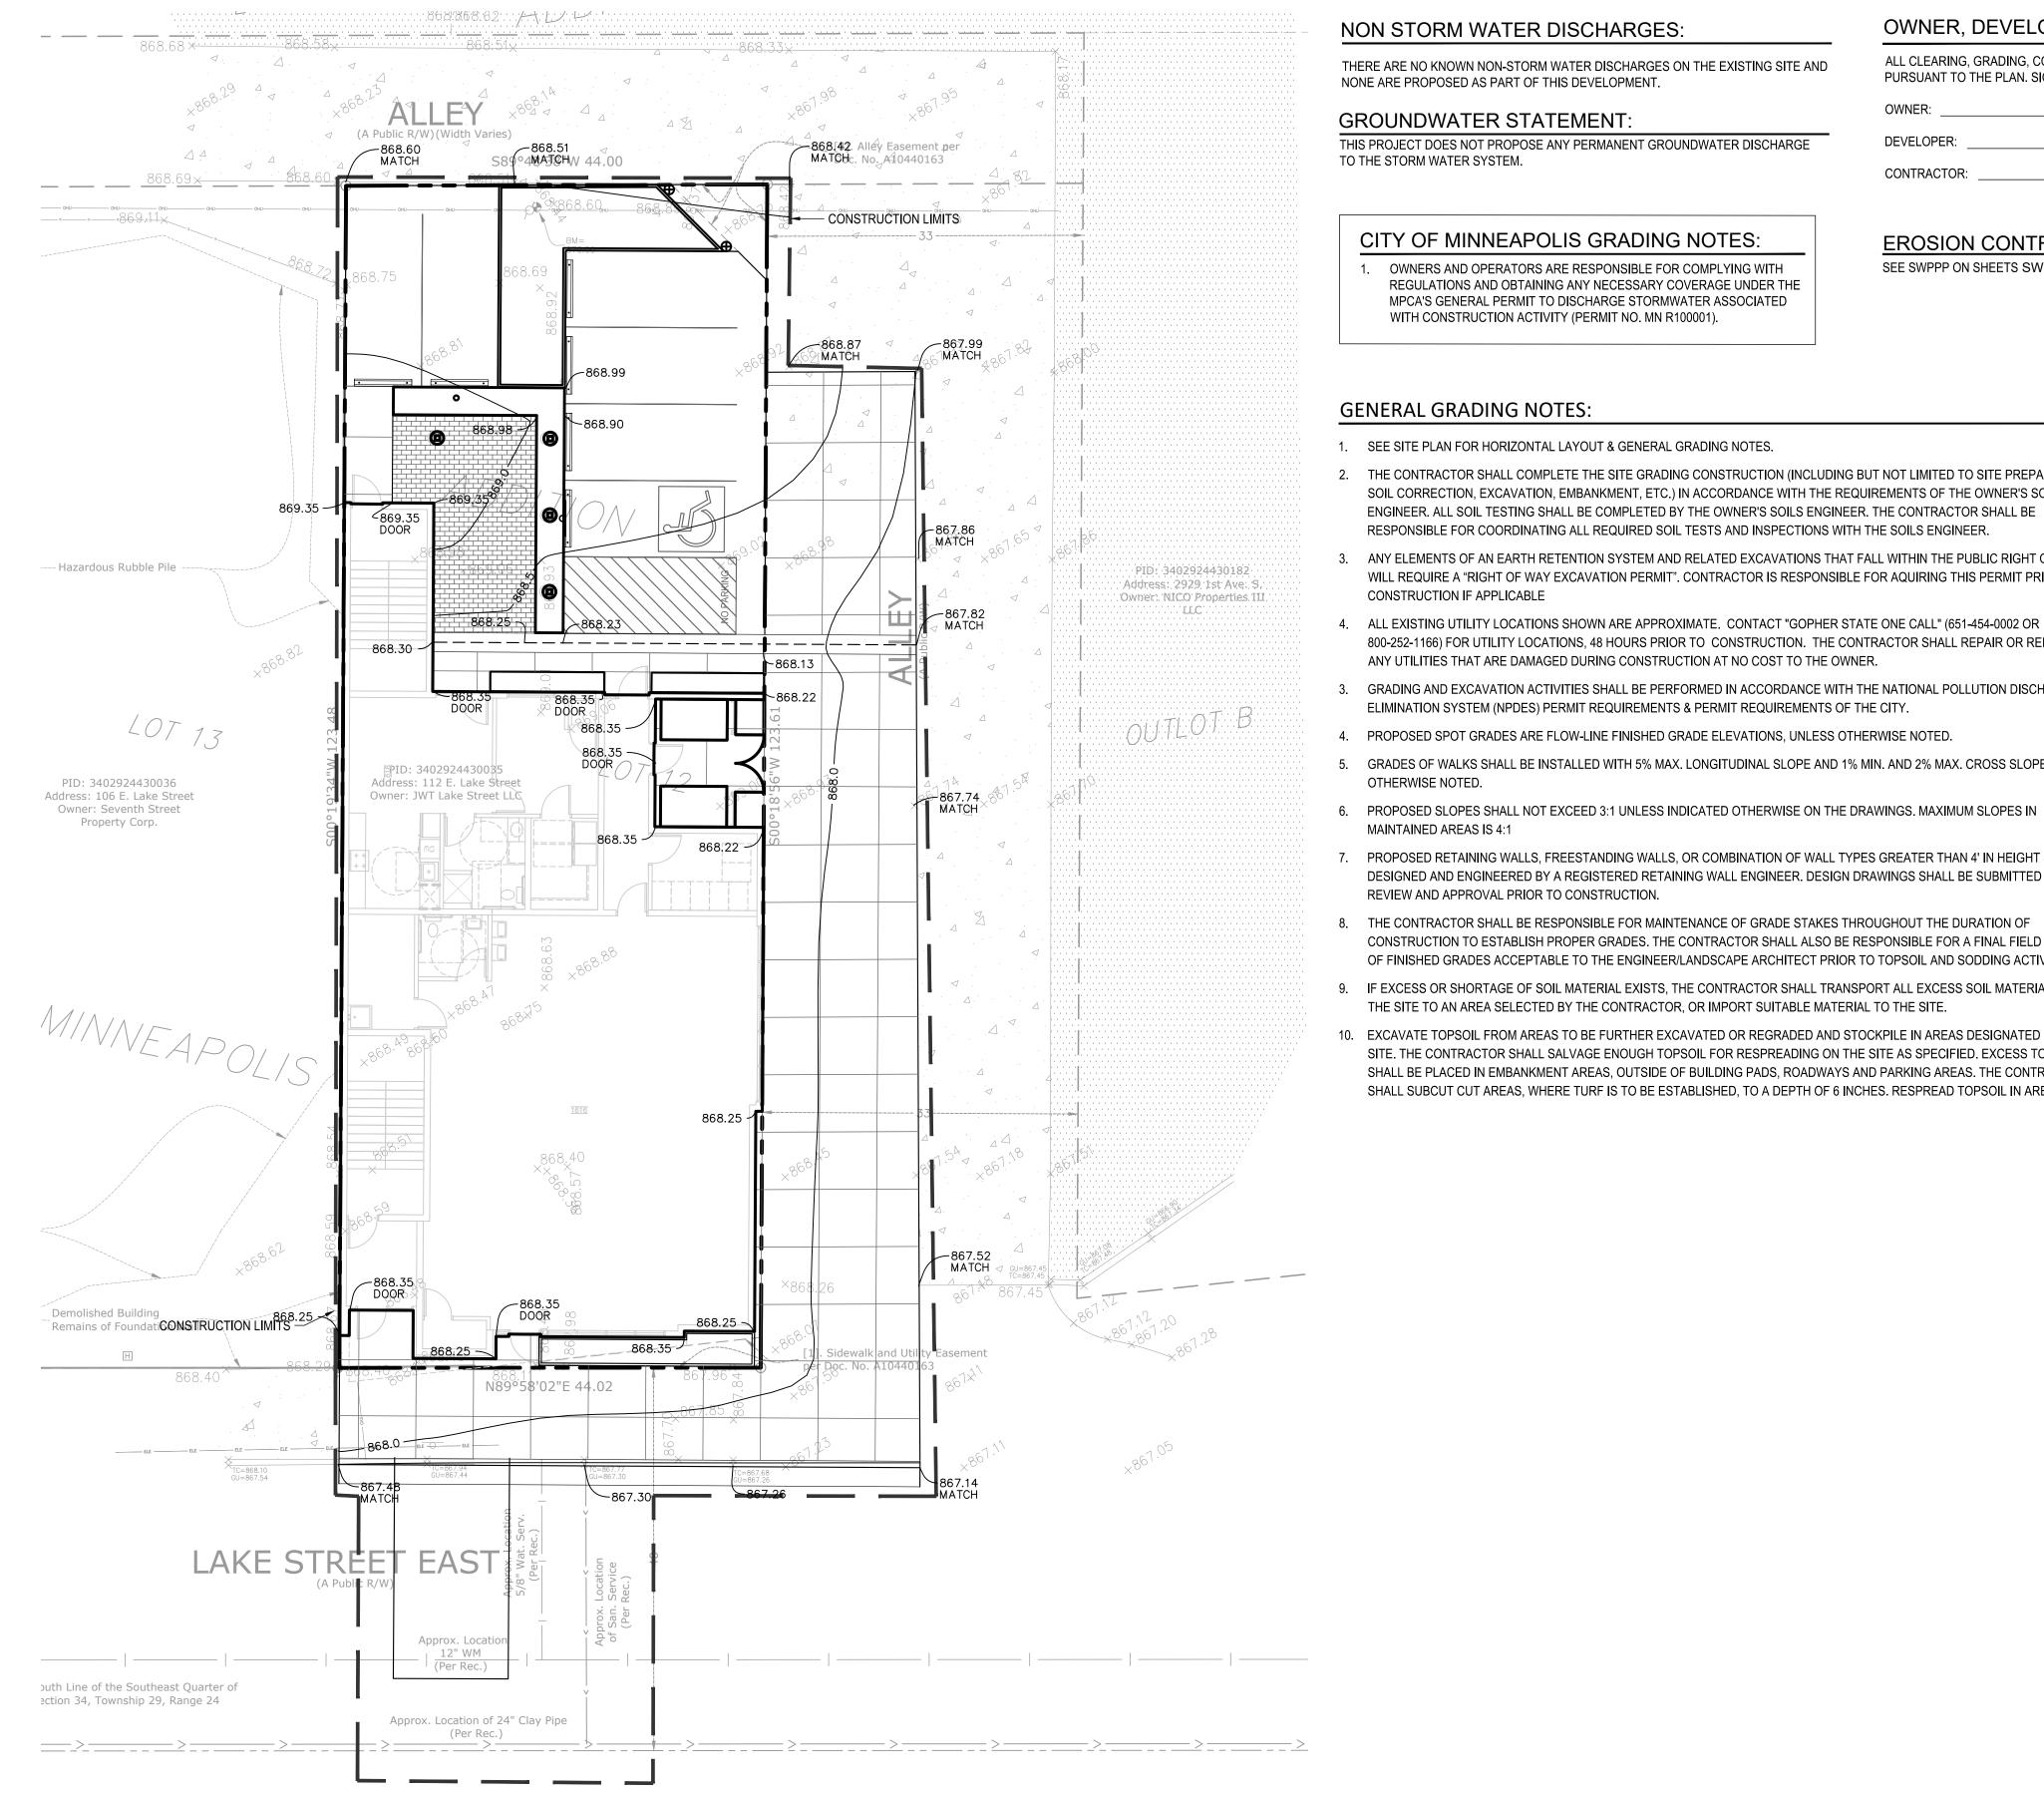
ISSUE/SUBMITTAL SUMMARY DATE DESCRIPTION 10/08/2020 PDR SUBMITTAL 10/20/20 PDR SUBMITTAL 11/02/20 PDR SUBMITTAL 12/14/20 MIXED USE BUILDING

DRAWN BY:KB. KW REVIEWED BY: MP

PROJECT NUMBER: 20267 **REVISION SUMMARY** 

DATE DESCRIPTION

SITE PLAN



#### NON STORM WATER DISCHARGES:

THERE ARE NO KNOWN NON-STORM WATER DISCHARGES ON THE EXISTING SITE AND NONE ARE PROPOSED AS PART OF THIS DEVELOPMENT.

## **GROUNDWATER STATEMENT:**

THIS PROJECT DOES NOT PROPOSE ANY PERMANENT GROUNDWATER DISCHARGE TO THE STORM WATER SYSTEM.

## CITY OF MINNEAPOLIS GRADING NOTES:

OWNERS AND OPERATORS ARE RESPONSIBLE FOR COMPLYING WITH REGULATIONS AND OBTAINING ANY NECESSARY COVERAGE UNDER THE MPCA'S GENERAL PERMIT TO DISCHARGE STORMWATER ASSOCIATED WITH CONSTRUCTION ACTIVITY (PERMIT NO. MN R100001).

### OWNER, DEVELOPER, CONTRACTOR SIGNED STATEMENT

ALL CLEARING, GRADING, CONSTRUCTION OR DEVELOPMENT WILL BE DONE PURSUANT TO THE PLAN. SIGNED BY PARTIES BELOW: CONTRACTOR:

**EROSION CONTROL NOTES:** 

# SEE SWPPP ON SHEETS SW1.0 - SW1.3

## **GENERAL GRADING NOTES:**

- 1. SEE SITE PLAN FOR HORIZONTAL LAYOUT & GENERAL GRADING NOTES.
- 2. THE CONTRACTOR SHALL COMPLETE THE SITE GRADING CONSTRUCTION (INCLUDING BUT NOT LIMITED TO SITE PREPARATION, SOIL CORRECTION, EXCAVATION, EMBANKMENT, ETC.) IN ACCORDANCE WITH THE REQUIREMENTS OF THE OWNER'S SOILS ENGINEER. ALL SOIL TESTING SHALL BE COMPLETED BY THE OWNER'S SOILS ENGINEER. THE CONTRACTOR SHALL BE RESPONSIBLE FOR COORDINATING ALL REQUIRED SOIL TESTS AND INSPECTIONS WITH THE SOILS ENGINEER.
- 3. ANY ELEMENTS OF AN EARTH RETENTION SYSTEM AND RELATED EXCAVATIONS THAT FALL WITHIN THE PUBLIC RIGHT OF WAY WILL REQUIRE A "RIGHT OF WAY EXCAVATION PERMIT". CONTRACTOR IS RESPONSIBLE FOR AQUIRING THIS PERMIT PRIOR TO CONSTRUCTION IF APPLICABLE
- 800-252-1166) FOR UTILITY LOCATIONS, 48 HOURS PRIOR TO CONSTRUCTION. THE CONTRACTOR SHALL REPAIR OR REPLACE ANY UTILITIES THAT ARE DAMAGED DURING CONSTRUCTION AT NO COST TO THE OWNER.
- 3. GRADING AND EXCAVATION ACTIVITIES SHALL BE PERFORMED IN ACCORDANCE WITH THE NATIONAL POLLUTION DISCHARGE ELIMINATION SYSTEM (NPDES) PERMIT REQUIREMENTS & PERMIT REQUIREMENTS OF THE CITY.
- 4. PROPOSED SPOT GRADES ARE FLOW-LINE FINISHED GRADE ELEVATIONS, UNLESS OTHERWISE NOTED.
- 5. GRADES OF WALKS SHALL BE INSTALLED WITH 5% MAX. LONGITUDINAL SLOPE AND 1% MIN. AND 2% MAX. CROSS SLOPE, UNLESS
- 6. PROPOSED SLOPES SHALL NOT EXCEED 3:1 UNLESS INDICATED OTHERWISE ON THE DRAWINGS. MAXIMUM SLOPES IN MAINTAINED AREAS IS 4:1
- 7. PROPOSED RETAINING WALLS, FREESTANDING WALLS, OR COMBINATION OF WALL TYPES GREATER THAN 4' IN HEIGHT SHALL BE DESIGNED AND ENGINEERED BY A REGISTERED RETAINING WALL ENGINEER. DESIGN DRAWINGS SHALL BE SUBMITTED FOR REVIEW AND APPROVAL PRIOR TO CONSTRUCTION.
- 8. THE CONTRACTOR SHALL BE RESPONSIBLE FOR MAINTENANCE OF GRADE STAKES THROUGHOUT THE DURATION OF CONSTRUCTION TO ESTABLISH PROPER GRADES. THE CONTRACTOR SHALL ALSO BE RESPONSIBLE FOR A FINAL FIELD CHECK OF FINISHED GRADES ACCEPTABLE TO THE ENGINEER/LANDSCAPE ARCHITECT PRIOR TO TOPSOIL AND SODDING ACTIVITIES.
- 9. IF EXCESS OR SHORTAGE OF SOIL MATERIAL EXISTS, THE CONTRACTOR SHALL TRANSPORT ALL EXCESS SOIL MATERIAL OFF THE SITE TO AN AREA SELECTED BY THE CONTRACTOR, OR IMPORT SUITABLE MATERIAL TO THE SITE.
- 10. EXCAVATE TOPSOIL FROM AREAS TO BE FURTHER EXCAVATED OR REGRADED AND STOCKPILE IN AREAS DESIGNATED ON THE SITE. THE CONTRACTOR SHALL SALVAGE ENOUGH TOPSOIL FOR RESPREADING ON THE SITE AS SPECIFIED. EXCESS TOPSOIL SHALL BE PLACED IN EMBANKMENT AREAS, OUTSIDE OF BUILDING PADS, ROADWAYS AND PARKING AREAS. THE CONTRACTOR SHALL SUBCUT CUT AREAS, WHERE TURF IS TO BE ESTABLISHED, TO A DEPTH OF 6 INCHES. RESPREAD TOPSOIL IN AREAS

- WHERE TURF IS TO BE ESTABLISHED TO A MINIMUM DEPTH OF 6 INCHES.
- FINISHED GRADING SHALL BE COMPLETED. THE CONTRACTOR SHALL UNIFORMLY GRADE AREAS WITHIN LIMITS OF GRADING. INCLUDING ADJACENT TRANSITION AREAS. PROVIDE A SMOOTH FINISHED SURFACE WITHIN SPECIFIED TOLERANCES, WITH UNIFORM LEVELS OR SLOPES BETWEEN POINTS WHERE ELEVATIONS ARE SHOWN, OR BETWEEN SUCH POINTS AND EXISTING GRADES. AREAS THAT HAVE BEEN FINISH GRADED SHALL BE PROTECTED FROM SUBSEQUENT CONSTRUCTION OPERATIONS, TRAFFIC AND EROSION. REPAIR ALL AREAS THAT HAVE BECOME RUTTED BY TRAFFIC OR ERODED BY WATER OR HAS SETTLED BELOW THE CORRECT GRADE. ALL AREAS DISTURBED BY THE CONTRACTOR'S OPERATIONS SHALL BE RESTORED TO EQUAL OR BETTER THAN ORIGINAL CONDITION OR TO THE REQUIREMENTS OF THE NEW WORK.
- 12. PRIOR TO PLACEMENT OF THE AGGREGATE BASE, A TEST ROLL WILL BE REQUIRED ON THE STREET AND/OR PARKING AREA SUBGRADE. THE CONTRACTOR SHALL PROVIDE A LOADED TANDEM AXLE TRUCK WITH A GROSS WEIGHT OF 25 TONS. THE TEST ROLLING SHALL BE AT THE DIRECTION OF THE SOILS ENGINEER AND SHALL BE COMPLETED IN AREAS AS DIRECTED BY THE SOILS ENGINEER. THE SOILS ENGINEER SHALL DETERMINE WHICH SECTIONS OF THE STREET OR PARKING AREA ARE UNSTABLE. CORRECTION OF THE SUBGRADE SOILS SHALL BE COMPLETED IN ACCORDANCE WITH THE REQUIREMENTS OF THE SOILS ENGINEER. NO TEST ROLL SHALL OCCUR WITHIN 10' OF ANY UNDERGROUND STORM RETENTION/DETENTION SYSTEMS.
- 13. TOLERANCES
- 13.1. THE BUILDING SUBGRADE FINISHED SURFACE ELEVATION SHALL NOT VARY BY MORE THAN 0.30 FOOT ABOVE, OR 0.30 FOOT BELOW, THE PRESCRIBED ELEVATION AT ANY POINT WHERE MEASUREMENT IS MADE.
  - 13.2. THE STREET OR PARKING AREA SUBGRADE FINISHED SURFACE ELEVATION SHALL NOT VARY BY MORE THAN 0.05 FOOT ABOVE, OR 0.10 FOOT BELOW, THE PRESCRIBED ELEVATION OF ANY POINT WHERE MEASUREMENT IS MADE.
  - 13.3. AREAS WHICH ARE TO RECEIVE TOPSOIL SHALL BE GRADED TO WITHIN 0.30 FOOT ABOVE OR BELOW THE REQUIRED ELEVATION, UNLESS DIRECTED OTHERWISE BY THE ENGINEER.
  - 13.4. TOPSOIL SHALL BE GRADED TO PLUS OR MINUS 1/2 INCH OF THE SPECIFIED THICKNESS.
- 14. MAINTENANCE
- 14.1. THE CONTRACTOR SHALL PROTECT NEWLY GRADED AREAS FROM TRAFFIC AND EROSION, AND KEEP AREA FREE OF TRASH AND DEBRIS.
- 14.2. CONTRACTOR SHALL REPAIR AND REESTABLISH GRADES IN SETTLED, ERODED AND RUTTED AREAS TO SPECIFIED TOLERANCES. DURING THE CONSTRUCTION, IF REQUIRED, AND DURING THE WARRANTY PERIOD, ERODED AREAS WHERE TURF IS TO BE ESTABLISHED SHALL BE RESEEDED AND MULCHED.
- 14.3. WHERE COMPLETED COMPACTED AREAS ARE DISTURBED BY SUBSEQUENT CONSTRUCTION OPERATIONS OR ADVERSE WEATHER, CONTRACTOR SHALL SCARIFY, SURFACE, RESHAPE, AND COMPACT TO REQUIRED DENSITY PRIOR TO FURTHER CONSTRUCTION.

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I HEREBY CERTIFY THAT THIS PLAN, SPECIFICATION, OR REPORT WAS PREPARED BY ME OR UNDER MY DIRECT SUPERVISION AND THAT I AM A DULY LICENSED PROFESSIONAL ENGINEER UNDER THE LAWS OF THE STATE OF

Matthew R. Pavek

DATE 12/14/20 LICENSE NO. 44263 ISSUE/SUBMITTAL SUMMARY

DATE DESCRIPTION 10/08/2020 PDR SUBMITTAL 10/20/20 PDR SUBMITTAL 11/02/20 PDR SUBMITTAL 12/14/20 MIXED USE BUILDING

DRAWN BY:KB, KW REVIEWED BY: MP PROJECT NUMBER: 20267 REVISION SUMMARY

**GRADING PLAN** 

DATE DESCRIPTION

12/11/2020 3:27 PM

CURB AND GUTTER (T.O = TIP OUT) EOF=1135.52

**GRADING PLAN LEGEND:** 

41.26

891.00 G

891.00 TC

891.00 BS/TS

891.00 ME

**EMERGENCY OVERFLOW** 

EX. 1' CONTOUR ELEVATION INTERVAL

SPOT GRADE ELEVATION (GUTTER/FLOW LINE

SPOT GRADE ELEVATION BOTTOM OF STAIRS/TOP OF STAIRS

1.0' CONTOUR ELEVATION INTERVAL

SPOT GRADE ELEVATION GUTTER

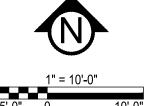
SPOT GRADE ELEVATION TOP OF CURB

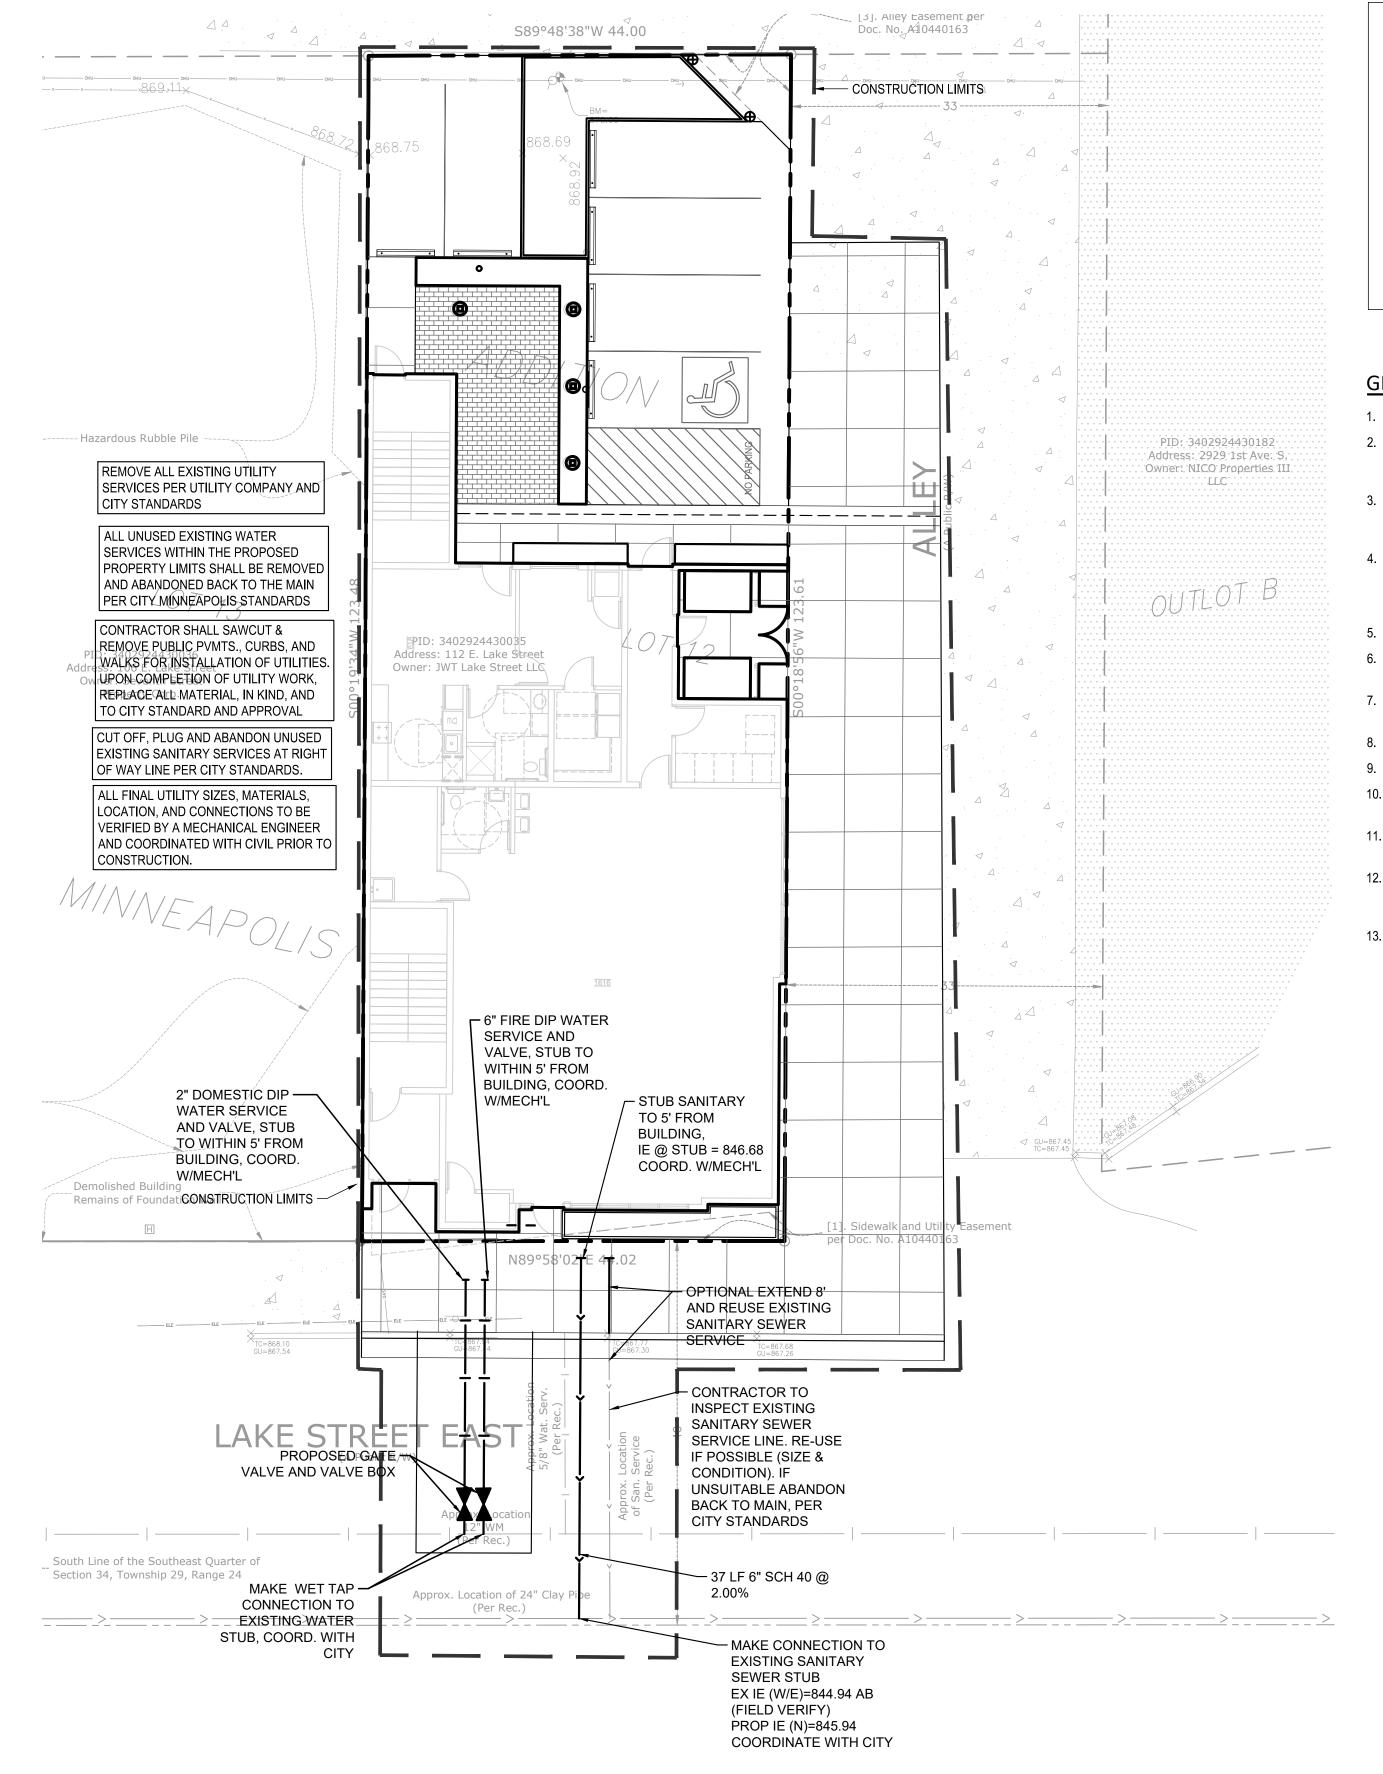
SPOT GRADE ELEVATION MATCH EXISTING

UNLESS OTHERWISE NOTED)

GRADE BREAK - HIGH POINTS







## CITY OF MINNEAPOLIS UTILITY NOTES:

- 1. FOR COMMENTS OR QUESTIONS ON PUBLIC WORKS SURFACE WATER & SEWER DIVISION RELATED REQUIREMENTS PLEASE CONTACT JEREMY STREHLO, (PROFESSIONAL ENGINEER) AT (612) 673-3973, OR JEREMY.STREHLO@MINNEAPOLISMN.GOV
- THE CITY OF MINNEAPOLIS WATER TREATMENT & DISTRIBUTION SERVICES DIVISION (WTDS) REQUIRES THAT POTABLE WATER SUPPLY SERVICE LINES SHALL BE SIZED BASED UPON THE TOTAL DEMAND AND SHALL BE DETERMINED IN ACCORDANCE WITH RECOGNIZED ENGINEERING METHODS AND PROCEDURES. THE APPLICANT (AND ENGINEER) SHALL BE RESPONSIBLE FOR DESIGNING POTABLE WATER SYSTEMS THAT ARE NOT OVERSIZED FOR THEIR INTENDED USE SO THAT TURNOVER IS SUFFICIENT TO MAINTAIN WATER QUALITY. PLEASE CONTACT ROCK ROGERS AT (612) 673-2286, TO CONFIRM DOMESTIC AND FIRE SERVICE DESIGN, CONNECTIONS, AND SIZES. THE APPLICANT SHALL PROVIDE A CONFIRMATION OF DOMESTIC AND FIRE SERVICE DESIGN METHODS BEFORE SITE PLAN APPROVAL CAN BE GRANTED. (NOTE: REFERS TO THE REQUIREMENT THAT LINES BE SIZED AND INCLUDE MECHANICAL ENGINEER CALCULATIONS).
- 3. THE CONTRACTOR, PROPERTY OWNER OR RESPONSIBLE PARTY SHALL CONTACT MINNEAPOLIS SURFACE WATERS AND SEWERS 48 HOURS PRIOR TO ANY EXCAVATION OR CONSTRUCTION RELATED TO OR IN THE LOCATION OF THE PROPOSED STORMWATER MANAGEMENT BMP (CONTACT PAUL CHELLSEN 612-673-2406).
- 4. UPON THE PROJECTS COMPLETION, THE GENERAL CONTRACTOR, PROPERTY OWNER, OR RESPONSIBLE PARTY SHALL PROVIDE TO THE DEPARTMENT OF PUBLIC WORKS A FINAL STORMWATER MANAGEMENT REPORT INCLUDING RECORD DRAWINGS. THIS REPORT WILL SERVE AS A MEANS OF VERIFICATION THAT THE INTENT OF THE APPROVED STORMWATER MANAGEMENT DESIGN HAS BEEN MET. THIS FINAL REPORT SHALL SUBSTANTIATE THAT ALL ASPECTS OF THE ORIGINAL DESIGN HAVE BEEN ADEQUATELY PROVIDED FOR BY THE CONSTRUCTION OF THE PROJECT.

## **GENERAL UTILITY NOTES:**

- 1. SEE SITE PLAN FOR HORIZONTAL DIMENSIONS AND LAYOUT.
- 2. CONTRACTOR SHALL FIELD VERIFY LOCATION AND ELEVATION OF EXISTING UTILITIES AND TOPOGRAPHIC FEATURES PRIOR TO CONSTRUCTION. THE CONTRACTOR SHALL IMMEDIATELY NOTIFY THE ENGINEER OF DISCREPANCIES OR VARIATIONS FROM THE PLANS.
- ALL EXISTING UTILITY LOCATIONS SHOWN ARE APPROXIMATE. CONTACT "GOPHER STATE ONE CALL" (651-454-0002 OR 800-252-1166) FOR UTILITY LOCATIONS, 48 HOURS PRIOR TO CONSTRUCTION. THE CONTRACTOR SHALL REPAIR OR REPLACE ANY UTILITIES THAT ARE DAMAGED DURING CONSTRUCTION AT NO COST TO THE OWNER.
- 4. UTILITY INSTALLATION SHALL CONFORM TO THE CURRENT EDITION OF "STANDARD SPECIFICATIONS FOR WATER MAIN AND SERVICE LINE INSTALLATION" AND "SANITARY SEWER AND STORM SEWER INSTALLATION" AS PREPARED BY THE CITY ENGINEERS ASSOCIATION OF MINNESOTA (CEAM), AND SHALL CONFORM WITH THE REQUIREMENTS OF THE CITY AND THE PROJECT SPECIFICATIONS.
- 5. CASTINGS SHALL BE SALVAGED FROM STRUCTURE REMOVALS AND RE-USED OR PLACED AT THE DIRECTION OF THE OWNER.
- 6. ALL WATER PIPE SHALL BE CLASS 52 DUCTILE IRON PIPE (DIP) AWWA C151, ASME B16.4, AWWA C110, AWWA C153 UNLESS OTHERWISE NOTED.
- 7. ALL SANITARY SEWER SHALL BE SDR 26 POLYVINYL CHLORIDE (PVC) ASTM D3034 & F679, OR SCH 40 ASTM D1785, 2665, ASTM F794, 1866) UNLESS OTHERWISE NOTED.
- 8. ALL STORM SEWER PIPE SHALL BE HDPE ASTM F714 & F2306 WITH ASTM D3212 SPEC FITTINGS UNLESS OTHERWISE NOTED.
- 9. PIPE LENGTHS SHOWN ARE FROM CENTER TO CENTER OF STRUCTURE OR TO END OF FLARED END SECTION.
- 10. UTILITIES ON THE PLAN ARE SHOWN TO WITHIN 5' OF THE BUILDING FOOTPRINT. THE CONTRACTOR IS ULTIMATELY
- RESPONSIBLE FOR THE FINAL CONNECTION TO BUILDING LINES. COORDINATE WITH ARCHITECTURAL AND MECHANICAL PLANS.

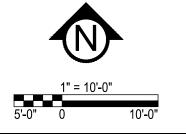
  11. CATCH BASINS AND MANHOLES IN PAVED AREAS SHALL BE SUMPED 0.04 FEET. ALL CATCH BASINS IN GUTTERS SHALL BE
- SUMPED 0.15 FEET PER DETAILS. RIM ELEVATIONS SHOWN ON THIS PLAN DO NOT REFLECT SUMPED ELEVATIONS.
- 12. A MINIMUM OF 8 FEET OF COVER IS REQUIRED OVER ALL WATERMAIN, UNLESS OTHERWISE NOTED. EXTRA DEPTH MAY BE REQUIRED TO MAINTAIN A MINIMUM OF 18" VERTICAL SEPARATION TO SANITARY OR STORM SEWER LINES. EXTRA DEPTH WATERMAIN IS INCIDENTAL.
- 13. A MINIMUM OF 18 INCHES OF VERTICAL SEPARATION AND 10 FEET OF HORIZONTAL SEPARATION IS REQUIRED FOR ALL

- UTILITIES, UNLESS OTHERWISE NOTED.
- 14. ALL CONNECTIONS TO EXISTING UTILITIES SHALL BE IN ACCORDANCE WITH CITY STANDARDS AND COORDINATED WITH THE CITY PRIOR TO CONSTRUCTION.
- 15. CONNECTIONS TO EXISTING STRUCTURES SHALL BE CORE-DRILLED.
- 16. COORDINATE LOCATIONS AND SIZES OF SERVICE CONNECTIONS WITH THE MECHANICAL DRAWINGS.
- 17. COORDINATE INSTALLATION AND SCHEDULING OF THE INSTALLATION OF UTILITIES WITH ADJACENT CONTRACTORS AND CITY STAFF.
- 18. ALL STREET REPAIRS AND PATCHING SHALL BE PERFORMED PER THE REQUIREMENTS OF THE CITY. ALL PAVEMENT CONNECTIONS SHALL BE SAWCUT. ALL TRAFFIC CONTROLS SHALL BE PROVIDED BY THE CONTRACTOR AND SHALL BE ESTABLISHED PER THE REQUIREMENTS OF THE MINNESOTA MANUAL ON UNIFORM TRAFFIC CONTROL DEVICES (MMUTCD) AND THE CITY. THIS SHALL INCLUDE BUT NOT BE LIMITED TO SIGNAGE, BARRICADES, FLASHERS, AND FLAGGERS AS NEEDED. ALL PUBLIC STREETS SHALL BE OPEN TO TRAFFIC AT ALL TIMES. NO ROAD CLOSURES SHALL BE PERMITTED WITHOUT APPROVAL BY THE CITY.
- 19. ALL STRUCTURES, PUBLIC AND PRIVATE, SHALL BE ADJUSTED TO PROPOSED GRADES WHERE REQUIRED. THE REQUIREMENTS OF ALL OWNERS MUST BE COMPLIED WITH. STRUCTURES BEING RESET TO PAVED AREAS MUST MEET OWNERS REQUIREMENTS FOR TRAFFIC LOADING.
- 20. CONTRACTOR SHALL COORDINATE ALL WORK WITH PRIVATE UTILITY COMPANIES.
- 21. CONTRACTOR SHALL COORDINATE CONNECTION OF IRRIGATION SERVICE TO UTILITIES. COORDINATE THE INSTALLATION OF IRRIGATION SLEEVES NECESSARY AS TO NOT IMPACT INSTALLATION OF UTILITIES.
- 22. CONTRACTOR SHALL MAINTAIN AS-BUILT PLANS THROUGHOUT CONSTRUCTION AND SUBMIT THESE PLANS TO ENGINEER UPON COMPLETION OF WORK.
- 23. ALL JOINTS AND CONNECTIONS IN STORM SEWER SYSTEM SHALL BE GASTIGHT OR WATERTIGHT. APPROVED RESILIENT RUBBER JOINTS MUST BE USED TO MAKE WATERTIGHT CONNECTIONS TO MANHOLES, CATCHBASINS, OR OTHER STRUCTURES.
- 24. ALL PORTIONS OF THE STORM SEWER SYSTEM LOCATED WITHIN 10 FEET OF THE BUILDING OR WATER SERVICE LINE MUST BE TESTED IN ACCORDANCE WITH MN RULES, CHAPTER 4714, SECTION 1109.0.

**UTILITY LEGEND:** 

	CATCH BASIN
	MANHOLE
$\bowtie$	GATE VALVE AND VALVE BOX
<b>-</b>	PROPOSED FIRE HYDRANT
	WATER MAIN
<del>&gt;</del>	SANITARY SEWER
<del>&gt;&gt;</del>	STORM SEWER
	FES AND RIP RAP





12/11/2020 3:27 PM

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LAKE STREET, MINNEAPOLIS, MN

IGHT PIXEL DESIGN

DHNSON CIRCLE, ST. PETER, MN 56082

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Matthew R. Pavek

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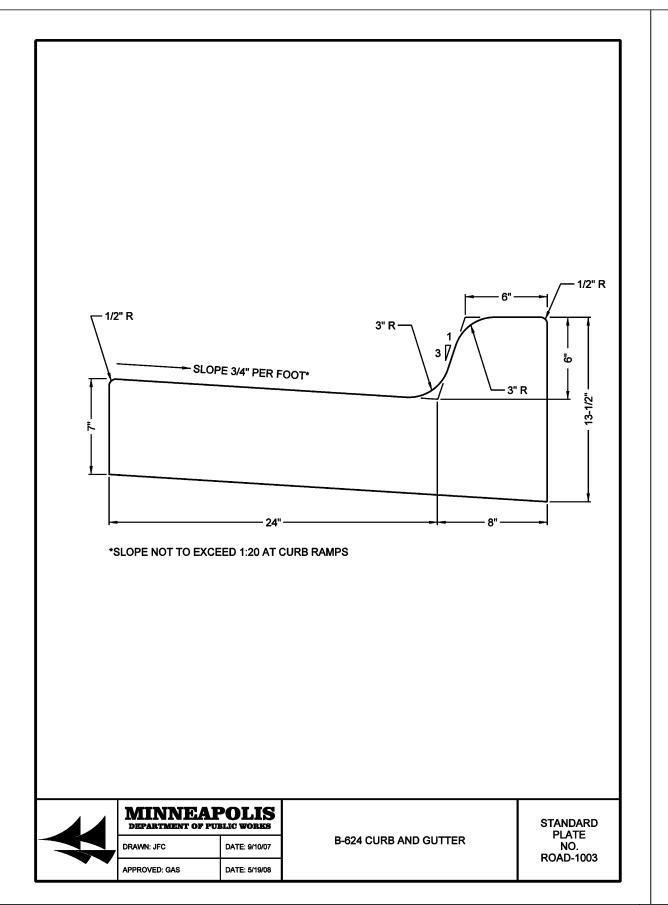
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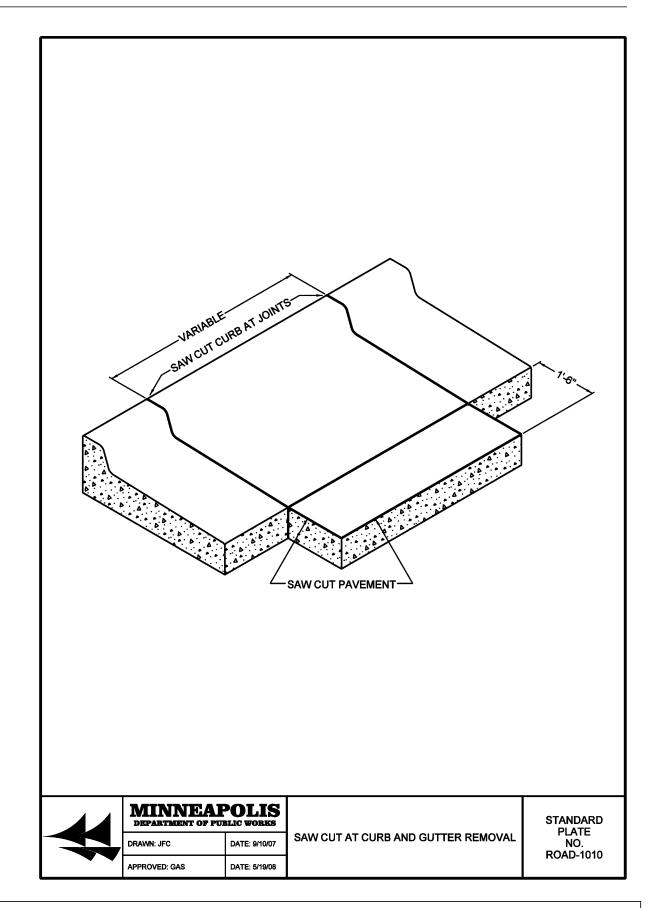
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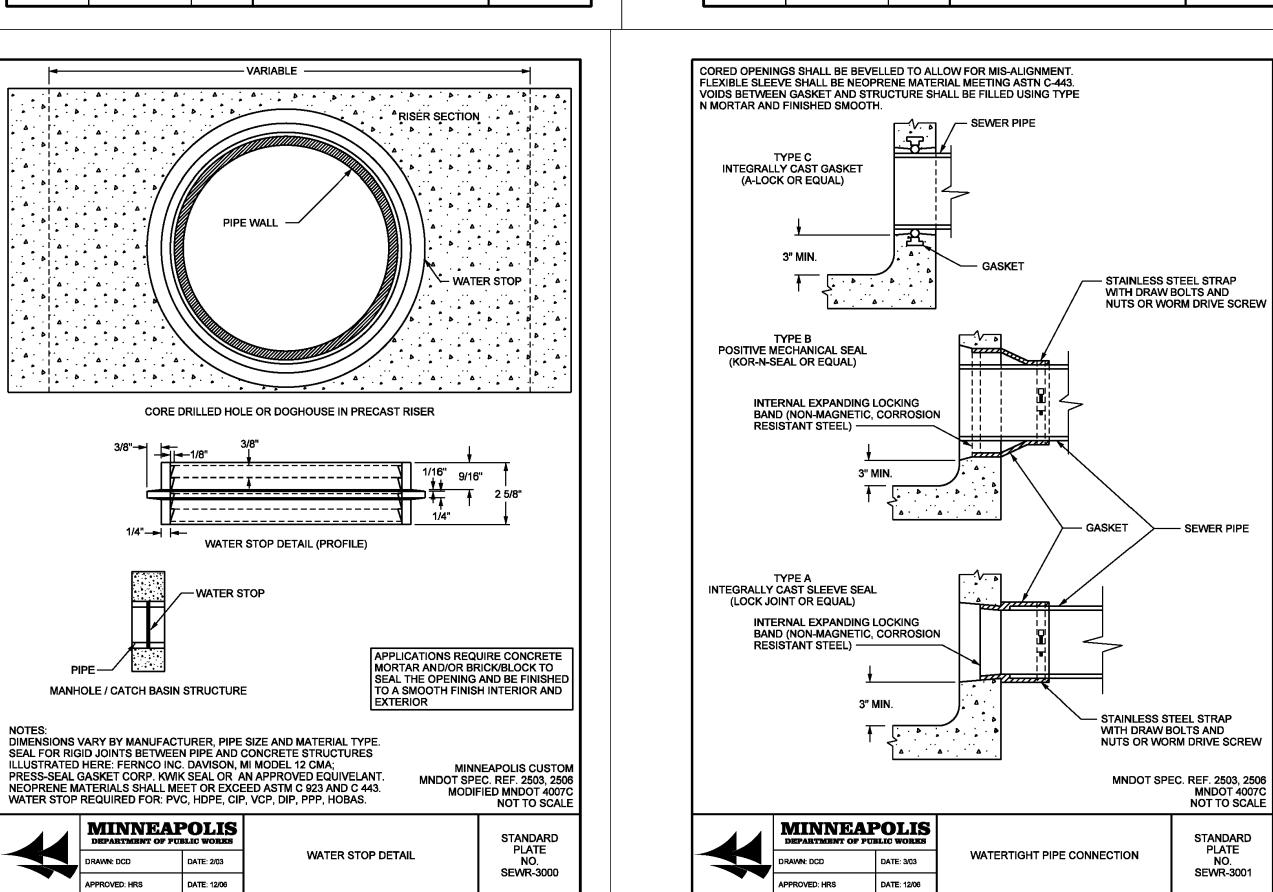
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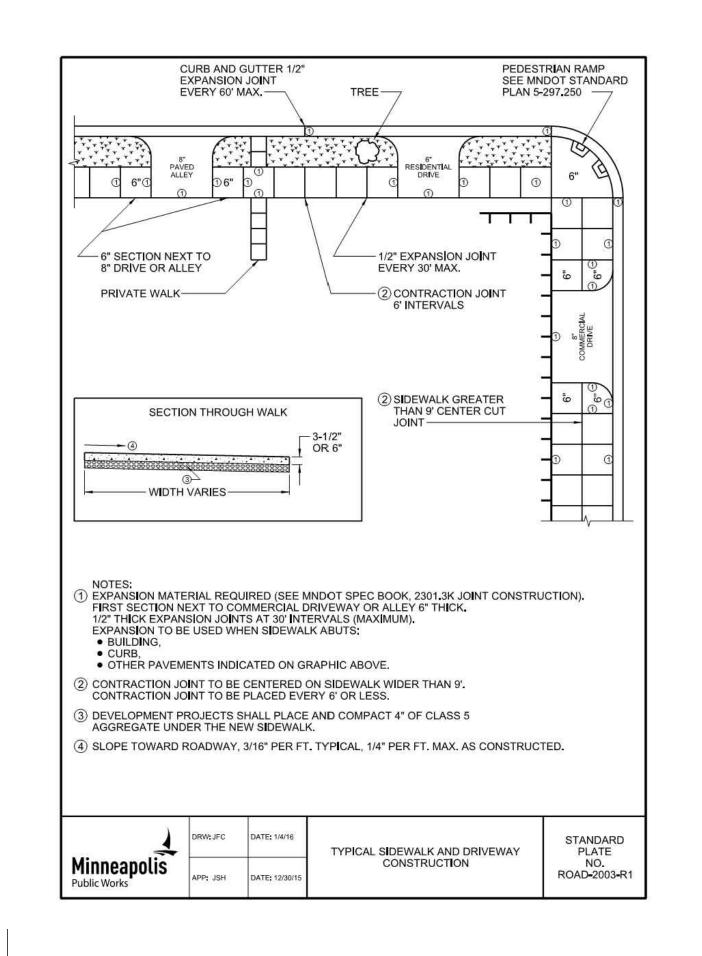
UTILITY PLAN

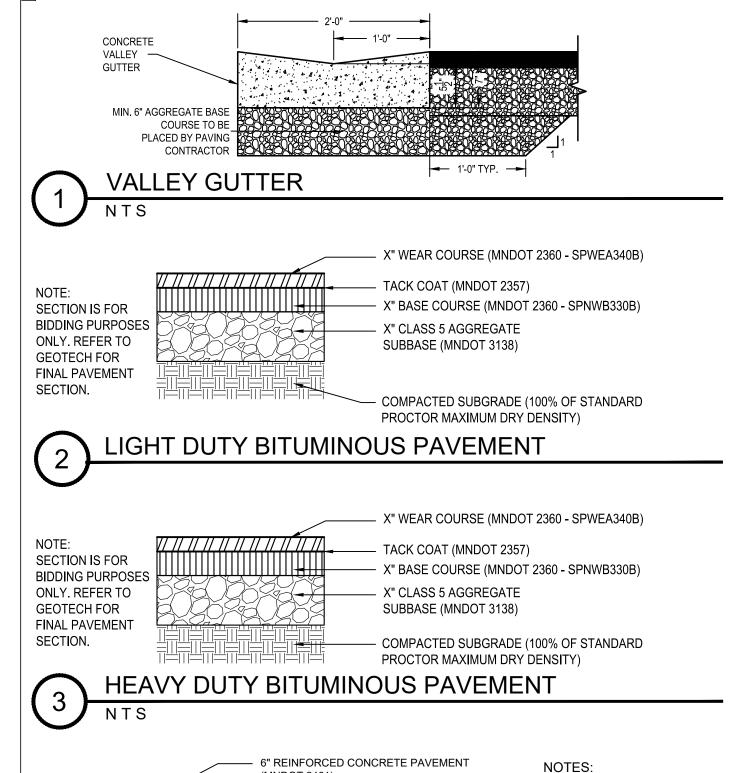
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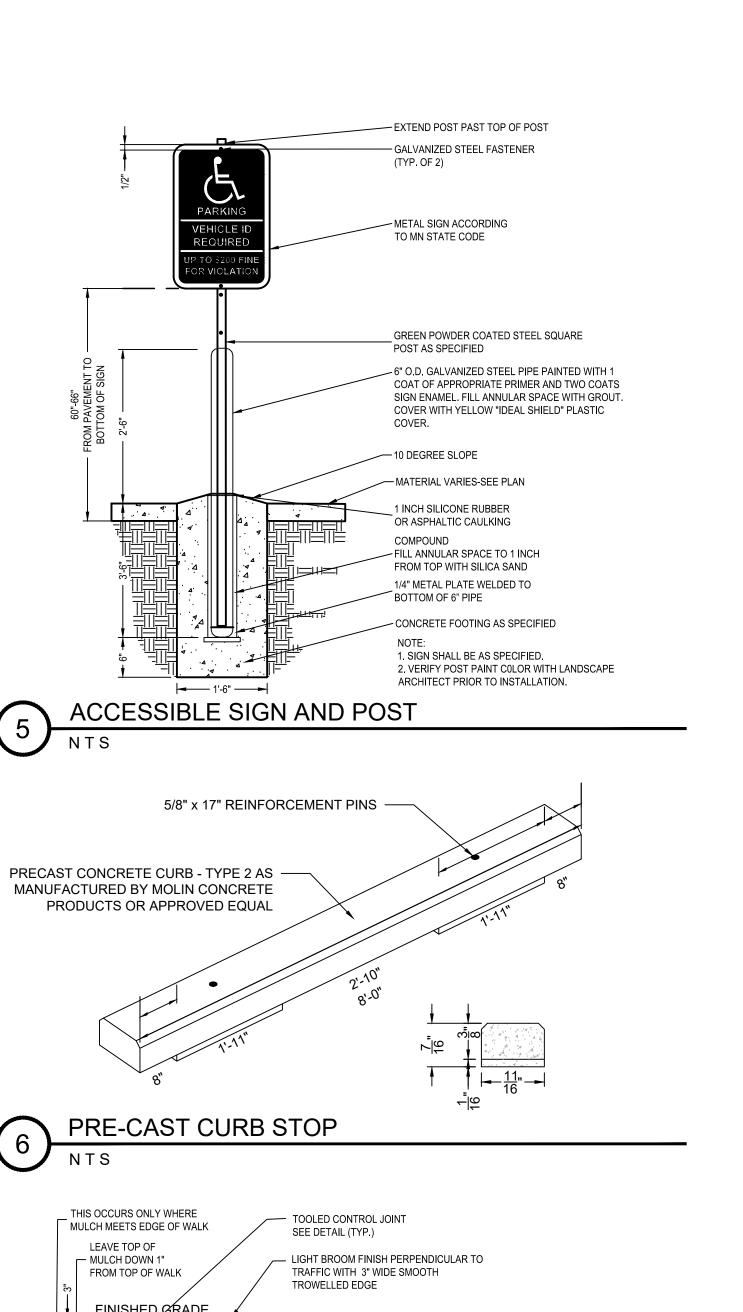












\_\_\_\_ 5" CONCRETE AS SPECIFIED

— 6" CLASS 5 AGGREGATE BASE

COMPACTED SUBGRADE

2. SEE GEO-TECHNICAL RECOMMENDATIONS FOR GROSS WEIGHT

(PRIVATE PROPERTY)

3. SEE LAYOUT DRAWINGS FOR LIMITS OF WALKS.

**CONCRETE WALK/PAD** 

4. SEE CONCRETE JOINT DETAIL FOR REQUIREMENTS.
5. 1/2" WIDE EXPANSION JOINT AND SEALANT AT ALL CURBS.

A.C.I. TECHNICIAN AS SPECIFIED.

REQUIREMENTS.

1. INSTALLATION SHALL BE CERTIFIED AND IN ACCORDANCE TO AN ON-SITE



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RECOMMENDATIONS. ENSURE MID-SLAD REBAR PLACEMENT 2. INSTALLATION SHALL BE IN ACCORDANCE TO A 6" CLASS 5 AGGREGATE SUBBASE (MNDOT 3138) CERTIFIED, ON-SITE M.A.P.A. TECHNICIAN AS - COMPACTED SUBGRADE (100% STD. PROCTOR MAX. DRY DENSITY) SPECIFIED.

1. SEE GEO-TECHNICAL


REPORT FOR BASE


(MNDOT 2461)


#4 REBAR @ 18" O.C.

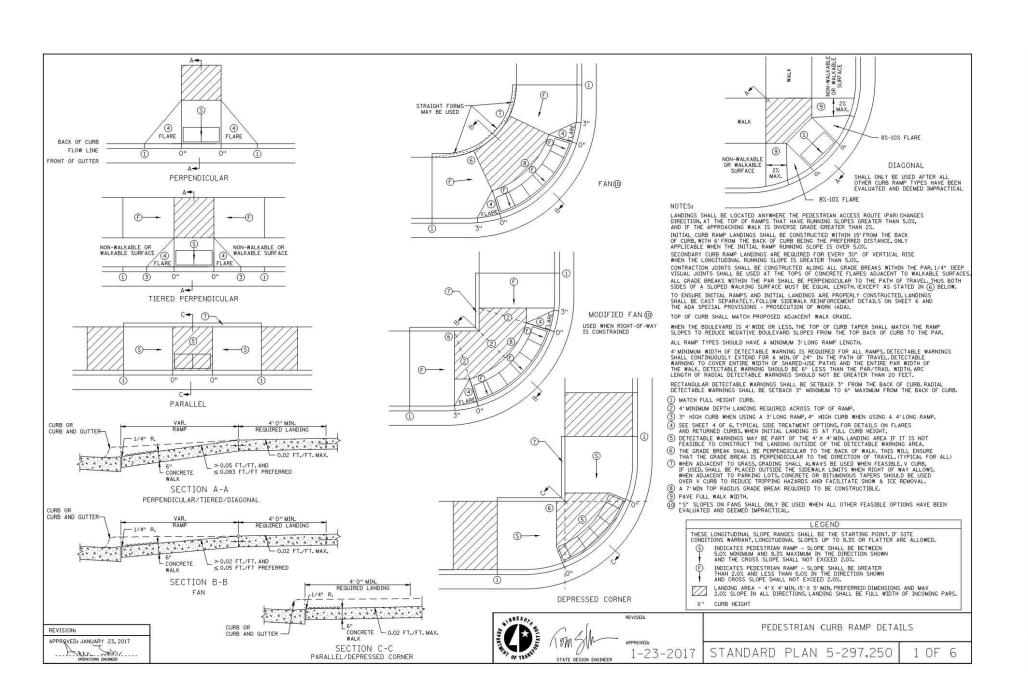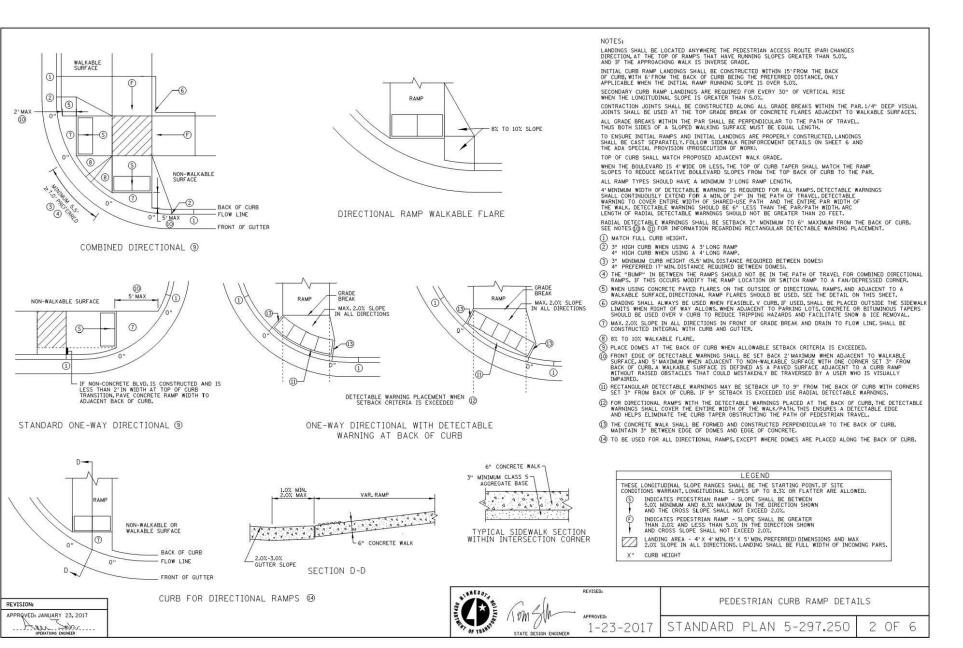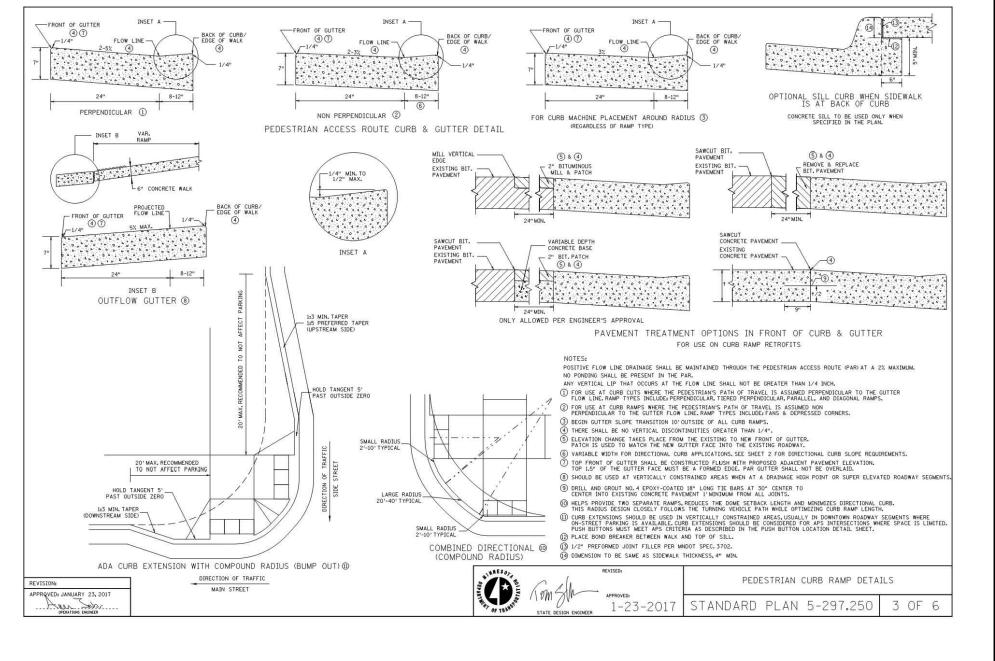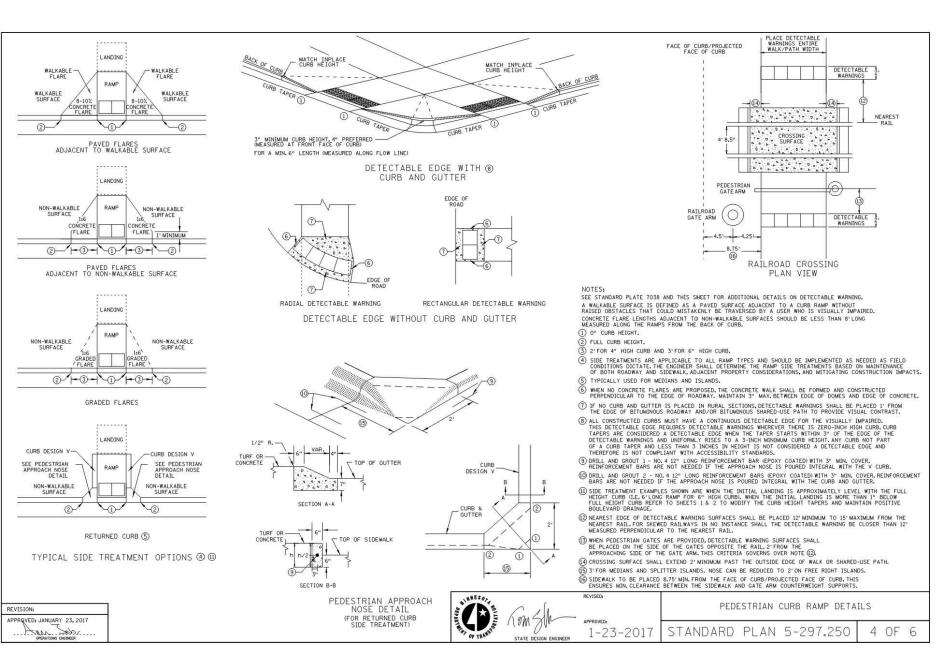
ALTERNATELY PLACED

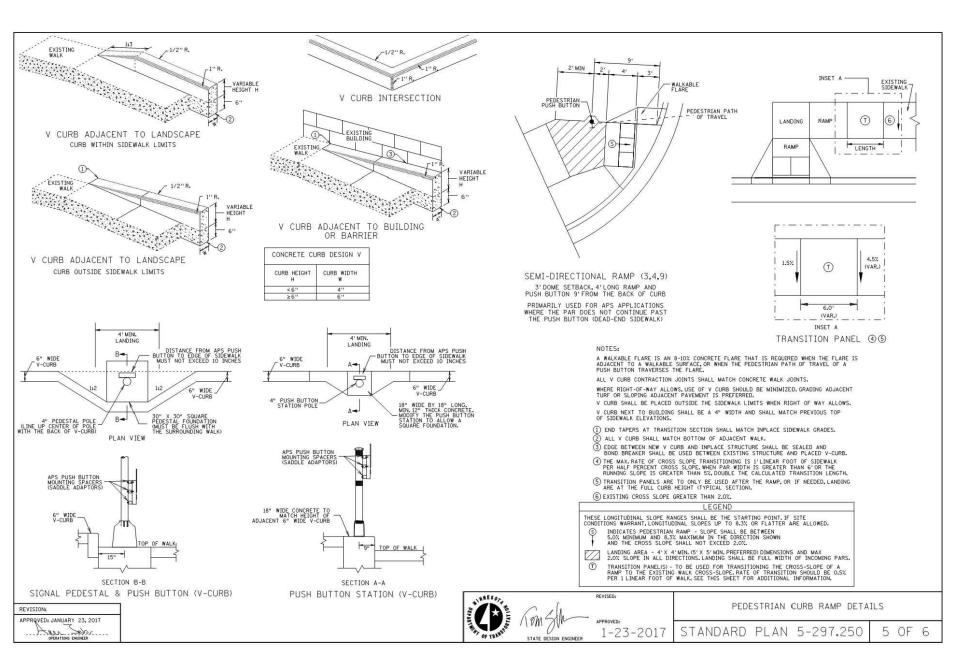
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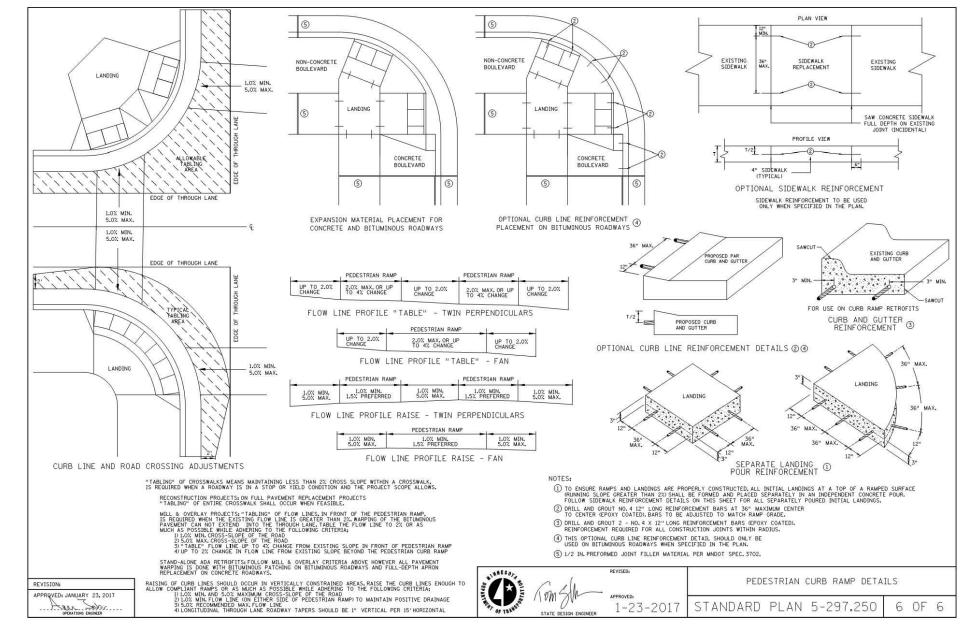












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S  $\overline{\square}$ 

I HEREBY CERTIFY THAT THIS PLAN,
SPECIFICATION, OR REPORT WAS
PREPARED BY ME OR UNDER MY DIRECT
SUPERVISION AND THAT I AM A DULY
LICENSED PROFESSIONAL ENGINEER
UNDER THE LAWS OF THE STATE OF
MINNESOTA.

Matthew R. Pavek

DATE 12/14/20 LICENSE NO. 44263

ISSUE/SUBMITTAL SUMMARY

DATE DESCRIPTION

10/08/2020 PDR SUBMITTAL

10/20/20 PDR SUBMITTAL

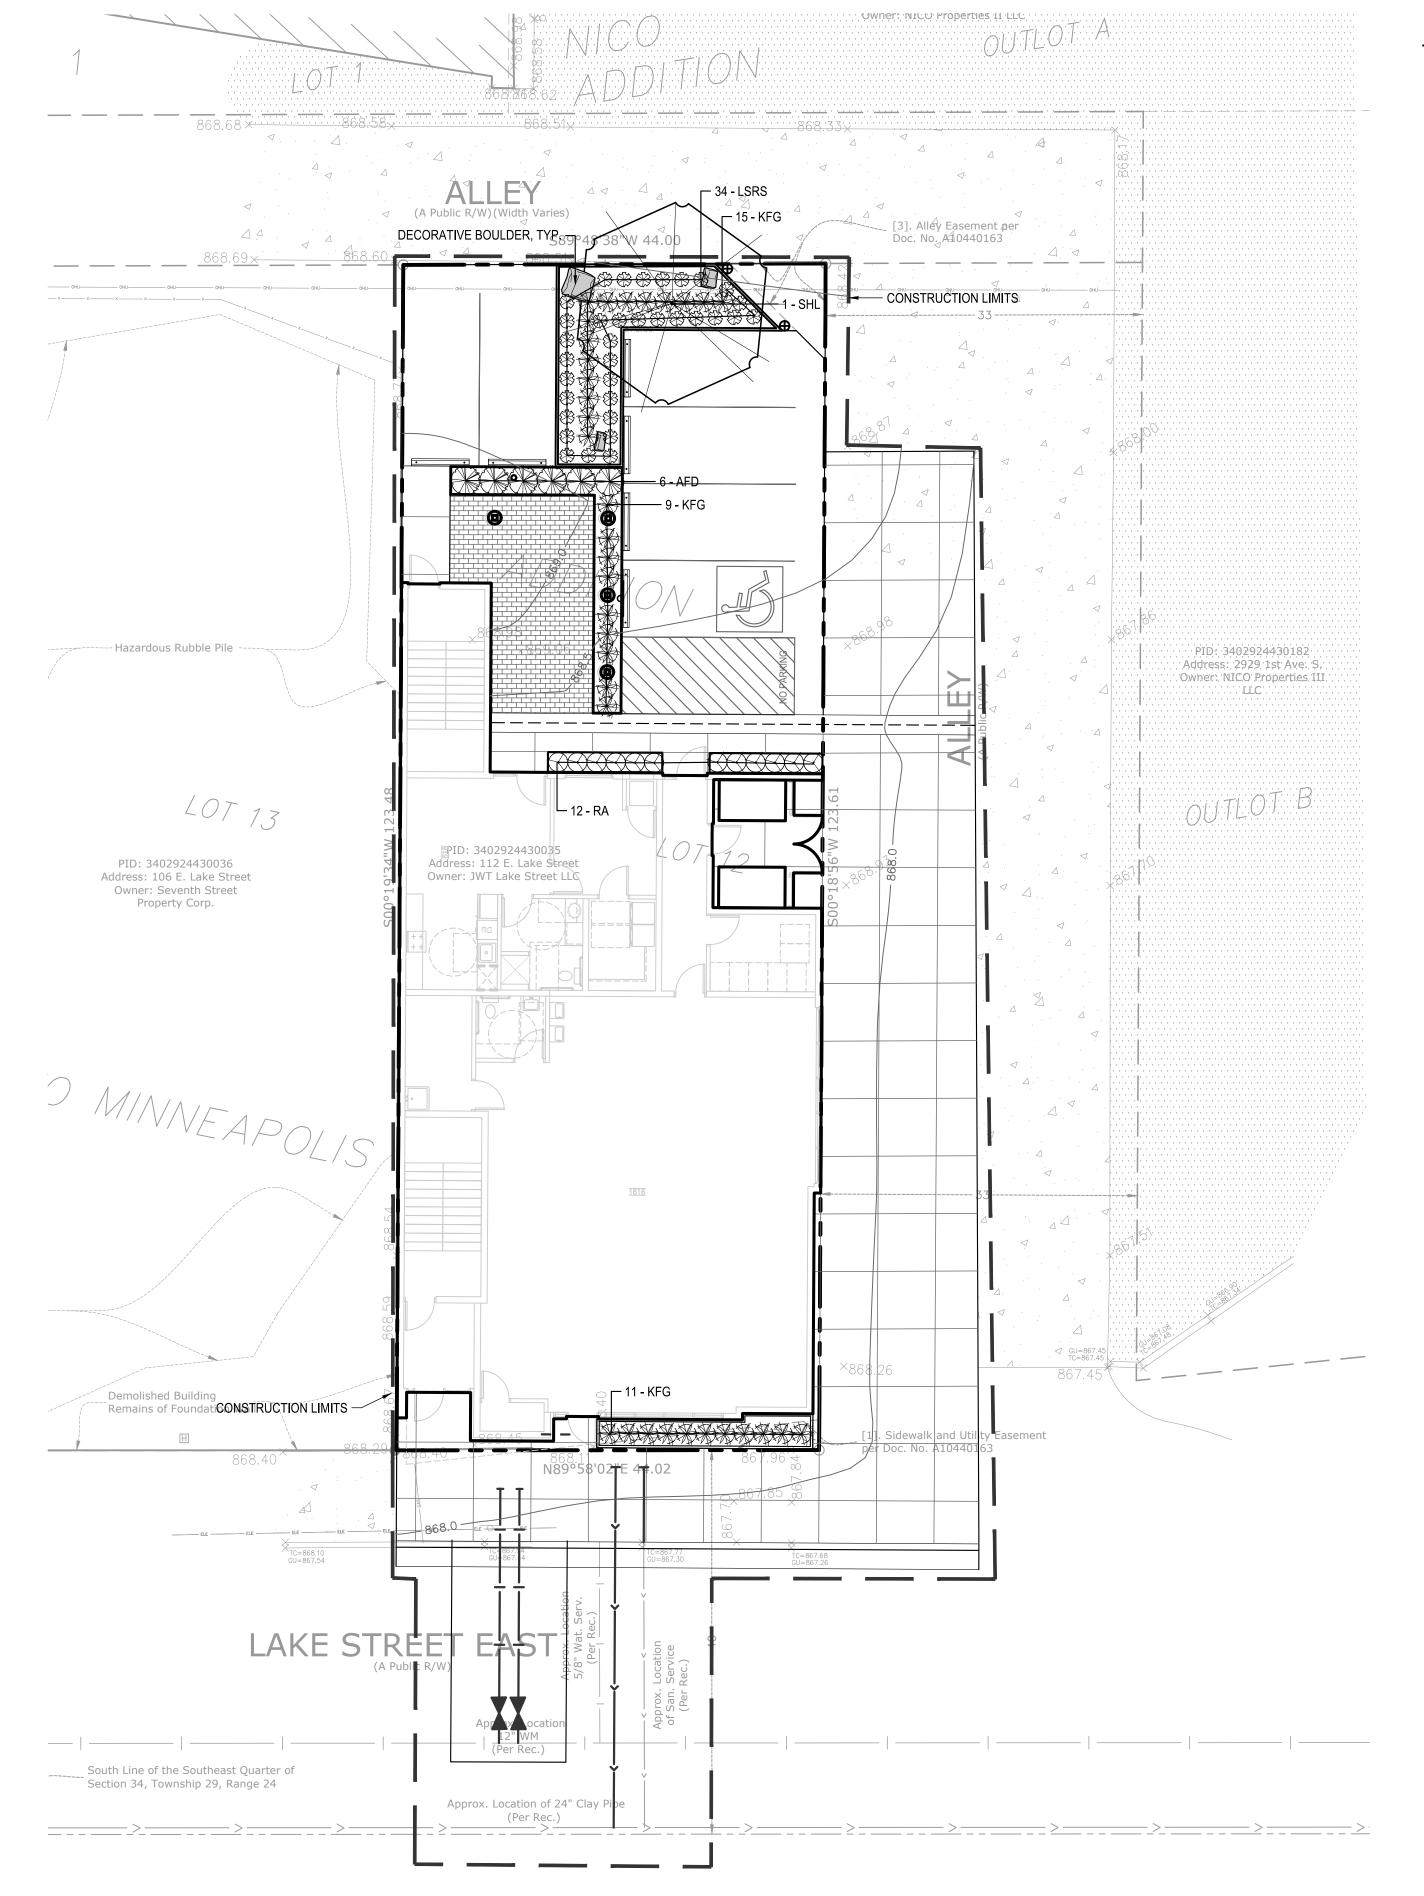
11/02/20 PDR SUBMITTAL

DRAWN BY:KB, KW REVIEWED BY: MP
PROJECT NUMBER: 20267
REVISION SUMMARY

DATE DESCRIPTION
. .

CIVIL DETAILS

C5.1



#### LANDSCAPE NOTES:

- 1. WHERE SHOWN, SHRUB & PERENNIAL BEDS SHALL BE MULCHED WITH 4" DEPTH (MINIMUM AFTER INSTALLATION AND/OR TOP DRESSING OPERATIONS) OF SHREDDED CYPRESS MULCH.
- 2. ALL TREES SHALL BE MULCHED WITH SHREDDED CYPRESS MULCH TO OUTER EDGE OF SAUCER OR TO EDGE OF PLANTING BED, IF APPLICABLE. ALL MULCH SHALL BE KEPT WITHIN A MINIMUM OF 2" FROM TREE TRUNK.
- 3. IF SHOWN ON PLAN, RANDOM SIZED LIMESTONE BOULDERS COLOR AND SIZE TO COMPLIMENT NEW LANDSCAPING. OWNER TO APPROVE BOULDER SAMPLES PRIOR TO INSTALLATION.
- 4. PLANT MATERIALS SHALL CONFORM WITH THE AMERICAN ASSOCIATION OF NURSERYMEN STANDARDS AND SHALL BE OF HARDY STOCK, FREE FROM DISEASE. DAMAGE AND DISFIGURATION. CONTRACTOR IS RESPONSIBLE FOR MAINTAINING PLUMPNESS OF PLANT MATERIAL FOR DURATION OF ACCEPTANCE PERIOD.
- 5. UPON DISCOVERY OF A DISCREPANCY BETWEEN THE QUANTITY OF PLANTS SHOWN ON THE SCHEDULE AND THE QUANTITY SHOWN ON THE PLAN, THE PLAN SHALL GOVERN.
- 6. CONDITION OF VEGETATION SHALL BE MONITORED BY THE LANDSCAPE ARCHITECT THROUGHOUT THE DURATION OF THE CONTRACT. LANDSCAPE MATERIALS PART OF THE CONTRACT SHALL BE WARRANTED FOR ONE (1) FULL GROWING SEASONS FROM SUBSTANTIAL COMPLETION DATE.
- 7. ALL AREAS DISTURBED BY CONSTRUCTION ACTIVITIES SHALL RECEIVE 4" LAYER TOPSOIL AND SOD AS SPECIFIED UNLESS OTHERWISE NOTED ON THE DRAWINGS.
- 8. COORDINATE LOCATION OF VEGETATION WITH UNDERGROUND AND OVERHEAD UTILITIES, LIGHTING FIXTURES, DOORS AND WINDOWS. CONTRACTOR SHALL STAKE IN THE FIELD FINAL LOCATION OF TREES AND SHRUBS FOR REVIEW AND APPROVAL BY THE LANDSCAPE ARCHITECT PRIOR TO INSTALLATION.
- 9. ALL PLANT MATERIALS SHALL BE WATERED AND MAINTAINED UNTIL ACCEPTANCE.
- 10. REPAIR AT NO COST TO OWNER ALL DAMAGE RESULTING FROM LANDSCAPE CONTRACTOR'S ACTIVITIES.
- 11. SWEEP AND MAINTAIN ALL PAVED SURFACES FREE OF DEBRIS GENERATED FROM LANDSCAPE CONTRACTOR'S ACTIVITIES.
- 12. REPAIR AT NO COST TO THE OWNER IRRIGATION SYSTEM DAMAGED FROM LANDSCAPE CONSTRUCTION ACTIVITIES.
- 13. PROVIDE SITE WIDE IRRIGATION SYSTEM DESIGN AND INSTALLATION. SYSTEM SHALL BE FULLY PROGRAMMABLE AND CAPABLE OF ALTERNATE DATE WATERING. THE SYSTEM SHALL PROVIDE HEAD TO HEAD OR DRIP COVERAGE AND BE CAPABLE OF DELIVERING ONE INCH OF PRECIPITATION PER WEEK. SYSTEM SHALL EXTEND INTO THE PUBLIC RIGHT-OF-WAY TO THE EDGE OF PAVEMENT/BACK OF CURB.
- 14. CONTRACTOR SHALL SECURE APPROVAL OF PROPOSED IRRIGATION SYSTEM INLCUDING PRICING FROM OWNER, PRIOR TO INSTALLATION.

## PLANT SCHEDULE - ENTIRE SITE

SYM	QUANT.	COMMON NAME	BOTANICAL NAME	SIZE	ROOT	POLLINATOR FRIENDLY	NATIVE	COMMENTS
		DECIDUOUS TREES						
SHL	1	SKYLINE HONEYLOCUST	Gleditsia triacanthos 'Skycole'	2.5" CAL.	B&B			STRAIGHT LEADER. FULL FORM
		SHRUBS - CONIFEROUS & EVERGREEN						
AFD	6	ARCTIC FIRE DOGWOOD	Cornus sericea 'Farrow'	24" HT.	CONT.			
		PERENNIALS/ORNAMENTAL GRASSES						
KFG	35	KARL FOERSTER FEATHER REED GRASS	Calamagrostis x acutiflora 'Karl Foerster'	#1	CONT.			
LSRS	34	LITTLE SPIRE RUSSIAN SAGE	Perovskia 'Little Spire'	#1	CONT.	Х		
RA	12	RHEINLAND ASTILBE	Astilbe japonica 'Rheinland'	#1	CONT.	Χ	Х	

## LANDSCAPE CALCULATIONS:

1 SHRUB/100 SF OR "LANDSCAPE AREA"

PROPOSED LANDSCAPE AREA CALCULATION: SITE AREA - BUILDING COVERAGE = OPEN SPACE 5,437.0 SF - 2,973.0 SF = 2,464.0 SF 20% OF OPEN SPACE = LANDSCAPE AREA 492.8 SF REQUIRED 2,464.0 SF = 20% X 465.0 SF PROVIDED 2,464.0 SF = PROPOSED IMPERVIOUS RATIO PROPOSED LANDSCAPE: 1 TREE/ 500 SF OF "LANDSCAPE AREA" 492.8 SF / 500 = 1 TREES REQUIRED SEE PLANT SCHEDULE

492.8 SF / 100 = 4.9 SHRUBS REQUIRED

SEE PLANT SCHEDULE

CITY OF MINNEAPOLIS SITE SPECIFIC LANDSCAPE NOTES:

THE FOLLOWING:HTTP://WWW.MINNEAPOLISMN.GOV/PUBLICWORKS/PLATES/INDEX.HTM).

1. ALL PROPOSED TREES IN THE PUBLIC RIGHT-OF-WAY ARE SUBJECT TO THE REVIEW AND APPROVAL OF THE MINNEAPOLIS PARK BOARD. PLEASE CONTACT CRAIG PINKALLA AT (612) 499-9233 TO DISCUSS TREE SPECIES SELECTION, PLANTING METHOD, SPACING AND LOCATIONS. TREE PLANTING DETAILS SHALL BE INCLUDED IN THE PLANS. FOR ALL TREES PROPOSED IN "HARDSCAPE ENVIRONMENTS" WITHIN THE PUBLIC RIGHT-OF- WAY,

PIT FOR ALL PROPOSED STREET TREES. LANDSCAPING IN THE PUBLIC RIGHT-OF-WAY SHALL FOLLOW ESTABLISHED DESIGN STANDARDS IN ACCORDANCE WITH THE CITY OF MINNEAPOLIS STANDARD

THE APPLICANT SHALL PROVIDE ENGINEERED/STRUCTURED SOIL IN THE FORM OF A TREE TRENCH OR TREE

SUPPLEMENTAL SPECIFICATIONS FOR CONSTRUCTION CURRENT EDITION AND ITS ATTACHMENTS (REFER TO

## POLLINATOR SAFE PLANT MATERIAL:

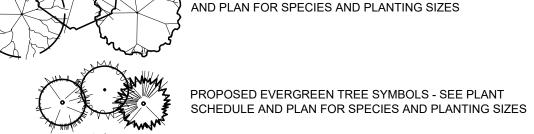
- 1. THE CONTRACTOR SHALL PROVIDE ONLY PLANT MATERIAL FREE OF NEONICOTINOID BASED INSECTICIDES AND/OR TREATMENTS OF ANY KIND, INCLUDING BY NOT LIMITED TO IMIDACLOPRID (CONFIDOR, ADMIRE, GAUCHO, ADVOCATE), THIAMETHOXAM (ACTARA, PLATINUM, CRUISER), CLOTHIANIDIN (PONCHO, DANTOSU, DANTOP), ACETAMIPRID (MOSPILAN, ASSAIL, CHIPCOTRISTAR), THIACLOPRID (CALYPSO), DINOTEFURAN (STARKLE, SAFARI, VENOM), AND NITENPYRAM (CAPSTAR, GUARDIAN).
- 2. CONTRACTOR SHALL CERTIFY, THROUGH SUPPLIERS POLICY STATEMENT OR AFFIDAVIT. THAT NO NEONICOTINOID BASED INSECTICIDES HAVE BEEN USED ON SITE OR DIRECTLY ADJACENT TO THE GROWING OR STORAGE PLOTS OF THE SUPPLIED PLANT MATERIAL, INCLUDING THE PLANTING OF AGRICULTURAL (OR OTHER) SEED TREATED WITH NEONICS..

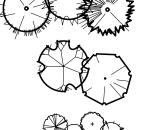
LANDSCAPE LEGEND

PLANTING BEDS & TREE RINGS - SHREDDED CEDAR MULCH. SAMPLES REQUIRED, PROVIDE EDGING AS SHOWN ON PLAN

1" DIA. ROCK MAINTENANCE STRIP OVER FILTER FABRIC,
SAMPLES REQUIRED. PROVIDE EDGING AS SHOWN ON PLAN

PROPOSED CANOPY TREE SYMBOLS - SEE PLANT SCHEDULE






PROPOSED ORNAMENTAL TREE SYMBOLS - SEE PLANT SCHEDULE AND PLAN FOR SPECIES AND PLANTING SIZES

PROPOSED DECIDUOUS AND EVERGREEN SHRUB SYMBOLS - SEE PLANT SCHEDULE AND PLAN FOR SPECIES AND PLANTING SIZES PROPOSED PERENNIAL PLANT SYMBOLS - SEE PLANT SCHEDULE AND PLAN FOR SPECIES AND PLANTING SIZES



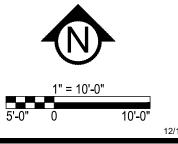DECORATIVE BOULDERS (ROUNDED & BLOCK STYLE), 18"-30" DIA.





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DATE 12/14/20 LICENSE NO. 24904

ISSUE/SUBMITTAL SUMMARY DATE DESCRIPTION 10/08/2020 PDR SUBMITTAL

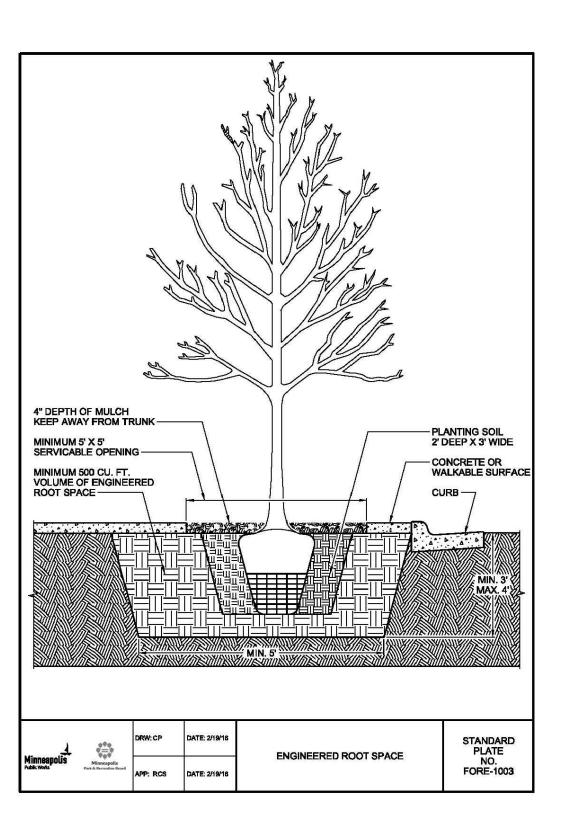
10/20/20 PDR SUBMITTAL 11/02/20 PDR SUBMITTAL 12/14/20 MIXED USE BUILDING

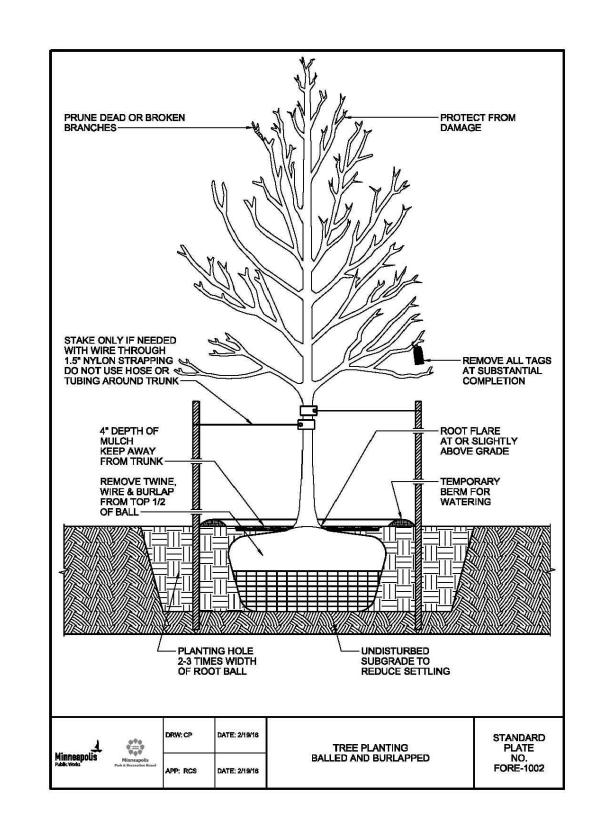
DRAWN BY:KB, KW REVIEWED BY: MP

PROJECT NUMBER: 20267 REVISION SUMMARY

DATE DESCRIPTION


LANDSCAPE PLAN





## **IRRIGATION NOTES:**

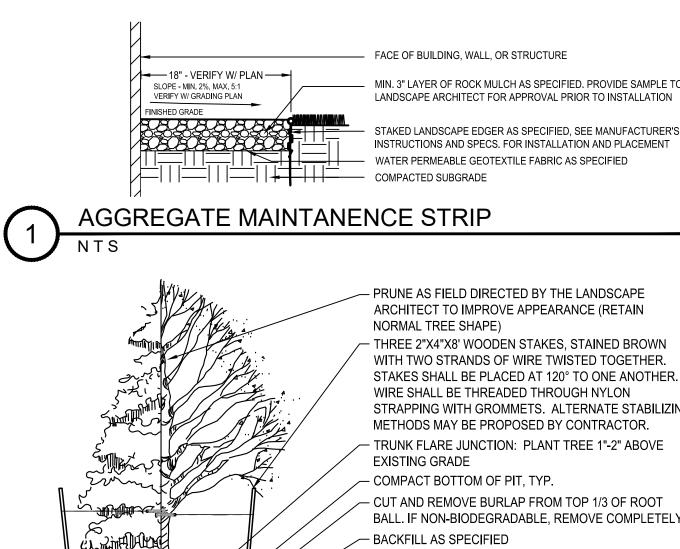
- 1. ENTIRE SITE SHALL BE FULLY IRRIGATED. THE CONTRACTOR SHALL SUBMIT IRRIGATION SHOP DRAWINGS FOR REVIEW AND APPROVAL BY THE LANDSCAPE ARCHITECT PRIOR TO INSTALLATION.
- 2. SEE MECHANICAL AND ELECTRICAL PLANS AND SPECIFICATIONS FOR IRRIGATION WATER, METER, AND POWER CONNECTIONS.
- 3. CONTRACTOR TO VERIFY LOCATION OF ALL UNDERGROUND/ABOVE GROUND FACILITIES PRIOR TO ANY EXCAVATION/INSTALLATION. ANY DAMAGE TO UNDERGROUND/ABOVE GROUND FACILITIES SHALL BE THE RESPONSIBILITY OF
- THE CONTRACTOR AND COSTS ASSOCIATED WITH CORRECTING DAMAGES SHALL BE BORNE ENTIRELY BY THE CONTRACTOR. 4. SERVICE EQUIPMENT AND INSTALLATION SHALL BE PER LOCAL UTILITY COMPANY STANDARDS AND SHALL BE PER NATIONAL AND LOCAL CODES. EXACT LOCATION OF SERVICE EQUIPMENT SHALL BE COORDINATED WITH THE LANDSCAPE ARCHITECT
- OR EQUIVALENT AT THE JOB SITE. 5. CONTRACTOR SHALL COORDINATE WITH LOCAL UTILITY COMPANY FOR THE PROPOSED ELECTRICAL SERVICE AND METERING FACILITIES.
- 6. IRRIGATION WATER LINE CONNECTION SIZE IS 1-½" AT BUILDING. VERIFY WITH MECHANICAL PLANS.COVAGE.
- 7. ALL MAIN LINES SHALL BE 18" BELOW FINISHED GRADE.
- 8. ALL LATERAL LINES SHALL BE 12" BELLOW FINISHED GRADE.
- 9. ALL EXPOSED PVC RISERS, IF ANY, SHALL BE GRAY IN COLOR.
- 10. CONTRACTOR SHALL LAY ALL SLEEVES AND CONDUIT AT 2'-0" BELOW THE FINISHED GRADE OF THE TOP OF PAVEMENT. EXTEND SLEEVES TO 2'-0" BEYOND PAVEMENT.
- 11. CONTRACTOR SHALL MARK THE LOCATION OF ALL SLEEVES AND CONDUIT WITH THE SLEEVING MATERIAL "ELLED" TO 2'-0" ABOVE FINISHED GRADE AND CAPPED.
- 12. FABRICATE ALL PIPE TO MANUFACTURE'S SPECIFICATIONS WITH CLEAN AND SQUARE CUT JOINTS. USE QUALITY GRADE PRIMER AND SOLVENT CEMENT FORMULATED FOR INTENDED TYPE OF CONNECTION.
- 13. BACKFILL ALL TRENCHES WITH SOIL FREE OF SHARP OBJECTS AND DEBRIS.
- 14. ALL VALVE BOXES AND COVERS SHALL BE BLACK IN COLOR.
- 15. GROUP VALVE BOXES TOGETHER FOR EASE WHEN SERVICE IS REQUIRED. LOCATE IN PLANT BED AREAS WHENEVER POSSIBLE.
- 16. IRRIGATION CONTROLLER LOCATION SHALL BE VERIFIED ON-SITE WITH OWNER'S REPRESENTATIVE.
- 17. CONTROL WIRES: 14 GAUGE DIRECT BURIAL, SOLID COPPER IRRIGATION WIRE. RUN UNDER MAIN LINE. USE MOISTURE-PROOF SPLICES AND SPLICE ONLY AT VALVES OR PULL BOXES. RUN SEPARATE HOT AND COMMON WIRE TO EACH VALVE AND ONE (1) SPARE WIRE AND GROUND TO FURTHEST VALVE FROM CONTROLLER. LABEL OR COLOR CODE ALL WIRES.
- 18. AVOID OVER SPRAY ON BUILDINGS, PAVEMENT, WALLS AND ROADWAYS BY INDIVIDUALLY ADJUSTING RADIUS OR ARC ON SPRINKLER HEADS AND FLOW CONTROL ON AUTOMATIC VALVE.
- 19. ADJUST PRESSURE REGULATING VALVES FOR OPTIMUM PRESSURE ON SITE.
- 20. USE SCREENS ON ALL HEADS.
- 21. A SET OF AS-BUILT DRAWINGS SHALL BE MAINTAINED ON-SITE AT ALL TIMES IN AN UPDATED CONDITION.
- 22. ALL PIPE 3" AND OVER SHALL HAVE THRUST BLOCKING AT EACH TURN.
- 23. ALL AUTOMATIC REMOTE CONTROL VALVES WILL HAVE 3" MINIMUM DEPTH OF 3/4" WASHED GRAVEL UNDERNEATH VALVE AND VALVE BOX. GRAVEL SHALL EXTENT 3" BEYOND PERIMETER OF VALVE BOX.
- 24. THERE SHALL BE 3" MINIMUM SPACE BETWEEN BOTTOM OF VALVE BOX COVER AND TOP OF VALVE STRUCTURE.



FACE OF BUILDING, WALL, OR STRUCTURE MIN. 3" LAYER OF ROCK MULCH AS SPECIFIED. PROVIDE SAMPLE TO

STAKED LANDSCAPE EDGER AS SPECIFIED, SEE MANUFACTURER'S

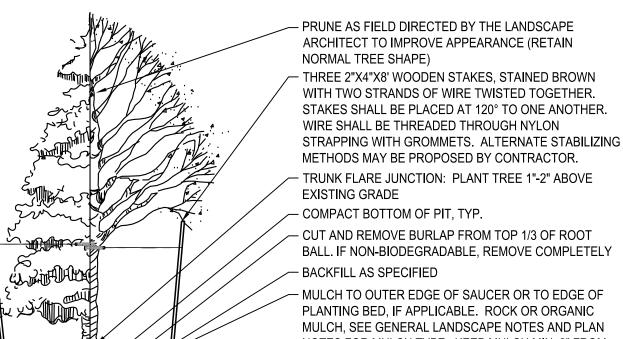
INSTRUCTIONS AND SPECS. FOR INSTALLATION AND PLACEMENT — WATER PERMEABLE GEOTEXTILE FABRIC AS SPECIFIED



NOTES FOR MULCH TYPE. KEEP MULCH MIN. 2" FROM PLANT TRUNK **EXISTING GRADE** - SLOPE SIDES OF HOLE OR VERTICAL SIDES AT EDGE OF

PLANTING BED - RULE OF THUMB - MODIFY EXCAVATION BASED ON LOCATION OF PLANT MATERIAL AND DESIGN OF BEDS

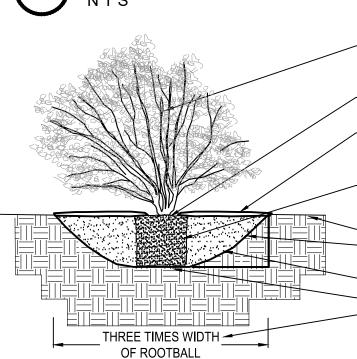OR OVERALL PLANT PLACEMENT OF ROOTBALL DECIDUOUS & CONIFEROUS TREE PLANTING




- PRUNE AS FIELD DIRECTED BY THE LANDSCAPE ARCHITECT TO IMPROVE APPEARANCE (RETAIN NORMAL SHAPE FOR SPECIES)

— PLANT TOP OF ROOTBALL 1-2" ABOVE ABOVE SURROUNDING GRADE - ROCK OR ORGANIC MULCH, SEE GENERAL LANDSCAPE NOTES AND PLAN NOTES FOR MULCH TYPE. KEEP MULCH MIN. 2" FROM PLANT TRUNK - ROOTS AT OUTER EDGE OF ROOTBALL LOOSENED TO ENSURE PROPER BACKFILL-TO-ROOT CONTACT

 EXISTING GRADE - SLOPE SIDES OF HOLE OR VERTICAL SIDES AT EDGE OF PLANTING BED BACKFILL AS PER SPECIFICATION

 DO NOT EXCAVATE BELOW ROOTBALL. - RULE OF THUMB - MODIFY EXCAVATION BASED ON LOCATION OF PLANT MATERIAL AND DESIGN OF BEDS OR OVERALL PLANT PLACEMENT

**DECIDUOUS & CONIFEROUS SHRUB PLANTING** 

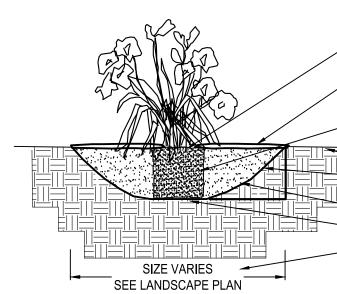

- PLANT TOP OF ROOTBALL 1-2" ABOVE ABOVE SURROUNDING GRADE

- ROCK OR ORGANIC MULCH, SEE GENERAL LANDSCAPE NOTES AND PLAN NOTES FOR MULCH TYPE. KEEP MULCH MIN. 2" FROM PLANT STEM - ROOTS AT OUTER EDGE OF ROOTBALL LOOSENED TO ENSURE PROPER BACKFILL-TO-ROOT CONTACT

- EXISTING GRADE - SLOPE SIDES OF HOLE OR VERTICAL SIDES AT EDGE OF PLANTING BED BACKFILL AS PER SPECIFICATION

 DO NOT EXCAVATE BELOW ROOTBALL. - MODIFY EXCAVATION BASED ON LOCATION OF PLANT MATERIAL AND DESIGN OF BEDS OR OVERALL PLANT PLACEMENT

PERENNIAL BED PLANTING

Know what's **below**. Call before you dig.

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11/02/20 PDR SUBMITTAL 12/14/20 MIXED USE BUILDING


> DRAWN BY:KB, KW REVIEWED BY: MP PROJECT NUMBER: 20267

REVISION SUMMARY DATE DESCRIPTION

LANDSCAPE PLAN NOTES & DETAILS

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12/11/2020 3:27 PM

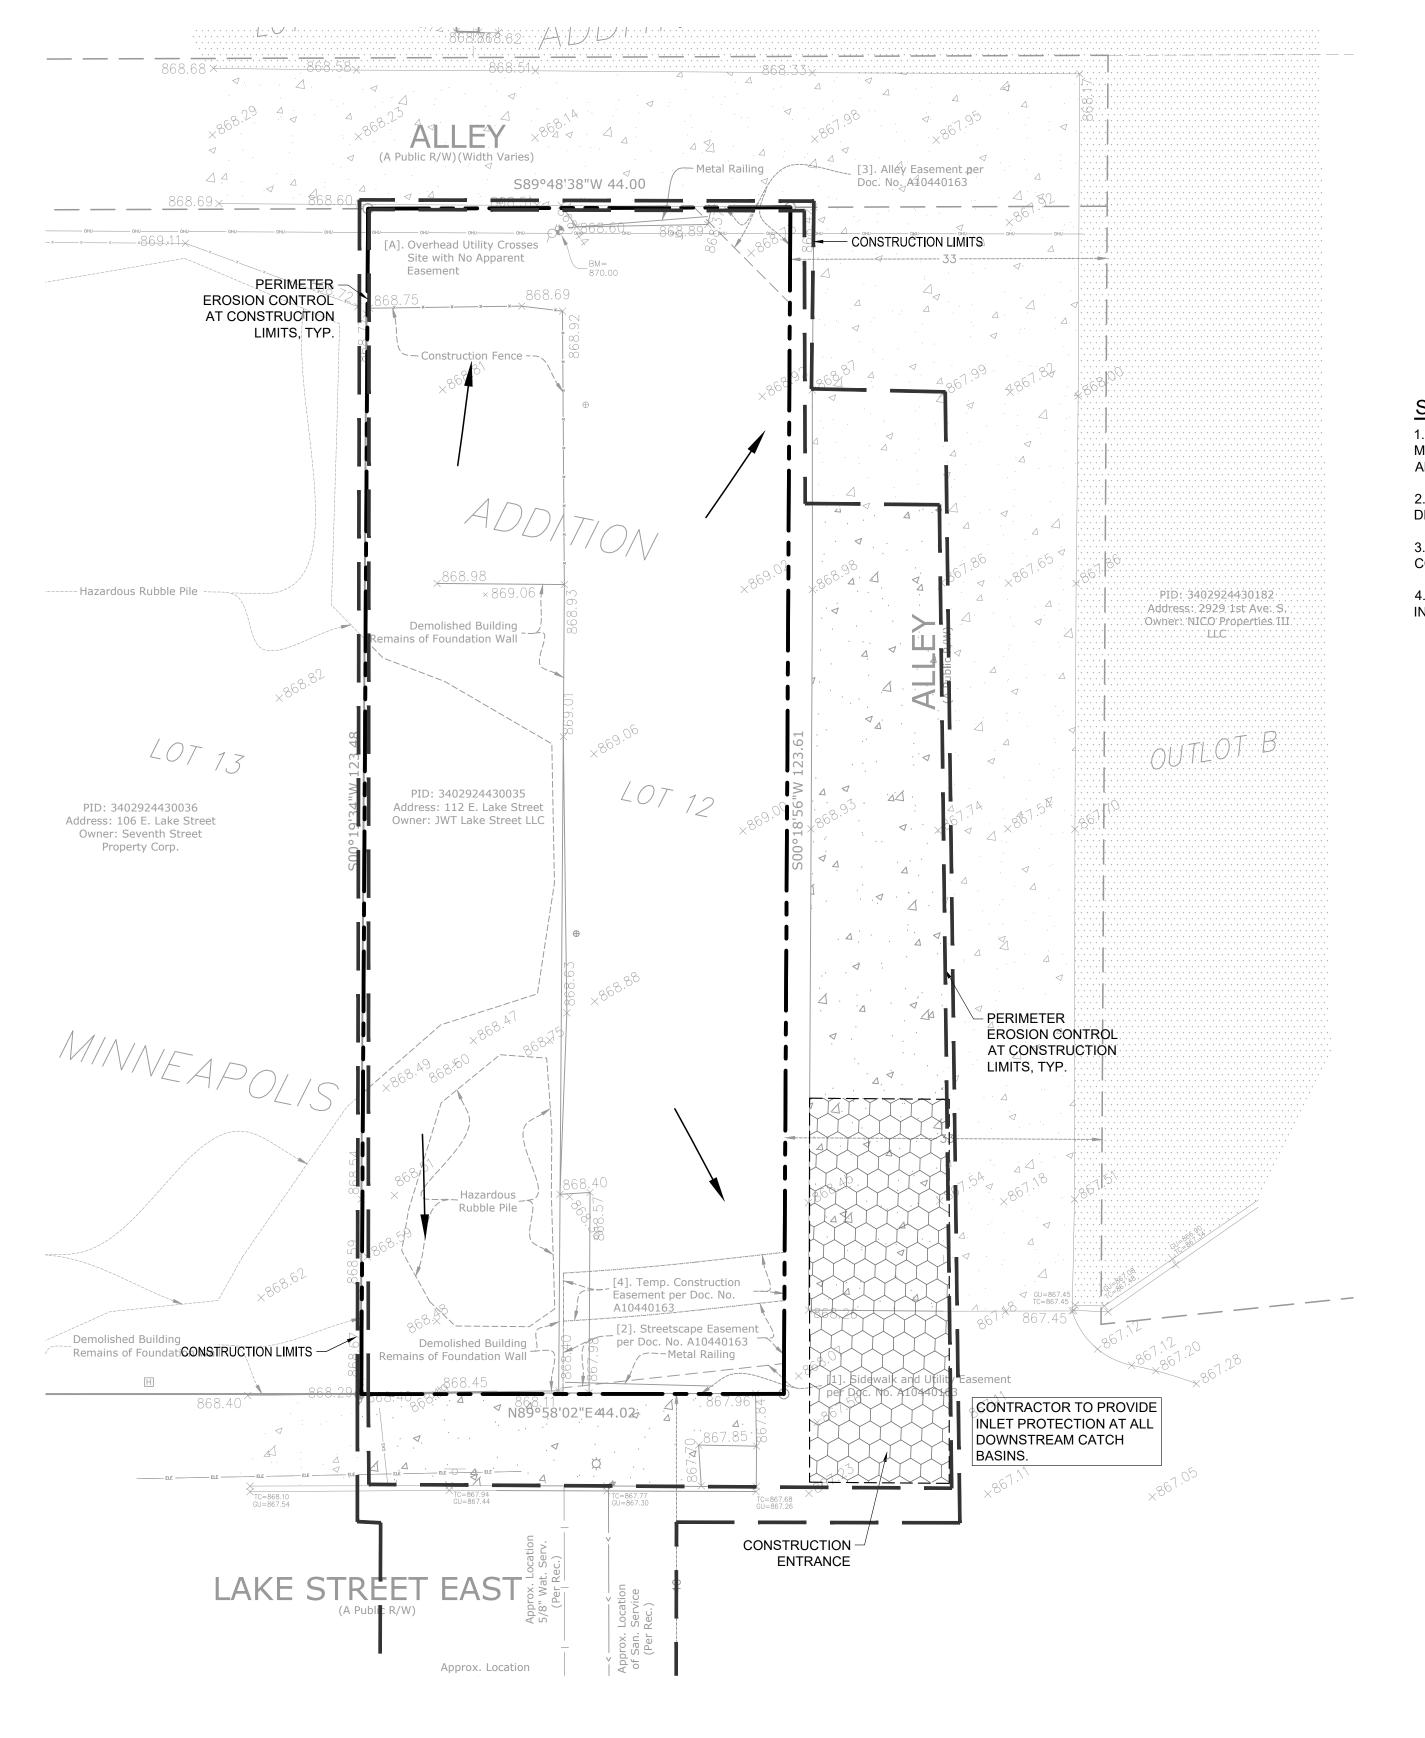

## **SWPPP NOTES:**

1. THIS PROJECT IS LESS THAN ONE ACRE AND WILL NOT REQUIRE AN MPCA NPDES PERMIT. CONTRACTOR IS RESPONSIBLE FOR OBTAINING ANY EROSION CONTROL PERMITS REQUIRED BY THE CITY.

- 2. SEE SHEETS SW1.0 SW1.3 FOR ALL EROSION CONTROL NOTES, DESCRIPTIONS, AND PRACTICES.
- 3. SEE GRADING PLAN FOR ADDITIONAL GRADING AND EROSION CONTROL NOTES.
- 4. CONTRACTOR IS RESPONSIBLE FOR SWPPP IMPLEMENTATION, INSPECTIONS, AND COMPLIANCE WITH NPDES PERMIT.

ALL SPECIFIED EROSION AND SEDIMENT CONTROL PRACTICES, AND MEASURES CONTAINED IN THIS SWPPP ARE THE MINIMUM REQUIREMENTS. ADDITIONAL PRACTICES MAY BE REQUIRED DURING THE COURSE OF CONSTRUCTION.

## CITY OF MINNEAPOLIS EROSION CONTROL NOTES:

OWNERS AND OPERATORS ARE RESPONSIBLE FOR COMPLYING WITH REGULATIONS AND OBTAINING ANY NECESSARY COVERAGE UNDER THE MPCA'S GENERAL PERMIT TO DISCHARGE STORMWATER ASSOCIATED WITH CONSTRUCTION ACTIVITY (PERMIT NO. MN R100001).

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**D** 

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DATE 12/14/20 LICENSE NO. 44263

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11/02/20 PDR SUBMITTAL 12/14/20 MIXED USE BUILDING

DRAWN BY:KB, KW REVIEWED BY: MP

REVISION SUMMARY

PROJECT NUMBER: 20267

DATE DESCRIPTION

SILT FENCE / BIOROLL - GRADING LIMIT

INLET PROTECTION

STABILIZED CONSTRUCTION ENTRANCE

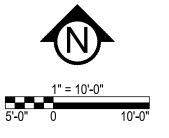
EX. 1' CONTOUR ELEVATION INTERVAL 1.0' CONTOUR ELEVATION INTERVAL

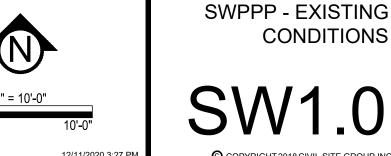
DRAINAGE ARROW

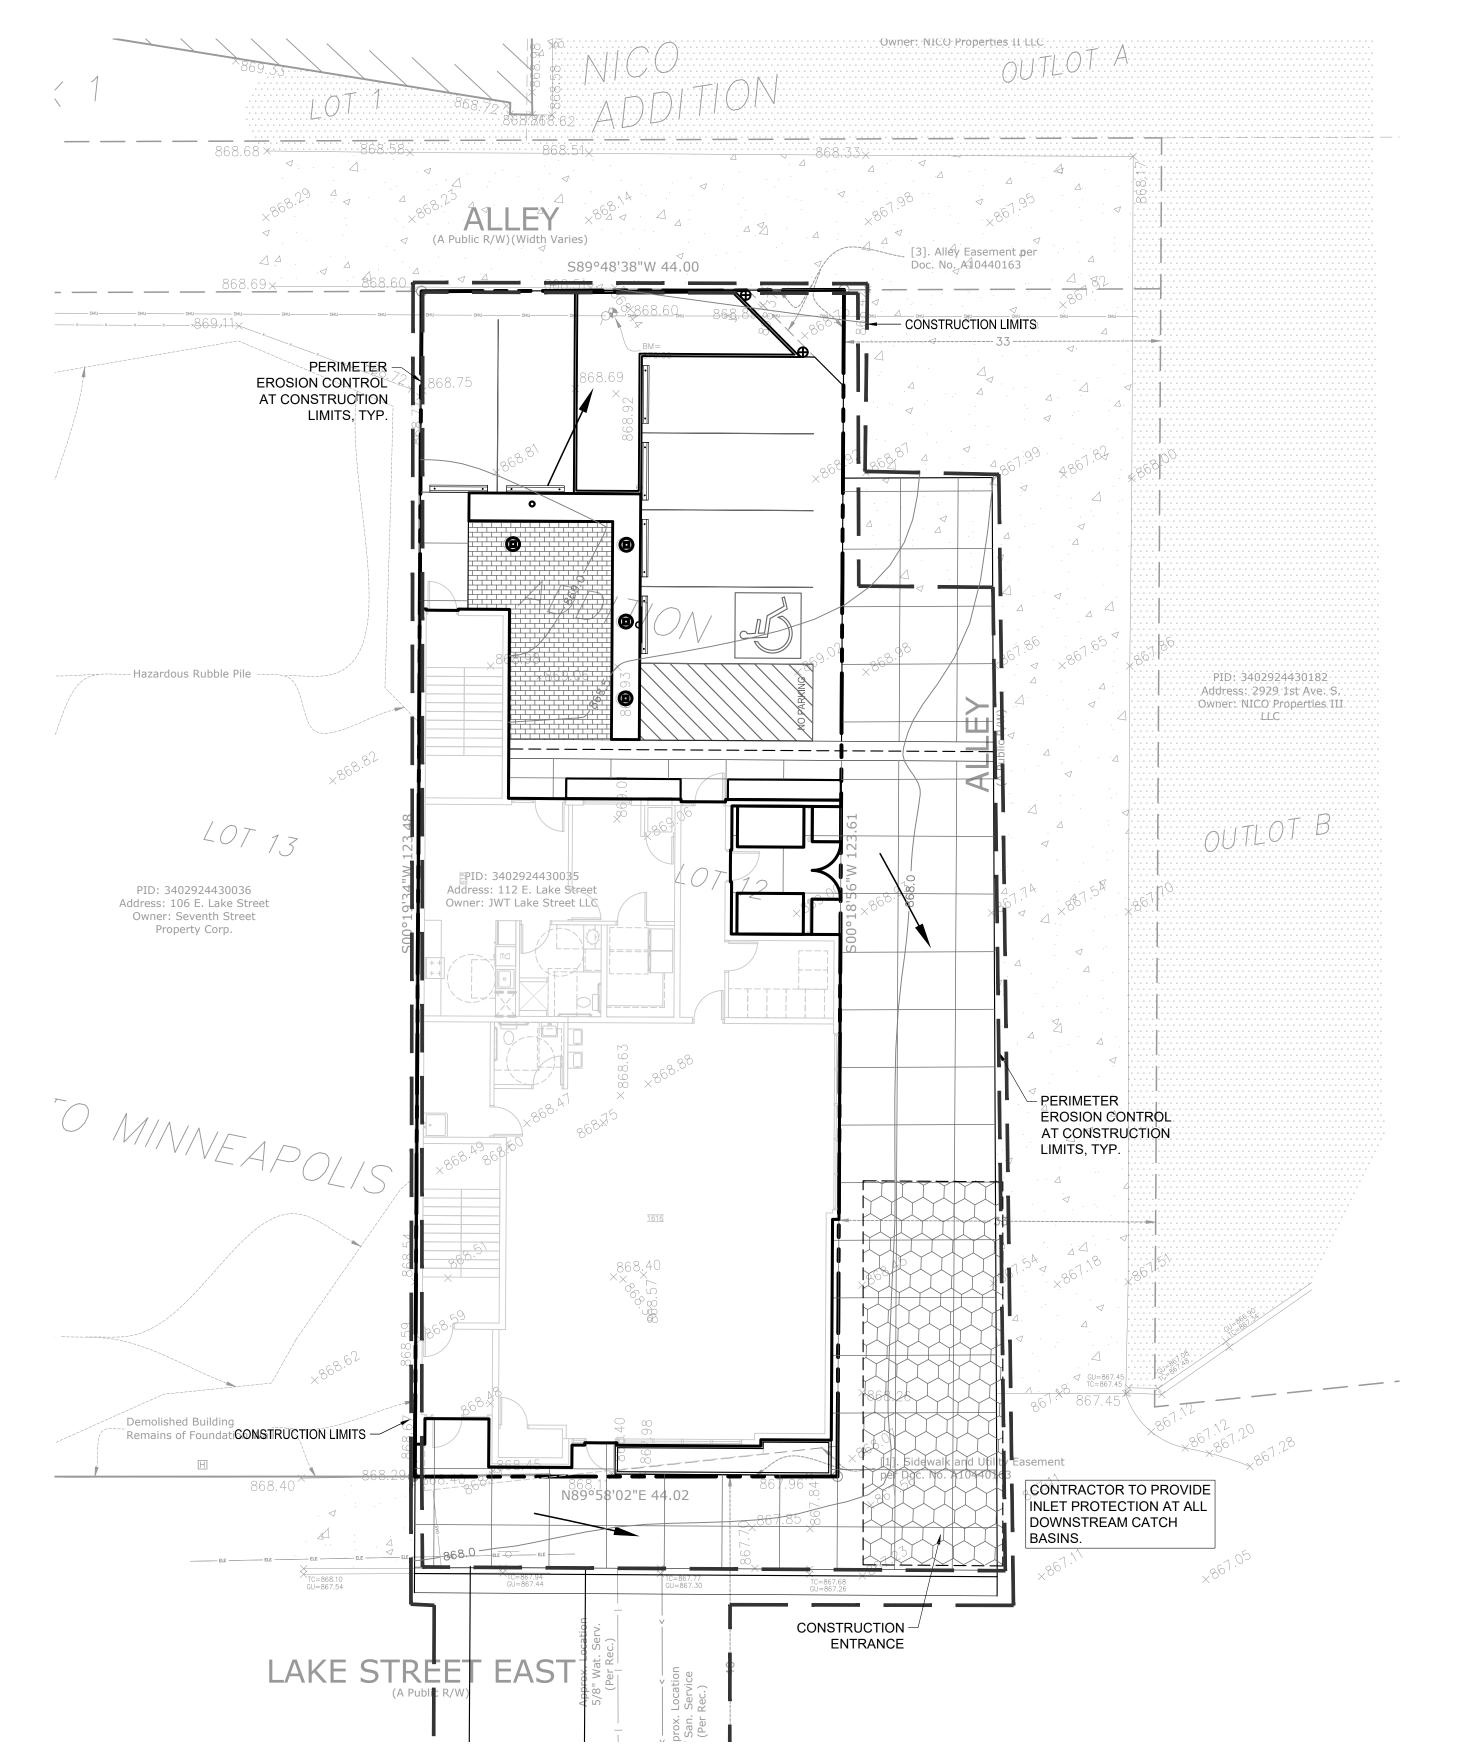
EROSION CONTROL BLANKET



LEGEND:







## SWPPP NOTES:

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## CITY OF MINNEAPOLIS EROSION CONTROL NOTES:

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UNDER THE LAWS OF THE STATE OF

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----- 1125 ----- EX. 1' CONTOUR ELEVATION INTERVAL

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DATE DESCRIPTION

REVISION SUMMARY

CONDITIONS

STABILIZED CONSTRUCTION ENTRANCE

EROSION CONTROL BLANKET

11.0' CONTOUR ELEVATION INTERVAL

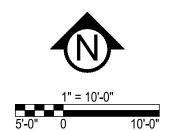
SILT FENCE / BIOROLL - GRADING LIMIT

DRAINAGE ARROW


INLET PROTECTION



LEGEND:




SWPPP - PROPOSED

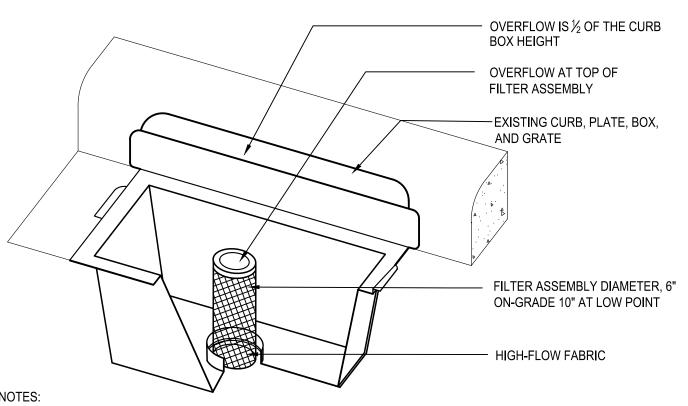

1. REPLACE INLET GRATE UPON COMPLETE INSTALLATION OF INLET PROTECTION FABRIC. 2. CONTRACTOR SHALL REMOVE ALL ACCUMULATED SEDIMENT AND DEBRIS FROM THE SURFACE OF THE SYSTEM AFTER EACH STORM EVENT AND AT THE COMPLETION OF THE CONTRACT.

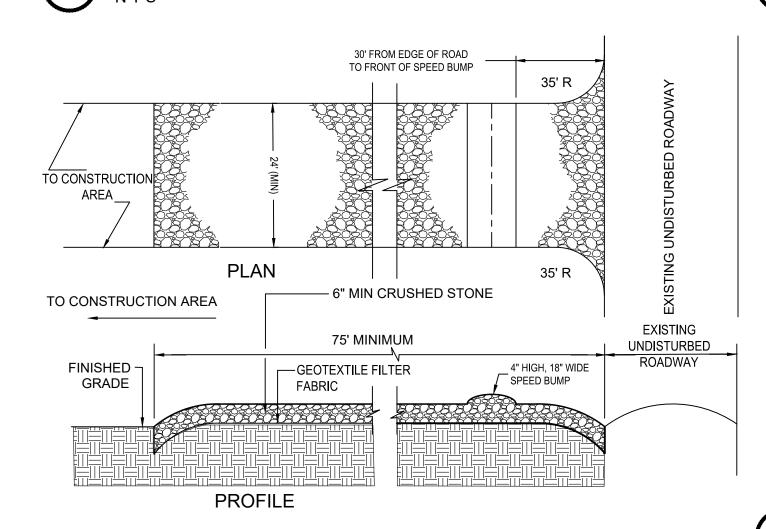3. REFERENCE APPLE VALLEY STANDARD PLATE ERO-4C. **CURB INLET FILTER** 



1. PROVIDE APPROPRIATE TRANSITION BETWEEN STABILIZED CONSTRUCTION ENTRANCE AND UNDISTURBED

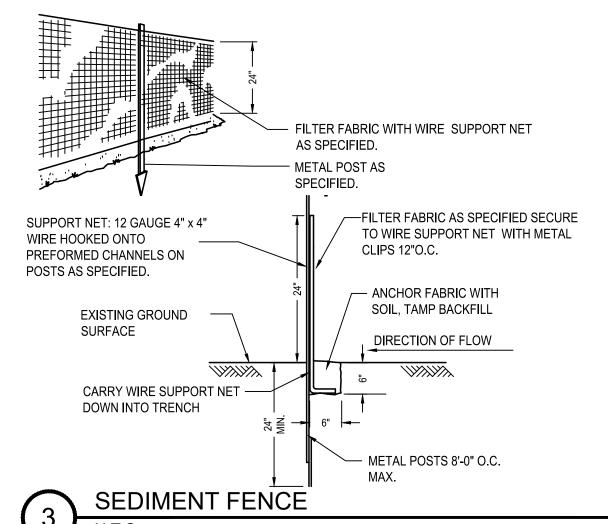
2. THE ENTRANCE SHALL BE MAINTAINED IN A CONDITION WHICH WILL PREVENT TRACKING OR FLOWING OF SEDIMENT ONTO UNDISTURBED ROADWAY. THIS MAY REQUIRE PERIODIC TOP DRESSING WITH ADDITIONAL STONE OR ADDING

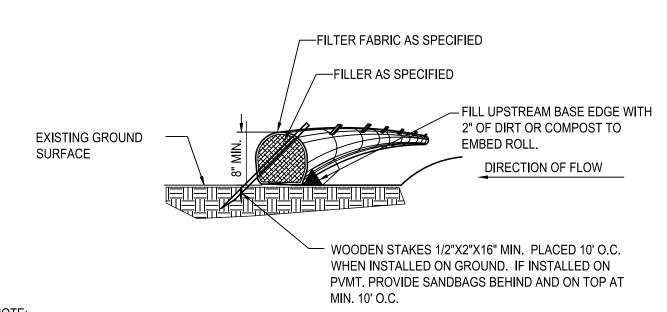
STONE TO THE LENGTH OF THE ENTRANCE. 3. REPAIR AND CLEANOUT MEASURES USED TO TRAP SEDIMENT.

4. ALL SEDIMENT SPILLED, DROPPED, WASHED, OR TRACKED ONTO UNDISTURBED ROADWAY SHALL BE REMOVED AS

5. FINAL LOCATION AND INSTALLATION SHALL BE COORDINATED WITH THE CITY PRIOR TO CONSTRUCTION ACTIVITIES. 6. CRUSHED STONE SHALL BE 1-1/2" DIA. CLOSE GRADED, AND IN ACCORDANCE TO MNDOT SECTION 2118.

2 STABILIZED CONSTRUCTION ACCESS





1. COMPOST FILTER LOGS (BIO ROLLS) SHALL BE FILTREXX EROSION CONTROL SOXX OR APPROVED EQUAL. 2. COMPOST FILLER TO BE MADE FROM A COMPOST BLEND 30%-40% GRADE 2 (SPEC 3890) AND 60%-70% PARTIALLY DECOMPOSED WOOD CHIPS, PER MNDOT SPEC 3897. 3. FILTER FABRIC SHALL BE GEOTEXTILE KNITTED MATERIAL WITH MAX. OPENINGS OF 3/8".

4. IF MULTIPLE ROLLS NEEDED, OVERLAP BY MIN. 12" AT ENDS AND STAKE.

5. SILT SHALL BE REMOVED ONCE IT REACHES 80% OF THE HEIGHT OF THE ROLL OR AS DEEMED NECESSARY BY SITE CONTRACTOR TO MAINTAIN PROPER FUNCTION.

SEDIMENT BIO-ROLL / COMPOST FILTER LOG

City of Minneapolis Standard Erosion Control Notes



City of Minneapolis Standard Erosion and Sediment Control Notes for Plans These notes may be used as performance standards or requirements for projects not meeting the threshold for a formal plan.

- 1. Contractor must call a construction start 48 hours prior to any land disturbances 612-673-3867. Failure to do so may result in fines, the revocation of permit and a stop work order being issued.
- 2. Install perimeter erosion control at the locations shown on the plans prior to the commencement of any land
- disturbance or construction activities. 3. Before beginning construction, install a temporary rock construction entrance at each point where vehicles exit the construction site. Use 2 inch or greater diameter rock in a layer at least 6 inches thick across the entire width of the entrance. Extend the rock entrance at least 50 feet into the construction zone using a geo-textile fabric beneath
- the aggregate to prevent migration of soil into the rock from below. 4. Remove all soils and sediments tracked or otherwise deposited onto public and private pavement areas. Removal shall be on a daily basis when tracking occurs and may be ordered by Minneapolis inspectors at any time if conditions warrant. Sweeping shall be maintained throughout the duration of the construction and done in a manner to prevent dust being blown to adjacent properties.
- 5. Install inlet protection at all public and private catch basin inlets, which receive runoff from the disturbed areas. Contractor shall clean, remove sediment or replace storm drain inlet protection devices on a routine basis such that the devices are fully functional for the next rain event. Sediment deposited in and/or plugging drainage systems is the responsibility of the contractor. Hay bales or filter fabric wrapped grates are not allowed for inlet
- 6. Locate soil or dirt stockpiles no less than 25 feet from any public or private roadway or drainage channel. If remaining for more than seven days, stabilize the stockpiles by mulching, vegetative cover, tarps, or other means. Control erosion from all stockpiles by placing silt barriers around the piles. Temporary stockpiles located on paved surfaces must be no less than two feet from the drainage/gutter line and shall be covered if left more than
- 7. Maintain all temporary erosion and sediment control devices in place until the contributing drainage area has been stabilized. Inspect temporary erosion and sediment control devices on a daily basis and replace deteriorated, damaged, or rotted erosion control devices immediately.
- 8. Temporarily or permanently stabilize all construction areas which have undergone final grading, and all areas in which grading or site building construction operations are not actively underway against erosion due to rain, wind and running water within 7-14 days. Use seed and mulch, erosion control matting, and/or sodding and staking in green space areas. Remove all temporary synthetic, structural, non-biodegradable erosion and sediment control devices after the site has undergone final stabilization with permanent vegetation establishment. Final stabilization for purposes of this removal is 70% established cover over denuded area.
- 9. Ready mixed concrete and concrete batch/mix plants are prohibited within the public right of way. All concrete related production, cleaning and mixing activities shall be done in the designated concrete mixing/washout locations as shown in the erosion control plan. Under no circumstance may washout water drain onto the public right of way or into any public or private storm drain conveyance.
- 10. Changes to approved erosion control plan must be approved by the erosion control inspector prior to implementation. Contractor to provide installation and details for all proposed alternate type devices.
- 11. If dewatering or pumping of water is necessary, the contractor is responsible for obtaining any necessary permits and/or approvals prior to discharge of any water from the site. If the discharge from the dewatering or pumping process is turbid or contains sediment laden water, it must be treated through the use of sediment traps, vegetative filter strips, or other sediment reducing measures such that the discharge is not visibly different from the receiving water. Additional erosion control measures may be required at the discharge point to prevent scour erosion. The contractor shall provide a dewatering/pumping plan to the Erosion Control Inspector prior to initiating dewatering

PREPARED BY: THE CITY OF MINNEAPOLIS PUBLIC WORKS SURFACE WATER AND SEWERS WWW.CI.MINNEAPOLIS.MN.US/STORMWATER **J**ANUARY **7, 2011** 

4931 W. 35th Street, Suite 200 St. Louis Park, MN 55416

civilsitegroup.com

I HEREBY CERTIFY THAT THIS PLAN, SPECIFICATION, OR REPORT WAS PREPARED BY ME OR UNDER MY DIRECT SUPERVISION AND THAT I AM A DULY LICENSED PROFESSIONAL ENGINEER UNDER THE LAWS OF THE STATE OF

Matthew R. Pavek

DATE 12/14/20 LICENSE NO. 44263 ISSUE/SUBMITTAL SUMMARY

> DATE DESCRIPTION 10/08/2020 PDR SUBMITTAL 10/20/20 PDR SUBMITTAL 11/02/20 PDR SUBMITTAL 12/14/20 MIXED USE BUILDING

DRAWN BY:KB, KW REVIEWED BY: MP

PROJECT NUMBER: 20267 REVISION SUMMARY DATE DESCRIPTION

SWPPP - DETAILS

### STORMWATER DISCHARGE DESIGN REQUIREMENTS

THE NATURE OF THIS PROJECT WILL BE CONSISTENT WITH WHAT IS REPRESENTED IN THIS SET OF CONSTRUCTION PLANS AND SPECIFICATIONS. SEE THE SWPPP PLAN SHEETS AND SWPPP NARRATIVE (ATTACHMENT A: CONSTRUCTION SWPPP TEMPLATE) FOR ADDITIONAL SITE SPECIFIC SWPPP INFORMATION. THE PLANS SHOW LOCATIONS AND TYPES OF ALL TEMPORARY AND PERMANENT EROSION PREVENTION AND SEDIMENT CONTROL BMP'S, STANDARD DETAILS ARE ATTACHED TO THIS SWPPP

#### THE INTENDED SEQUENCING OF MAJOR CONSTRUCTION ACTIVITIES IS AS FOLLOWS:

1. INSTALL STABILIZED ROCK CONSTRUCTION ENTRANCE 2. INSTALLATION OF SILT FENCE AROUND SITE

- 3. INSTALL ORANGE CONSTRUCTION FENCING AROUND INFILTRATION AREAS.
- 4. CLEAR AND GRUB FOR TEMPORARY SEDIMENT BASIN / POND INSTALL
- 5. CONSTRUCT TEMPORARY SEDIMENT BASIN / POND (SECTION 14)
- 6. CLEAR AND GRUB REMAINDER OF SITE
- 7. STRIP AND STOCKPILE TOPSOIL 8. ROUGH GRADING OF SITE
- 9. STABILIZE DENUDED AREAS AND STOCKPILES
- 10. INSTALL SANITARY SEWER, WATER MAIN STORM SEWER AND SERVICES 11. INSTALL SILT FENCE / INLET PROTECTION AROUND CB'S
- 12. INSTALL STREET SECTION
- 13. INSTALL CURB AND GUTTER
- 14. BITUMINOUS ON STREETS
- 15. FINAL GRADE BOULEVARD, INSTALL SEED AND MULCH 16 REMOVE ACCUMULATED SEDIMENT FROM BASIN / POND
- 17. FINAL GRADE POND / INFILTRATION BASINS (DO NOT COMPACT SOILS IN INFILTRATION AREAS.)

#### 18. WHEN ALL CONSTRUCTION ACTIVITY IS COMPLETE AND THE SITE IS STABILIZED BY EITHER SEED OR SOD/LANDSCAPING, REMOVE SILT FENCE AND RESEED ANY AREAS DISTURBED BY THE REMOVAL

#### **RECORDS RETENTION:**

THE SWPPP (ORIGINAL OR COPIES) INCLUDING, ALL CHANGES TO IT, AND INSPECTIONS AND MAINTENANCE RECORDS MUST BE KEPT AT THE SITE DURING CONSTRUCTION BY THE PERMITTEE WHO HAS OPERATIONAL CONTROL OF THAT PORTION OF THE SITE. THE SWPPP CAN BE KEPT IN EITHER THE FIELD OFFICE OR IN AN ON SITE VEHICLE DURING NORMAL WORKING HOURS.

#### ALL OWNER(S) MUST KEEP THE SWPPP, ALONG WITH THE FOLLOWING ADDITIONAL RECORDS, ON FILE FOR THREE (3) YEARS AFTER SUBMITTAL OF THE NOT AS OUTLINED IN SECTION 4. THIS DOES NOT INCLUDE ANY RECORDS AFTER SUBMITTAL OF THE

- THE FINAL SWPPP.
- 2. ANY OTHER STORMWATER RELATED PERMITS REQUIRED FOR THE PROJECT;
- 3. RECORDS OF ALL INSPECTION AND MAINTENANCE CONDUCTED DURING CONSTRUCTION (SEE SECTION 11, INSPECTIONS
- 4. ALL PERMANENT OPERATION AND MAINTENANCE AGREEMENTS THAT HAVE BEEN IMPLEMENTED, INCLUDING ALL RIGHT OF WAY, CONTRACTS, COVENANTS AND OTHER BINDING REQUIREMENTS REGARDING PERPETUAL MAINTENANCE; AND 5. ALL REQUIRED CALCULATIONS FOR DESIGN OF THE TEMPORARY AND PERMANENT STORMWATER MANAGEMENT

#### SWPPP IMPLEMENTATION RESPONSIBILITIES:

- 1. THE OWNER AND CONTRACTOR ARE PERMITTEE(S) AS IDENTIFIED BY THE NPDES PERMIT.
- 2. CONTRACTOR SHALL BE RESPONSIBLE FOR ALL ON-SITE IMPLEMENTATION OF THE SWPPP, INCLUDING THE ACTIVITIES OF ALL OF THE CONTRACTOR'S SUBCONTRACTORS
- 3. CONTRACTOR SHALL PROVIDE A PERSON(S) KNOWLEDGEABLE AND EXPERIENCED IN THE APPLICATION OF EROSION PREVENTION AND SEDIMENT CONTROL BMPS TO OVERSEE ALL INSTALLATION AND MAINTENANCE OF BMPS AND IMPLEMENTATION OF THE SWPPP.
- 4. CONTRACTOR SHALL PROVIDE PERSON(S) MEETING THE TRAINING REQUIREMENTS OF THE NPDES PERMIT TO CONDUCT INSPECTION AND MAINTENANCE OF ALL EROSION PREVENTION AND SEDIMENT CONTROL BMPS IN ACCORDANCE WITH THE REQUIREMENTS OF THE PERMIT, ONE OF THESE INDIVIDUAL(S) MUST BE AVAILABLE FOR AN ONSITE INSPECTION WITHIN 72 HOURS UPON REQUEST BY MPCA. CONTRACTOR SHALL PROVIDE TRAINING DOCUMENTATION FOR THESE INDIVIDUAL(S) AS REQUIRED BY THE NPDES PERMIT. THIS TRAINING DOCUMENTATION SHALL BE RECORDED IN OR WITH
- THE SWPPP BEFORE THE START OF CONSTRUCTION OR AS SOON AS THE PERSONNEL FOR THE PROJECT HAVE BEEN DETERMINED. DOCUMENTATION SHALL INCLUDE: 4.1. NAMES OF THE PERSONNEL ASSOCIATED WITH THE PROJECT THAT ARE REQUIRED TO BE TRAINED PER SECTION
- 21 OF THE PERMIT. 4.2. DATES OF TRAINING AND NAME OF INSTRUCTOR AND ENTITY PROVIDING TRAINING.
- 4.3. CONTENT OF TRAINING COURSE OR WORKSHOP INCLUDING THE NUMBER OF HOURS OF TRAINING 5. FOLLOWING FINAL STABILIZATION AND THE TERMINATION OF COVERAGE FOR THE NPDES PERMIT, THE OWNER IS EXPECTED TO FURNISH LONG TERM OPERATION AND MAINTENANCE (O & M) OF THE PERMANENT STORM WATER

## CONSTRUCTION ACTIVITY REQUIREMENTS

## SWPPP AMENDMENTS (SECTION 6):

- 1. ONE OF THE INDIVIDUALS DESCRIBED IN ITEM 21.2.A OR ITEM 21.2.B OR ANOTHER QUALIFIED INDIVIDUAL MUST COMPLETE ALL SWPPP CHANGES. CHANGES INVOLVING THE USE OF A LESS STRINGENT BMP MUST INCLUDE A JUSTIFICATION DESCRIBING HOW THE REPLACEMENT BMP IS EFFECTIVE FOR THE SITE CHARACTERISTICS.
- 2. PERMITTEES MUST AMEND THE SWPPP TO INCLUDE ADDITIONAL OR MODIFIED BMPS AS NECESSARY TO CORRECT PROBLEMS IDENTIFIED OR ADDRESS SITUATIONS WHENEVER THERE IS A CHANGE IN DESIGN, CONSTRUCTION. OPERATION. MAINTENANCE. WEATHER OR SEASONAL CONDITIONS HAVING A SIGNIFICANT EFFECT ON THE DISCHARGE OF POLLUTANTS TO SURFACE WATERS OR GROUNDWATER.
- 3. PERMITTEES MUST AMEND THE SWPPP TO INCLUDE ADDITIONAL OR MODIFIED BMPS AS NECESSARY TO CORRECT PROBLEMS IDENTIFIED OR ADDRESS SITUATIONS WHENEVER INSPECTIONS OR INVESTIGATIONS BY THE SITE OWNER OR OPERATOR. USEPA OR MPCA OFFICIALS INDICATE THE SWPPP IS NOT EFFECTIVE IN ELIMINATING OR SIGNIFICANTLY MINIMIZING THE DISCHARGE OF POLLUTANTS TO SURFACE WATERS OR GROUNDWATER OR THE DISCHARGES ARE CAUSING WATER QUALITY STANDARD EXCEEDANCES (E.G., NUISANCE CONDITIONS AS DEFINED IN MINN. R. 7050.0210, SUBP. 2) OR THE SWPPP IS NOT CONSISTENT WITH THE OBJECTIVES OF A USEPA APPROVED TMDL.

## BMP SELECTION AND INSTALLATION (SECTION 7):

1. PERMITTEES MUST SELECT, INSTALL, AND MAINTAIN THE BMPS IDENTIFIED IN THE SWPPP AND IN THIS PERMIT IN AN APPROPRIATE AND FUNCTIONAL MANNER AND IN ACCORDANCE WITH RELEVANT MANUFACTURER SPECIFICATIONS AND ACCEPTED ENGINEERING PRACTICES.

## **EROSION PREVENTION (SECTION 8):**

1. BEFORE WORK BEGINS, PERMITTEES MUST DELINEATE THE LOCATION OF AREAS NOT TO BE DISTURBED. 2. PERMITTEES MUST MINIMIZE THE NEED FOR DISTURBANCE OF PORTIONS OF THE PROJECT WITH STEEP SLOPES, WHEN STEEP SLOPES MUST BE DISTURBED, PERMITTEES MUST USE TECHNIQUES SUCH AS PHASING AND STABILIZATION

PRACTICES DESIGNED FOR STEEP SLOPES (E.G., SLOPE DRAINING AND TERRACING).

- 3. PERMITTEES MUST STABILIZE ALL EXPOSED SOIL AREAS, INCLUDING STOCKPILES. STABILIZATION MUST BE INITIATED IMMEDIATELY TO LIMIT SOIL EROSION WHEN CONSTRUCTION ACTIVITY HAS PERMANENTLY OR TEMPORARILY CEASED ON ANY PORTION OF THE SITE AND WILL NOT RESUME FOR A PERIOD EXCEEDING 14 CALENDAR DAYS. STABILIZATION MUST BE COMPLETED NO LATER THAN 14 CALENDAR DAYS AFTER THE CONSTRUCTION ACTIVITY HAS CEASED. STABILIZATION IS NOT REQUIRED ON CONSTRUCTED BASE COMPONENTS OF ROADS, PARKING LOTS AND SIMILAR SURFACES. STABILIZATION IS NOT REQUIRED ON TEMPORARY STOCKPILES WITHOUT SIGNIFICANT SILT, CLAY OR ORGANIC
- COMPONENTS (E.G., CLEAN AGGREGATE STOCKPILES, DEMOLITION CONCRETE STOCKPILES, SAND STOCKPILES) BUT PERMITTEES MUST PROVIDE SEDIMENT CONTROLS AT THE BASE OF THE STOCKPILE. 4. FOR PUBLIC WATERS THAT THE MINNESOTA DNR HAS PROMULGATED "WORK IN WATER RESTRICTIONS" DURING SPECIFIED FISH SPAWNING TIME FRAMES, PERMITTEES MUST COMPLETE STABILIZATION OF ALL EXPOSED SOIL AREAS
- WITHIN 200 FEET OF THE WATER'S EDGE, AND THAT DRAIN TO THESE WATERS, WITHIN 24 HOURS DURING THE RESTRICTION PERIOD 5. PERMITTEES MUST STABILIZE THE NORMAL WETTED PERIMETER OF THE LAST 200 LINEAR FEET OF TEMPORARY OR PERMANENT DRAINAGE DITCHES OR SWALES THAT DRAIN WATER FROM THE SITE WITHIN 24 HOURS AFTER CONNECTING TO A SURFACE WATER OR PROPERTY EDGE. PERMITTEES MUST COMPLETE STABILIZATION OF REMAINING PORTIONS OF TEMPORARY OR PERMANENT DITCHES OR SWALES WITHIN 14 CALENDAR DAYS AFTER CONNECTING TO A SURFACE
- WATER OR PROPERTY EDGE AND CONSTRUCTION IN THAT PORTION OF THE DITCH TEMPORARILY OR PERMANENTLY CEASES 6. TEMPORARY OR PERMANENT DITCHES OR SWALES BEING USED AS A SEDIMENT CONTAINMENT SYSTEM DURING CONSTRUCTION (WITH PROPERLY DESIGNED ROCK-DITCH CHECKS, BIO ROLLS, SILT DIKES, ETC.) DO NOT NEED TO BE
- STABILIZED. PERMITTEES MUST STABILIZE THESE AREAS WITHIN 24 HOURS AFTER THEIR USE AS A SEDIMENT CONTAINMENT SYSTEM CEASES 7. PERMITTEES MUST NOT USE MULCH, HYDROMULCH, TACKIFIER, POLYACRYLAMIDE OR SIMILAR EROSION PREVENTION
- PRACTICES WITHIN ANY PORTION OF THE NORMAL WETTED PERIMETER OF A TEMPORARY OR PERMANENT DRAINAGE DITCH OR SWALE SECTION WITH A CONTINUOUS SLOPE OF GREATER THAN 2 PERCENT.

8. PERMITTEES MUST PROVIDE TEMPORARY OR PERMANENT ENERGY DISSIPATION AT ALL PIPE OUTLETS WITHIN 24 HOURS

AFTER CONNECTION TO A SURFACE WATER OR PERMANENT STORMWATER TREATMENT SYSTEM. 9. PERMITTEES MUST NOT DISTURB MORE LAND (I.E., PHASING) THAN CAN BE EFFECTIVELY INSPECTED AND MAINTAINED IN POLLUTION PREVENTION MANAGEMENT (SECTION 12): ACCORDANCE WITH SECTION 11.

## SEDIMENT CONTROL (SECTION 9):

- 1. PERMITTEES MUST ESTABLISH SEDIMENT CONTROL BMPS ON ALL DOWNGRADIENT PERIMETERS OF THE SITE AND DOWNGRADIENT AREAS OF THE SITE THAT DRAIN TO ANY SURFACE WATER, INCLUDING CURB AND GUTTER SYSTEMS. PERMITTEES MUST LOCATE SEDIMENT CONTROL PRACTICES UPGRADIENT OF ANY BUFFER ZONES. PERMITTEES MUST INSTALL SEDIMENT CONTROL PRACTICES BEFORE ANY UPGRADIENT LAND-DISTURBING ACTIVITIES BEGIN AND MUST KEEP THE SEDIMENT CONTROL PRACTICES IN PLACE UNTIL THEY ESTABLISH PERMANENT COVER.
- 2. IF DOWNGRADIENT SEDIMENT CONTROLS ARE OVERLOADED, BASED ON FREQUENT FAILURE OR EXCESSIVE MAINTENANCE REQUIREMENTS, PERMITTEES MUST INSTALL ADDITIONAL UPGRADIENT SEDIMENT CONTROL PRACTICES OR REDUNDANT BMPS TO ELIMINATE THE OVERLOADING AND AMEND THE SWPPP TO IDENTIFY THESE ADDITIONAL
- 3. TEMPORARY OR PERMANENT DRAINAGE DITCHES AND SEDIMENT BASINS DESIGNED AS PART OF A SEDIMENT CONTAINMENT SYSTEM (E.G., DITCHES WITH ROCK-CHECK DAMS) REQUIRE SEDIMENT CONTROL PRACTICES ONLY AS
- APPROPRIATE FOR SITE CONDITIONS 4. A FLOATING SILT CURTAIN PLACED IN THE WATER IS NOT A SEDIMENT CONTROL BMP TO SATISFY ITEM 9.2 EXCEPT WHEN WORKING ON A SHORELINE OR BELOW THE WATERLINE. IMMEDIATELY AFTER THE SHORT TERM CONSTRUCTION ACTIVITY
- (E.G., INSTALLATION OF RIP RAP ALONG THE SHORELINE) IN THAT AREA IS COMPLETE, PERMITTEES MUST INSTALL AN UPLAND PERIMETER CONTROL PRACTICE IF EXPOSED SOILS STILL DRAIN TO A SURFACE WATER. 5. PERMITTEES MUST RE-INSTALL ALL SEDIMENT CONTROL PRACTICES ADJUSTED OR REMOVED TO ACCOMMODATE SHORT-TERM ACTIVITIES SUCH AS CLEARING OR GRUBBING, OR PASSAGE OF VEHICLES, IMMEDIATELY AFTER THE
- SHORT-TERM ACTIVITY IS COMPLETED. PERMITTEES MUST RE-INSTALL SEDIMENT CONTROL PRACTICES BEFORE THE NEXT PRECIPITATION EVENT EVEN IF THE SHORT-TERM ACTIVITY IS NOT COMPLETE. 6. PERMITTEES MUST PROTECT ALL STORM DRAIN INLETS USING APPROPRIATE BMPS DURING CONSTRUCTION UNTIL THEY
- ESTABLISH PERMANENT COVER ON ALL AREAS WITH POTENTIAL FOR DISCHARGING TO THE INLET. 7. PERMITTEES MAY REMOVE INLET PROTECTION FOR A PARTICULAR INLET IF A SPECIFIC SAFETY CONCERN (E.G. STREET FLOODING/FREEZING) IS IDENTIFIED BY THE PERMITTEES OR THE JURISDICTIONAL AUTHORITY (E.G.,
- CITY/COUNTY/TOWNSHIP/MINNESOTA DEPARTMENT OF TRANSPORTATION ENGINEER). PERMITTEES MUST DOCUMENT THE NEED FOR REMOVAL IN THE SWPPP 8. PERMITTEES MUST PROVIDE SILT FENCE OR OTHER EFFECTIVE SEDIMENT CONTROLS AT THE BASE OF STOCKPILES ON
- THE DOWNGRADIENT PERIMETER 9. PERMITTEES MUST LOCATE STOCKPILES OUTSIDE OF NATURAL BUFFERS OR SURFACE WATERS, INCLUDING STORMWATER CONVEYANCES SUCH AS CURB AND GUTTER SYSTEMS UNLESS THERE IS A BYPASS IN PLACE FOR THE
- 10. PERMITTEES MUST INSTALL A VEHICLE TRACKING BMP TO MINIMIZE THE TRACK OUT OF SEDIMENT FROM THE CONSTRUCTION SITE OR ONTO PAVED ROADS WITHIN THE SITE.
- 11. PERMITTEES MUST USE STREET SWEEPING IF VEHICLE TRACKING BMPS ARE NOT ADEQUATE TO PREVENT SEDIMENT TRACKING ONTO THE STREET
- 12. PERMITTEES MUST INSTALL TEMPORARY SEDIMENT BASINS AS REQUIRED IN SECTION 14.
- 13. IN ANY AREAS OF THE SITE WHERE FINAL VEGETATIVE STABILIZATION WILL OCCUR, PERMITTEES MUST RESTRICT VEHICLE AND EQUIPMENT USE TO MINIMIZE SOIL COMPACTION. 14. PERMITTEES MUST PRESERVE TOPSOIL ON THE SITE, UNLESS INFEASIBLE.
- 15. PERMITTEES MUST DIRECT DISCHARGES FROM BMPS TO VEGETATED AREAS UNLESS INFEASIBLE. 16, PERMITTEES MUST PRESERVE A 50 FOOT NATURAL BUFFER OR, IF A BUFFER IS INFEASIBLE ON THE SITE, PROVIDE REDUNDANT (DOUBLE) PERIMETER SEDIMENT CONTROLS WHEN A SURFACE WATER IS LOCATED WITHIN 50 FEET OF THE PROJECT'S EARTH DISTURBANCES AND STORMWATER FLOWS TO THE SURFACE WATER. PERMITTEES MUST INSTALL
- BUFFERS ARE NOT REQUIRED ADJACENT TO ROAD DITCHES. JUDICIAL DITCHES. COUNTY DITCHES. STORMWATER CONVEYANCE CHANNELS, STORM DRAIN INLETS, AND SEDIMENT BASINS. IF PRESERVING THE BUFFER IS INFEASIBLE PERMITTEES MUST DOCUMENT THE REASONS IN THE SWPPP. SHEET PILING IS A REDUNDANT PERIMETER CONTROL IF INSTALLED IN A MANNER THAT RETAINS ALL STORMWATER. 17. PERMITTEES MUST USE POLYMERS, FLOCCULANTS, OR OTHER SEDIMENTATION TREATMENT CHEMICALS IN ACCORDANCE

PERIMETER SEDIMENT CONTROLS AT LEAST 5 FEET APART UNLESS LIMITED BY LACK OF AVAILABLE SPACE. NATURAL

WITH ACCEPTED ENGINEERING PRACTICES, DOSING SPECIFICATIONS AND SEDIMENT REMOVAL DESIGN SPECIFICATIONS PROVIDED BY THE MANUFACTURER OR SUPPLIER. THE PERMITTEES MUST USE CONVENTIONAL EROSION AND SEDIMENT CONTROLS PRIOR TO CHEMICAL ADDITION AND MUST DIRECT TREATED STORMWATER TO A SEDIMENT CONTROL SYSTEM FOR FILTRATION OR SETTLEMENT OF THE FLOC PRIOR TO DISCHARGE.

## DEWATERING AND BASIN DRAINING (SECTION 10):

- 1. PERMITTEES MUST DISCHARGE TURBID OR SEDIMENT-LADEN WATERS RELATED TO DEWATERING OR BASIN DRAINING (E.G., PUMPED DISCHARGES, TRENCH/DITCH CUTS FOR DRAINAGE) TO A TEMPORARY OR PERMANENT SEDIMENT BASIN ON THE PROJECT SITE UNLESS INFEASIBLE. PERMITTEES MAY DEWATER TO SURFACE WATERS IF THEY VISUALLY CHECK TO ENSURE ADEQUATE TREATMENT HAS BEEN OBTAINED AND NUISANCE CONDITIONS (SEE MINN. R. 7050.0210, SUBP. 2) WILL NOT RESULT FROM THE DISCHARGE, IF PERMITTEES CANNOT DISCHARGE THE WATER TO A SEDIMENTATION BASIN PRIOR TO ENTERING A SURFACE WATER. PERMITTEES MUST TREAT IT WITH APPROPRIATE BMPS SUCH THAT THE
- DISCHARGE DOES NOT ADVERSELY AFFECT THE SURFACE WATER OR DOWNSTREAM PROPERTIES. 2. IF PERMITTEES MUST DISCHARGE WATER CONTAINING OIL OR GREASE, THEY MUST USE AN OIL-WATER SEPARATOR OR SUITABLE FILTRATION DEVICE (E.G., CARTRIDGE FILTERS, ABSORBENTS PADS) PRIOR TO DISCHARGE.
- 3. PERMITTEES MUST DISCHARGE ALL WATER FROM DEWATERING OR BASIN-DRAINING ACTIVITIES IN A MANNER THAT DOES NOT CAUSE EROSION OR SCOUR IN THE IMMEDIATE VICINITY OF DISCHARGE POINTS OR INUNDATION OF WETLANDS IN THE IMMEDIATE VICINITY OF DISCHARGE POINTS THAT CAUSES SIGNIFICANT ADVERSE IMPACT TO THE WETLAND.
- 4. IF PERMITTEES USE FILTERS WITH BACKWASH WATER, THEY MUST HAUL THE BACKWASH WATER AWAY FOR DISPOSA RETURN THE BACKWASH WATER TO THE BEGINNING OF THE TREATMENT PROCESS, OR INCORPORATE THE BACKWASH WATER INTO THE SITE IN A MANNER THAT DOES NOT CAUSE EROSION.

## INSPECTIONS AND MAINTENANCE (SECTION 11):

- 1. PERMITTEES MUST ENSURE A TRAINED PERSON, AS IDENTIFIED IN ITEM 21.2.B, WILL INSPECT THE ENTIRE CONSTRUCTION SITE AT LEAST ONCE EVERY SEVEN (7) DAYS DURING ACTIVE CONSTRUCTION AND WITHIN 24 HOURS AFTER A RAINFALL EVENT GREATER THAN 1/2 INCH IN 24 HOURS.
- 2. PERMITTEES MUST INSPECT AND MAINTAIN ALL PERMANENT STORMWATER TREATMENT BMPS. 3. PERMITTEES MUST INSPECT ALL EROSION PREVENTION AND SEDIMENT CONTROL BMPS AND POLLUTION PREVENTION MANAGEMENT MEASURES TO ENSURE INTEGRITY AND EFFECTIVENESS, PERMITTEES MUST REPAIR, REPLACE OR SUPPLEMENT ALL NONFUNCTIONAL BMPS WITH FUNCTIONAL BMPS BY THE END OF THE NEXT BUSINESS DAY AFTER
- DISCOVERY UNLESS ANOTHER TIME FRAME IS SPECIFIED IN ITEM 11.5 OR 11.6. PERMITTEES MAY TAKE ADDITIONAL TIME IF SLOPES FIELD CONDITIONS PREVENT ACCESS TO THE AREA. 4. DURING EACH INSPECTION, PERMITTEES MUST INSPECT SURFACE WATERS, INCLUDING DRAINAGE DITCHES AND CONVEYANCE SYSTEMS BUT NOT CURB AND GUTTER SYSTEMS, FOR EVIDENCE OF EROSION AND SEDIMENT DEPOSITION. • SEE PLAN FOR MORE DETAILED DITCH AND STEEP SLOPE EROSION CONTROL TREATMENTS. PERMITTEES MUST REMOVE ALL DELTAS AND SEDIMENT DEPOSITED IN SURFACE WATERS, INCLUDING DRAINAGE WAYS,
- CATCH BASINS. AND OTHER DRAINAGE SYSTEMS AND RESTABILIZE THE AREAS WHERE SEDIMENT REMOVAL RESULTS IN EXPOSED SOIL. PERMITTEES MUST COMPLETE REMOVAL AND STABILIZATION WITHIN SEVEN (7) CALENDAR DAYS OF DISCOVERY UNLESS PRECLUDED BY LEGAL, REGULATORY, OR PHYSICAL ACCESS CONSTRAINTS. PERMITTEES MUST USE ALL REASONABLE EFFORTS TO OBTAIN ACCESS. IF PRECLUDED, REMOVAL AND STABILIZATION MUST TAKE PLACE WITHIN SEVEN (7) DAYS OF OBTAINING ACCESS, PERMITTEES ARE RESPONSIBLE FOR CONTACTING ALL LOCAL, REGIONAL, STATE AND FEDERAL AUTHORITIES AND RECEIVING ANY APPLICABLE PERMITS, PRIOR TO CONDUCTING ANY WORK IN SURFACE
- WATERS. 5. PERMITTEES MUST INSPECT CONSTRUCTION SITE VEHICLE EXIT LOCATIONS, STREETS AND CURB AND GUTTER SYSTEMS WITHIN AND ADJACENT TO THE PROJECT FOR SEDIMENTATION FROM EROSION OR TRACKED SEDIMENT FROM VEHICLES. PERMITTEES MUST REMOVE SEDIMENT FROM ALL PAVED SURFACES WITHIN ONE (1) CALENDAR DAY OF DISCOVERY OR. IF APPLICABLE, WITHIN A SHORTER TIME TO AVOID A SAFETY HAZARD TO USERS OF PUBLIC STREETS.
- 6. PERMITTEES MUST REPAIR, REPLACE OR SUPPLEMENT ALL PERIMETER CONTROL DEVICES WHEN THEY BECOME NONFUNCTIONAL OR THE SEDIMENT REACHES 1/2 OF THE HEIGHT OF THE DEVICE. 7. PERMITTEES MUST DRAIN TEMPORARY AND PERMANENT SEDIMENTATION BASINS AND REMOVE THE SEDIMENT WHEN THE
- DEPTH OF SEDIMENT COLLECTED IN THE BASIN REACHES 1/2 THE STORAGE VOLUME. 8. PERMITTEES MUST ENSURE THAT AT LEAST ONE INDIVIDUAL PRESENT ON THE SITE (OR AVAILABLE TO THE PROJECT SITE IN THREE (3) CALENDAR DAYS) IS TRAINED IN THE JOB DUTIES DESCRIBED IN ITEM 21.2.B. 9. PERMITTEES MAY ADJUST THE INSPECTION SCHEDULE DESCRIBED IN ITEM 11.2 AS FOLLOWS
- a. INSPECTIONS OF AREAS WITH PERMANENT COVER CAN BE REDUCED TO ONCE PER MONTH, EVEN IF CONSTRUCTION ACTIVITY CONTINUES ON OTHER PORTIONS OF THE SITE; OR b. WHERE SITES HAVE PERMANENT COVER ON ALL EXPOSED SOIL AND NO CONSTRUCTION ACTIVITY IS OCCURRING ANYWHERE ON THE SITE, INSPECTIONS CAN BE REDUCED TO ONCE PER MONTH AND, AFTER 12 MONTHS, MAY BE
- RESUME IF CONDITIONS WARRANT; OR c. WHERE CONSTRUCTION ACTIVITY HAS BEEN SUSPENDED DUE TO FROZEN GROUND CONDITIONS, INSPECTIONS MAY BE SUSPENDED. INSPECTIONS MUST RESUME WITHIN 24 HOURS OF RUNOFF OCCURRING, OR UPON RESUMING

SUSPENDED COMPLETELY UNTIL CONSTRUCTION ACTIVITY RESUMES. THE MPCA MAY REQUIRE INSPECTIONS TO

- CONSTRUCTION, WHICHEVER COMES FIRST. 10. PERMITTEES MUST RECORD ALL INSPECTIONS AND MAINTENANCE ACTIVITIES WITHIN 24 HOURS OF BEING CONDUCTED AND THESE RECORDS MUST BE RETAINED WITH THE SWPPP. THESE RECORDS MUST INCLUDE:
- a. DATE AND TIME OF INSPECTIONS; AND b. NAME OF PERSONS CONDUCTING INSPECTIONS; AND
- c. ACCURATE FINDINGS OF INSPECTIONS, INCLUDING THE SPECIFIC LOCATION WHERE CORRECTIVE ACTIONS ARE NEEDED; AND
- d. CORRECTIVE ACTIONS TAKEN (INCLUDING DATES, TIMES, AND PARTY COMPLETING MAINTENANCE ACTIVITIES); AND e. DATE OF ALL RAINFALL EVENTS GREATER THAN 1/2 INCHES IN 24 HOURS, AND THE AMOUNT OF RAINFALL FOR EACH EVENT. PERMITTEES MUST OBTAIN RAINFALL AMOUNTS BY EITHER A PROPERLY MAINTAINED RAIN GAUGE INSTALLED ONSITE, A WEATHER STATION THAT IS WITHIN ONE (1) MILE OF YOUR LOCATION, OR A WEATHER REPORTING SYSTEM THAT PROVIDES SITE SPECIFIC RAINFALL DATA FROM RADAR SUMMARIES; AND
- f. IF PERMITTEES OBSERVE A DISCHARGE DURING THE INSPECTION, THEY MUST RECORD AND SHOULD PHOTOGRAPH AND DESCRIBE THE LOCATION OF THE DISCHARGE (I.E., COLOR, ODOR, SETTLED OR SUSPENDED SOLIDS, OIL SHEEN, AND OTHER OBVIOUS INDICATORS OF POLLUTANTS); AND
- g. ANY AMENDMENTS TO THE SWPPP PROPOSED AS A RESULT OF THE INSPECTION MUST BE DOCUMENTED AS REQUIRED IN SECTION 6 WITHIN SEVEN (7) CALENDAR DAYS.

- 1. PERMITTEES MUST PLACE BUILDING PRODUCTS AND LANDSCAPE MATERIALS UNDER COVER (E.G., PLASTIC SHEETING OR TEMPORARY ROOFS) OR PROTECT THEM BY SIMILARLY EFFECTIVE MEANS DESIGNED TO MINIMIZE CONTACT WITH STORMWATER. PERMITTEES ARE NOT REQUIRED TO COVER OR PROTECT PRODUCTS WHICH ARE EITHER NOT A SOURCE OF CONTAMINATION TO STORMWATER OR ARE DESIGNED TO BE EXPOSED TO STORMWATER.
- 2. PERMITTEES MUST PLACE PESTICIDES, FERTILIZERS AND TREATMENT CHEMICALS UNDER COVER (E.G., PLASTIC SHEETING OR TEMPORARY ROOFS) OR PROTECT THEM BY SIMILARLY EFFECTIVE MEANS DESIGNED TO MINIMIZE CONTACT WITH STORMWATER.
- 3. PERMITTEES MUST STORE HAZARDOUS MATERIALS AND TOXIC WASTE, (INCLUDING OIL, DIESEL FUEL, GASOLINE, HYDRAULIC FLUIDS, PAINT SOLVENTS, PETROLEUM-BASED PRODUCTS, WOOD PRESERVATIVES, ADDITIVES, CURING COMPOUNDS, AND ACIDS) IN SEALED CONTAINERS TO PREVENT SPILLS, LEAKS OR OTHER DISCHARGE. STORAGE AND DISPOSAL OF HAZARDOUS WASTE MATERIALS MUST BE IN COMPLIANCE WITH MINN. R. CH. 7045 INCLUDING SECONDARY CONTAINMENT AS APPLICABLE
- 4. PERMITTEES MUST PROPERLY STORE, COLLECT AND DISPOSE SOLID WASTE IN COMPLIANCE WITH MINN. R. CH. 7035. 5. PERMITTEES MUST POSITION PORTABLE TOILETS SO THEY ARE SECURE AND WILL NOT TIP OR BE KNOCKED OVER. PERMITTEES MUST PROPERLY DISPOSE SANITARY WASTE IN ACCORDANCE WITH MINN. R. CH. 7041. 6. PERMITTEES MUST TAKE REASONABLE STEPS TO PREVENT THE DISCHARGE OF SPILLED OR LEAKED CHEMICALS,
- INCLUDING FUEL, FROM ANY AREA WHERE CHEMICALS OR FUEL WILL BE LOADED OR UNLOADED INCLUDING THE USE OF DRIP PANS OR ABSORBENTS UNLESS INFEASIBLE. PERMITTEES MUST ENSURE ADEQUATE SUPPLIES ARE AVAILABLE AT ALL TIMES TO CLEAN UP DISCHARGED MATERIALS AND THAT AN APPROPRIATE DISPOSAL METHOD IS AVAILABLE FOR RECOVERED SPILLED MATERIALS. PERMITTEES MUST REPORT AND CLEAN UP SPILLS IMMEDIATELY AS REQUIRED BY MINN. STAT. 115.061, USING DRY CLEAN UP MEASURES WHERE POSSIBLE.
- 7. PERMITTEES MUST LIMIT VEHICLE EXTERIOR WASHING AND EQUIPMENT TO A DEFINED AREA OF THE SITE. PERMITTEES MUST CONTAIN RUNOFF FROM THE WASHING AREA IN A SEDIMENT BASIN OR OTHER SIMILARLY EFFECTIVE CONTROLS AND MUST DISPOSE WASTE FROM THE WASHING ACTIVITY PROPERLY. PERMITTEES MUST PROPERLY USE AND STORE SOAPS, DETERGENTS, OR SOLVENTS.
- 8. PERMITTEES MUST PROVIDE EFFECTIVE CONTAINMENT FOR ALL LIQUID AND SOLID WASTES GENERATED BY WASHOUT OPERATIONS (E.G., CONCRETE, STUCCO, PAINT, FORM RELEASE OILS, CURING COMPOUNDS AND OTHER CONSTRUCTION MATERIALS) RELATED TO THE CONSTRUCTION ACTIVITY PERMITTEES MUST PREVENT LIQUID AND SOLID WASHOUT WASTES FROM CONTACTING THE GROUND AND MUST DESIGN THE CONTAINMENT SO IT DOES NOT RESULT IN RUNOFF FROM THE WASHOUT OPERATIONS OR AREAS, PERMITTEES MUST PROPERLY DISPOSE LIQUID AND SOLID WASTES IN COMPLIANCE WITH MPCA RULES. PERMITTEES MUST INSTALL A SIGN INDICATING THE LOCATION OF THE WASHOUT

## PERMIT TERMINATION (SECTION 4 AND SECTION 13):

- 1. PERMITTEES MUST SUBMIT A NOT WITHIN 30 DAYS AFTER ALL TERMINATION CONDITIONS LISTED IN SECTION 13 ARE
- 2. PERMITTEES MUST SUBMIT A NOT WITHIN 30 DAYS AFTER SELLING OR OTHERWISE LEGALLY TRANSFERRING THE ENTIRE SITE, INCLUDING PERMIT RESPONSIBILITY FOR ROADS (E.G., STREET SWEEPING) AND STORMWATER INFRASTRUCTURE FINAL CLEAN OUT, OR TRANSFERRING PORTIONS OF A SITE TO ANOTHER PARTY. THE PERMITTEES' COVERAGE UNDER THIS PERMIT TERMINATES AT MIDNIGHT ON THE SUBMISSION DATE OF THE NOT.
- 3. PERMITTEES MUST COMPLETE ALL CONSTRUCTION ACTIVITY AND MUST INSTALL PERMANENT COVER OVER ALL AREAS PRIOR TO SUBMITTING THE NOT. VEGETATIVE COVER MUST CONSIST OF A UNIFORM PERENNIAL VEGETATION WITH A DENSITY OF 70 PERCENT OF ITS EXPECTED FINAL GROWTH. VEGETATION IS NOT REQUIRED WHERE THE FUNCTION OF A SPECIFIC AREA DICTATES NO VEGETATION, SUCH AS IMPERVIOUS SURFACES OR THE BASE OF A SAND FILTER. 4. PERMITTEES MUST CLEAN THE PERMANENT STORMWATER TREATMENT SYSTEM OF ANY ACCUMULATED SEDIMENT AND MUST ENSURE THE SYSTEM MEETS ALL APPLICABLE REQUIREMENTS IN SECTION 15 THROUGH 19 AND IS OPERATING AS
- 5. PERMITTEES MUST REMOVE ALL SEDIMENT FROM CONVEYANCE SYSTEMS PRIOR TO SUBMITTING THE NOT. 6. PERMITTEES MUST REMOVE ALL TEMPORARY SYNTHETIC EROSION PREVENTION AND SEDIMENT CONTROL BMPS PRIOR
- TO SUBMITTING THE NOT. PERMITTEES MAY LEAVE BMPS DESIGNED TO DECOMPOSE ON-SITE IN PLACE. 7. FOR RESIDENTIAL CONSTRUCTION ONLY, PERMIT COVERAGE TERMINATES ON INDIVIDUAL LOTS IF THE STRUCTURES ARE FINISHED AND TEMPORARY EROSION PREVENTION AND DOWNGRADIENT PERIMETER CONTROL IS COMPLETE, THE RESIDENCE SELLS TO THE HOMEOWNER, AND THE PERMITTEE DISTRIBUTES THE MPCA'S "HOMEOWNER FACT SHEET" TO THE HOMEOWNER.
- 8. FOR CONSTRUCTION PROJECTS ON AGRICULTURAL LAND (E.G., PIPELINES ACROSS CROPLAND), PERMITTEES MUST RETURN THE DISTURBED LAND TO ITS PRECONSTRUCTION AGRICULTURAL USE PRIOR TO SUBMITTING THE NOT.

#### SEED NOTES:

ALL SEED MIXES AND APPLICATION SHALL BE IN ACCORDANCE WITH THE MNDOT SEEDING MANUAL.

## GENERAL RECOMMENDATIONS:

THE CONTRACTOR IS RESPONSIBLE TO SALVAGE AND PRESERVE EXISTING TOPSOIL NECESSARY FOR FINAL STABILIZATION AND TO ALSO MINIMIZE COMPACTION IN ALL LANDSCAPE AREAS. IMMEDIATELY BEFORE SEEDING THE SOIL SHALL BE TILLED TO A MINIMUM DEPTH OF 3 INCHES.

## TEMPORARY EROSION CONTROL SEEDING, MULCHING & BLANKET

## TEMPORARY SEED SHALL BE MNDOT SEED MIX 21-112 (WINTER WHEAT COVER CROP) FOR WINTER AND 21-111 (OATS) COVER CROP) FOR SPRING/SUMMER APPLICATIONS. BOTH SEED MIXES SHALL BE APPLIED AT A SEEDING RATE OF 100

IMMEDIATELY AFTER SEEDING, WITHIN 24 HOURS, MNDOT TYPE 1 MULCH SHOULD BE APPLIED TO PROTECT AND ENHANCE SEED GERMINATION. MULCH SHALL BE APPLIED AT 90% COVERAGE (2 TONS PER ACRE OF STRAW MULCH)

## • 3:1 (HORIZ/VERT.) OR FLATTER MUCH SHALL BE COVERED WITH MULCH

# SLOPES STEEPER THAN 3:1 OR DITCH BOTTOMS SHALL BE COVERED WITH EROSION CONTROL BLANKET.

## **TRAINING SECTION 21**

DESIGN ENGINEER: MATTHEW R. PAVEK P.E. TRAINING COURSE: DESIGN OF SWPPP TRAINING ENTITY: UNIVERSITY OF MINNESOTA INSTRUCTOR: JOHN CHAPMAN DATES OF TRAINING COURSE: 5/15/2011 - 5/16/2011

TOTAL TRAINING HOURS: 12 RE-CERTIFICATION: 2/27/2020 (8 HOURS), EXP. 5/31/2023

## OWNER INFORMATION

JWT LAKE ST. LLC 2400 BLAISDELL AVE. MINNEAPOLIS, MN 55404

#### AREAS AND QUANTITIES:

SITE AREA CALCULATIONS				
	EXISTIN	G	PROPOS	ED
BUILDING COVERAGE	2,265 SF	41.7%	2,973 SF	54.7%
ALL PAVEMENTS	2,660 SF	48.9%	1,695 SF	31.2%
ALL NON-PAVEMENTS	512 SF	9.4%	465 SF	8.6%
TOTAL SITE AREA	5,437 SF	100.0%	5,437 SF	94.4%

IMPERVIOUS SURFACE		
EXISTING CONDITION	4,925 SF	90.6%
PROPOSED CONDITION	4,668 SF	85.9%
DIFFERENCE (EX. VS PROP.)	-257 SF	-4.7%
IMPERVIOUS TOTAL	4,668 SF	85.9%
EDOSION CONTROL OLIANTITIES		

EROSION CONTROL QUANTITIES	
DISTURBED AREA	7,539 SF
SILT FENCE/BIO-ROLL	386 LF
EROSION CONTROL BLANKET	0 SF
INLET PROTECTION DEVICES	0± EA

NOTE: QUANTITIES ARE FOR INFORMATIONAL PURPOSES ONLY. CONTRACTOR SHALL DETERMINE FOR THEMSELVES THE EXACT QUANTITIES FOR BIDDING AND CONSTRUCTION.

## SWPPP CONTACT PERSON

CONTRACTOR

SWPPP INSPECTOR TRAINING: ALL SWPPP INSPECTIONS MUST BE PERFORMED BY A PERSON THAT MEETS THE TRAINING REQUIREMENTS OF THE NPDES CONSTRUCTION SITE PERMIT TRAINING CREDENTIALS SHALL BE PROVIDED BY THE CONTRACTOR AND KEPT ON SITE WITH THE SWPPP

## PARTY RESPONSIBLE FOR LONG TERM OPERATION AND MAINTENANCE OF PERMANENT STORM WATER MANAGEMENT SYSTEM

PERMANENT STORMWATER MANAGEMENT IS NOT REQUIRED AS PART OF THIS PROJECT TO MEET NPDES PERMIT REQUIREMENTS. THE PROPERTY OWNER IS RESPONSIBLE FOR THE LONG TERM OPERATION AND MAINTENANCE OF THE PROPOSED STORMWATER SYSTEM.

## SWPPP ATTACHMENTS (ONLY APPLICABLE IF SITE IS 1 ACRE OR GREATER):

- CONTRACTOR SHALL OBTAIN A COPY OF THE FOLLOWING SWPPP ATTACHMENTS WHICH ARE A PART OF THE OVERALL SWPPP PACKAGE: ATTACHMENT A. CONSTRUCTION SWPPP TEMPLATE - SITE SPECIFIC SWPPP DOCUMENT
- ATTACHMENT B. CONSTRUCTION STORMWATER INSPECTION CHECKLIST
- ATTACHMENT C. MAINTENANCE PLAN FOR PERMANENT STORM WATER TREATMENT SYSTEMS ATTACHMENT D: STORMWATER MANAGEMENT REPORT - ON FILE AT THE OFFICE OF PROJECT ENGINEER. AVAILABLE UPON REQUEST. ATTACHMENT E: GEOTECHNICAL EVALUATION REPORT - ON FILE AT THE OFFICE OF PROJECT ENGINEER. AVAILABLE UPON REQUEST.

## SUPPLEMENTARY SITE SPECIFIC EROSION CONTROL NOTES: THESE NOTES SUPERCEDE ANY GENERAL SWPPP NOTES.

THIS PROJECT IS LESS THAN 1.0 ACRES SO AN NPDES PERMIT IS NOT REQUIRED.

# PROJECT NARRATIVE:

PROJECT IS A REDEVELOPMENT OF AN EXISTING SINGLE STORY COMMERCIAL BUILDING INTO A TWO STORY RESIDENTIAL BUILDING. SITE AND LANDSCAPE IMPROVEMENTS WILL OCCUR.

## NATIVE BUFFER NARRATIVE:

INFILTRATION NARRATIVE:

PRESERVING A 50' NATURAL BUFFER AROUND WATER BODIES IS NOT REQUIRED AS PART OF THIS PROJECT BECAUSE WATER BODIES ARE NOT

## INFILTRATION IS NOT REQUIRED AS PART OF THE PROJECT BECAUSE PERMANENT STORM WATER MANAGEMENT IS NOT REQUIRED.

SOIL CONTAMINATION NARRATIVE: SOILS ONSITE HAVE NOT BEEN IDENTIFIED AS CONTAMINATED. AN MPCA SOILS ASSESSMENT WAS COMPLETED AND IT WAS DETERMINED THAT

## THIS SITE IS APPROPRIATE FOR INFILTRATION.

SPECIAL TMDL BMP REQUIREMENTS SITE SPECIFIC (IF REQUIRED):

THIS PROJECT IS NOT WITHIN ONE MILE OF A WATER BODY AND DOES NOT DIRECTLY DISCHARGES TO ANY NEAR BY WATER BODIES.

PERMANENT STABILIZATION NOTES SITE SPECIFIC:

 FOR THIS PROJECT ALL AREAS THAT ARE NOT TO BE SODDED OR LANDSCAPED SHALL RECEIVE A NATIVE PERMANENT SEED MIX. AREAS IN BUFFERS AND ADJACENT TO OR IN WET AREAS MNDOT SEED MIX 33-261 (STORMWATER SOUTH AND WEST) AT 35 LBS PER

DRY AREAS MNDOT SEED MIX 35-221 (DRY PRAIRIE GENERAL) AT 40 LBS PER ACRE.

MAINTENANCE SHALL BE IN ACCORDANCE TO THE MNDOT SEEDING MANUAL.

12/11/2020 3:28 PM

4931 W. 35th Street, Suite 200

St. Louis Park, MN 55416 civilsitegroup.com

I HEREBY CERTIFY THAT THIS PLAN SPECIFICATION, OR REPORT WAS PREPARED BY ME OR UNDER MY DIRECT SUPERVISION AND THAT I AM A DULY LICENSED PROFESSIONAL ENGINEER UNDER THE LAWS OF THE STATE OF MINNESOTA.

Matthew R. Pavek DATE 12/14/20 LICENSE NO. 44263 ISSUE/SUBMITTAL SUMMARY

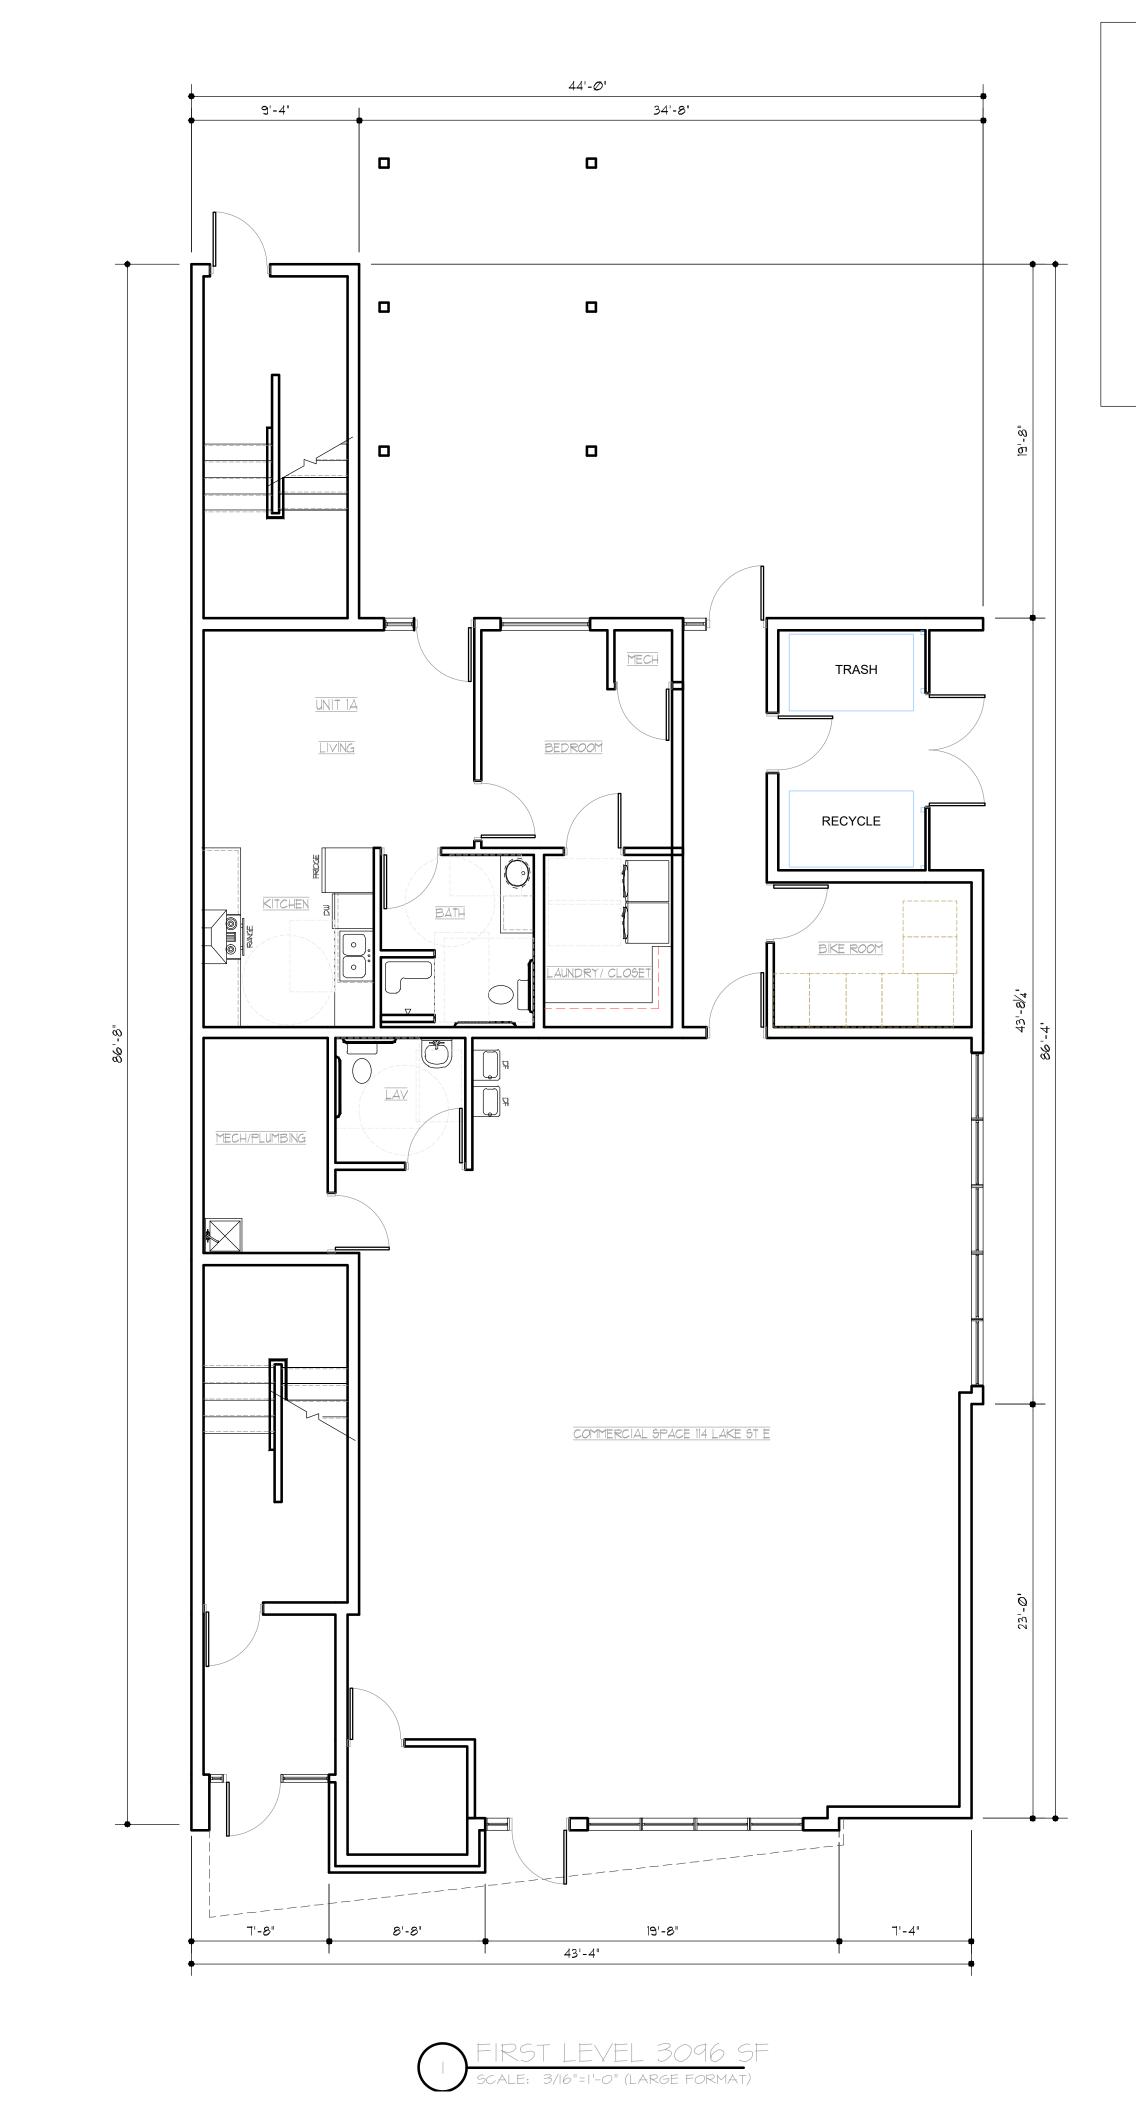
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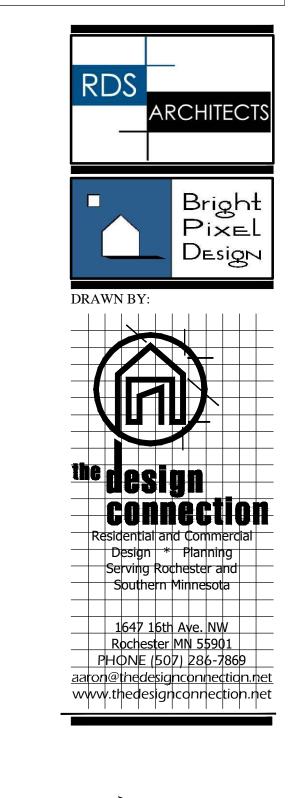
DRAWN BY:KB. KW REVIEWED BY: MP

**REVISION SUMMARY** DATE DESCRIPTION

PROJECT NUMBER: 20267

SWPPP - NARRATIVE

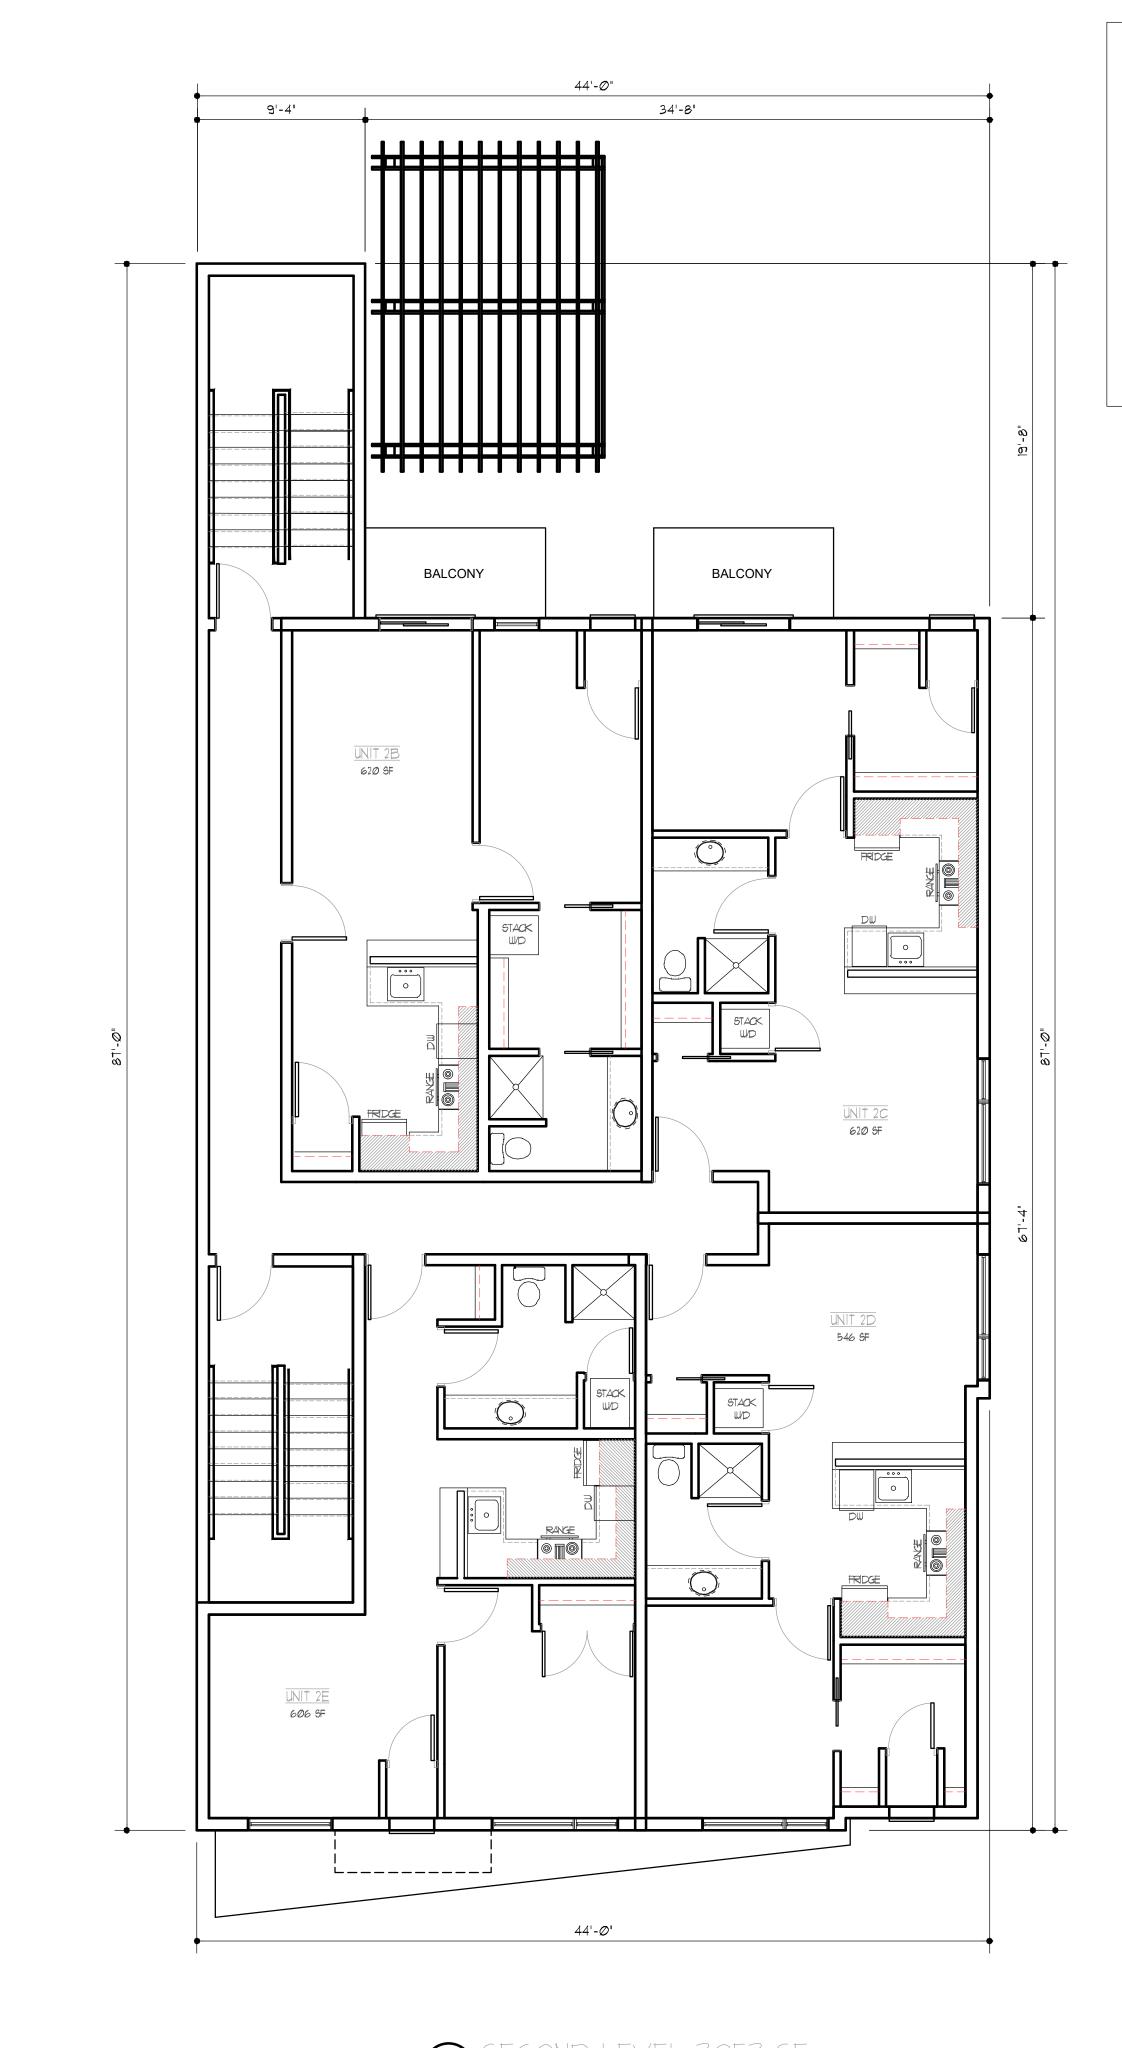


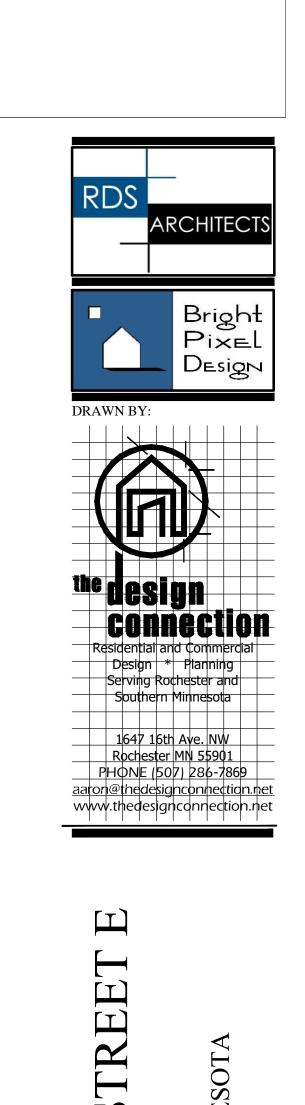


CDE
MJB

A1.0

FIRST LEVEL







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PRINTED:	Dec

A2.0

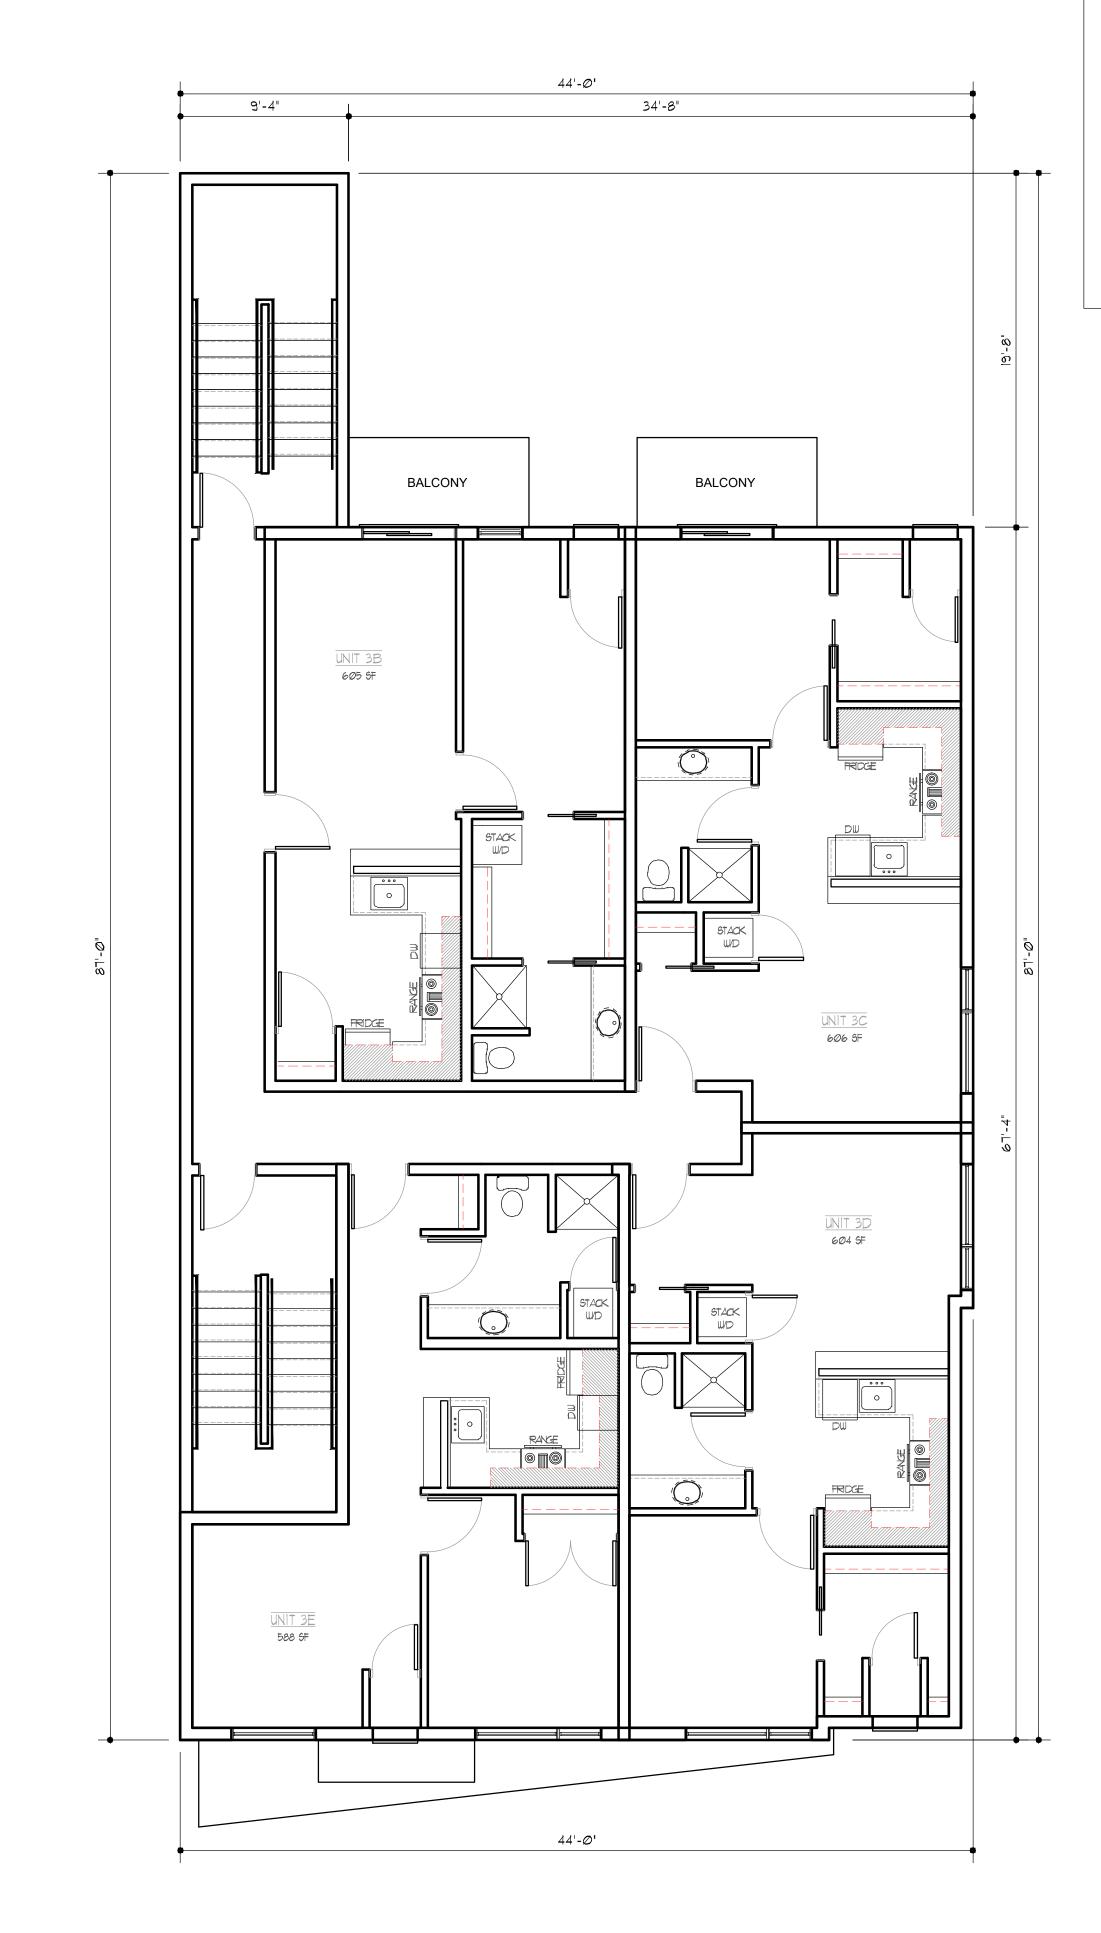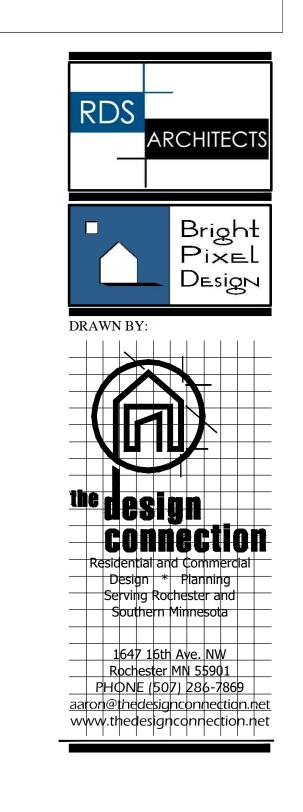SECOND LEVEL







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PRINTED:	Dec 1

A3.0

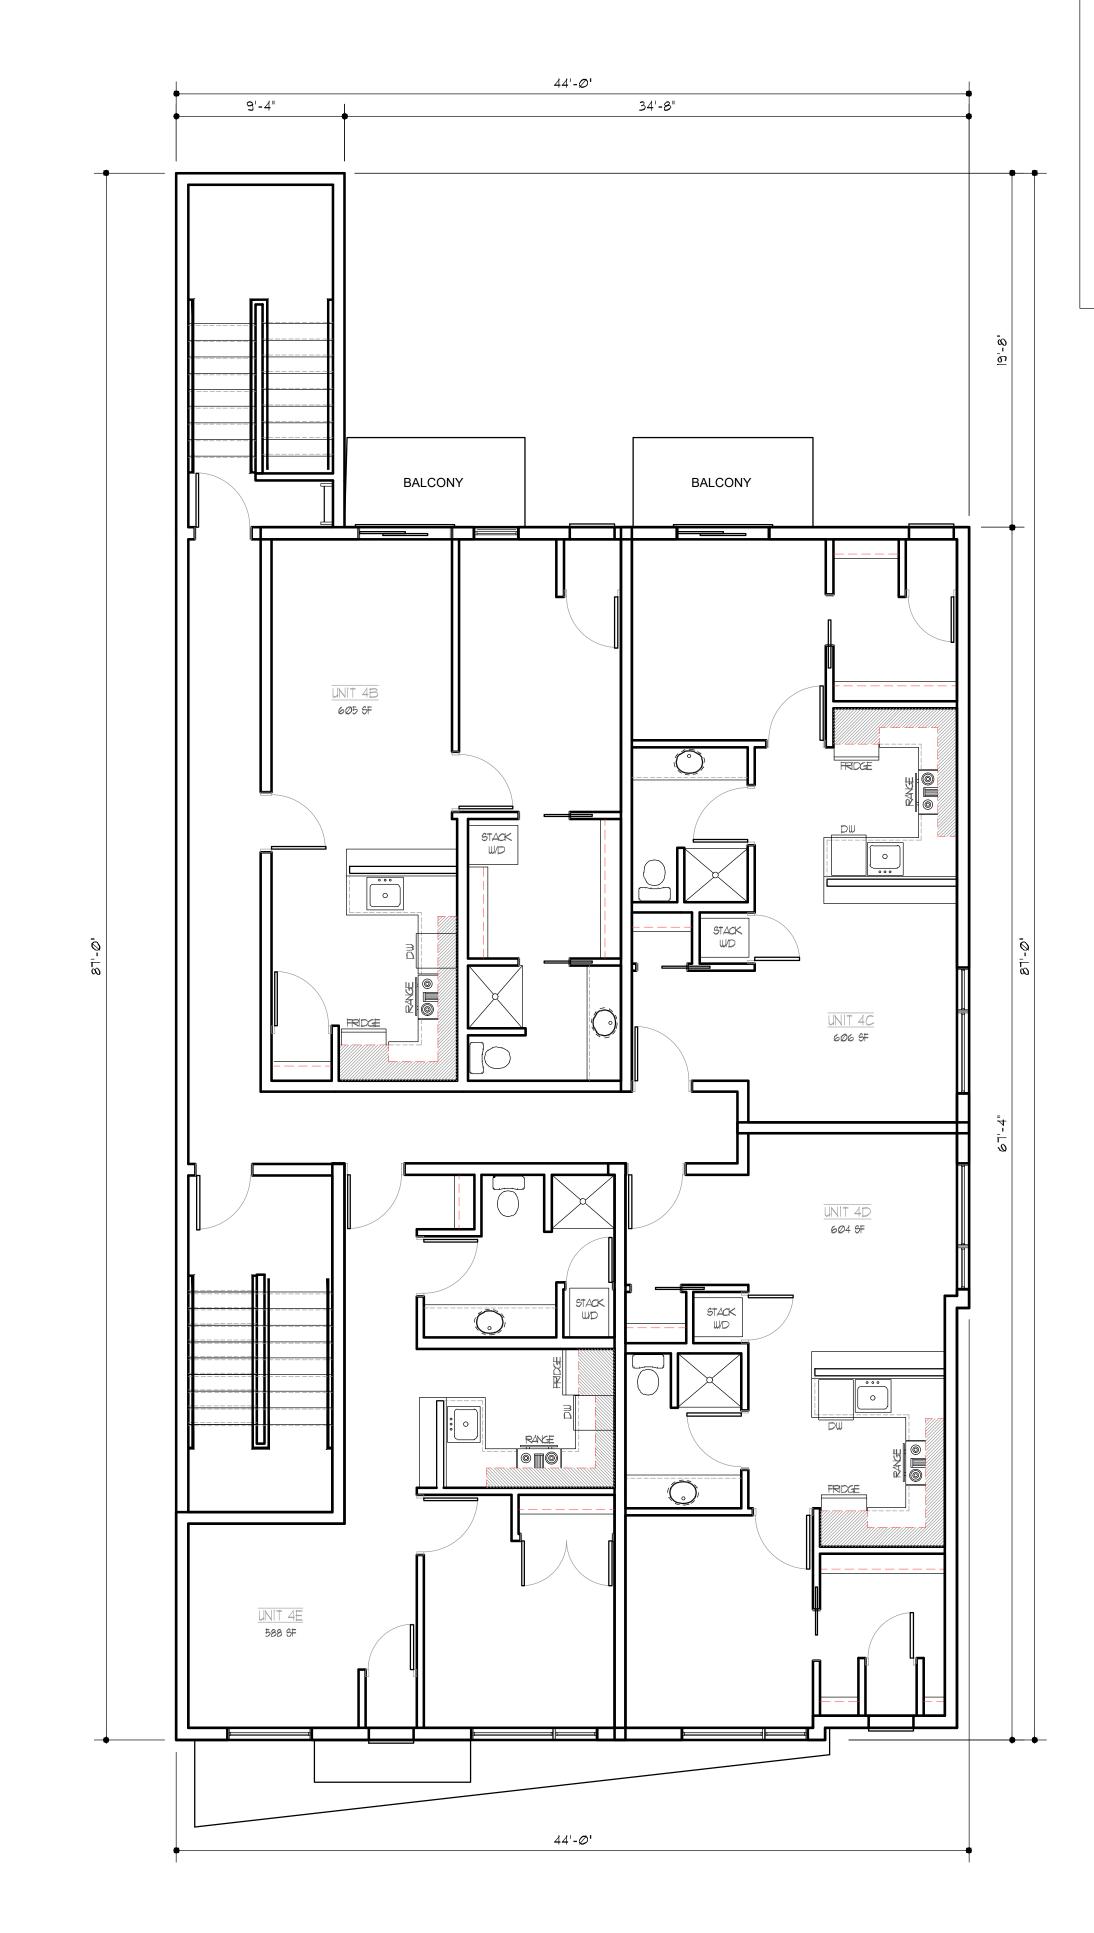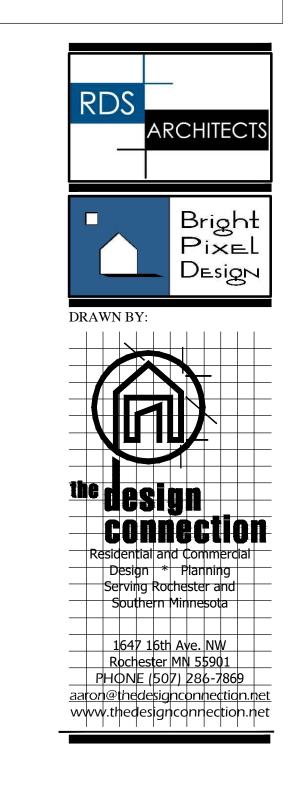THIRD LEVEL







PROJECT#:	20258
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CHECKED BY:	MJB CD
FINAL DATE:	

A4.0

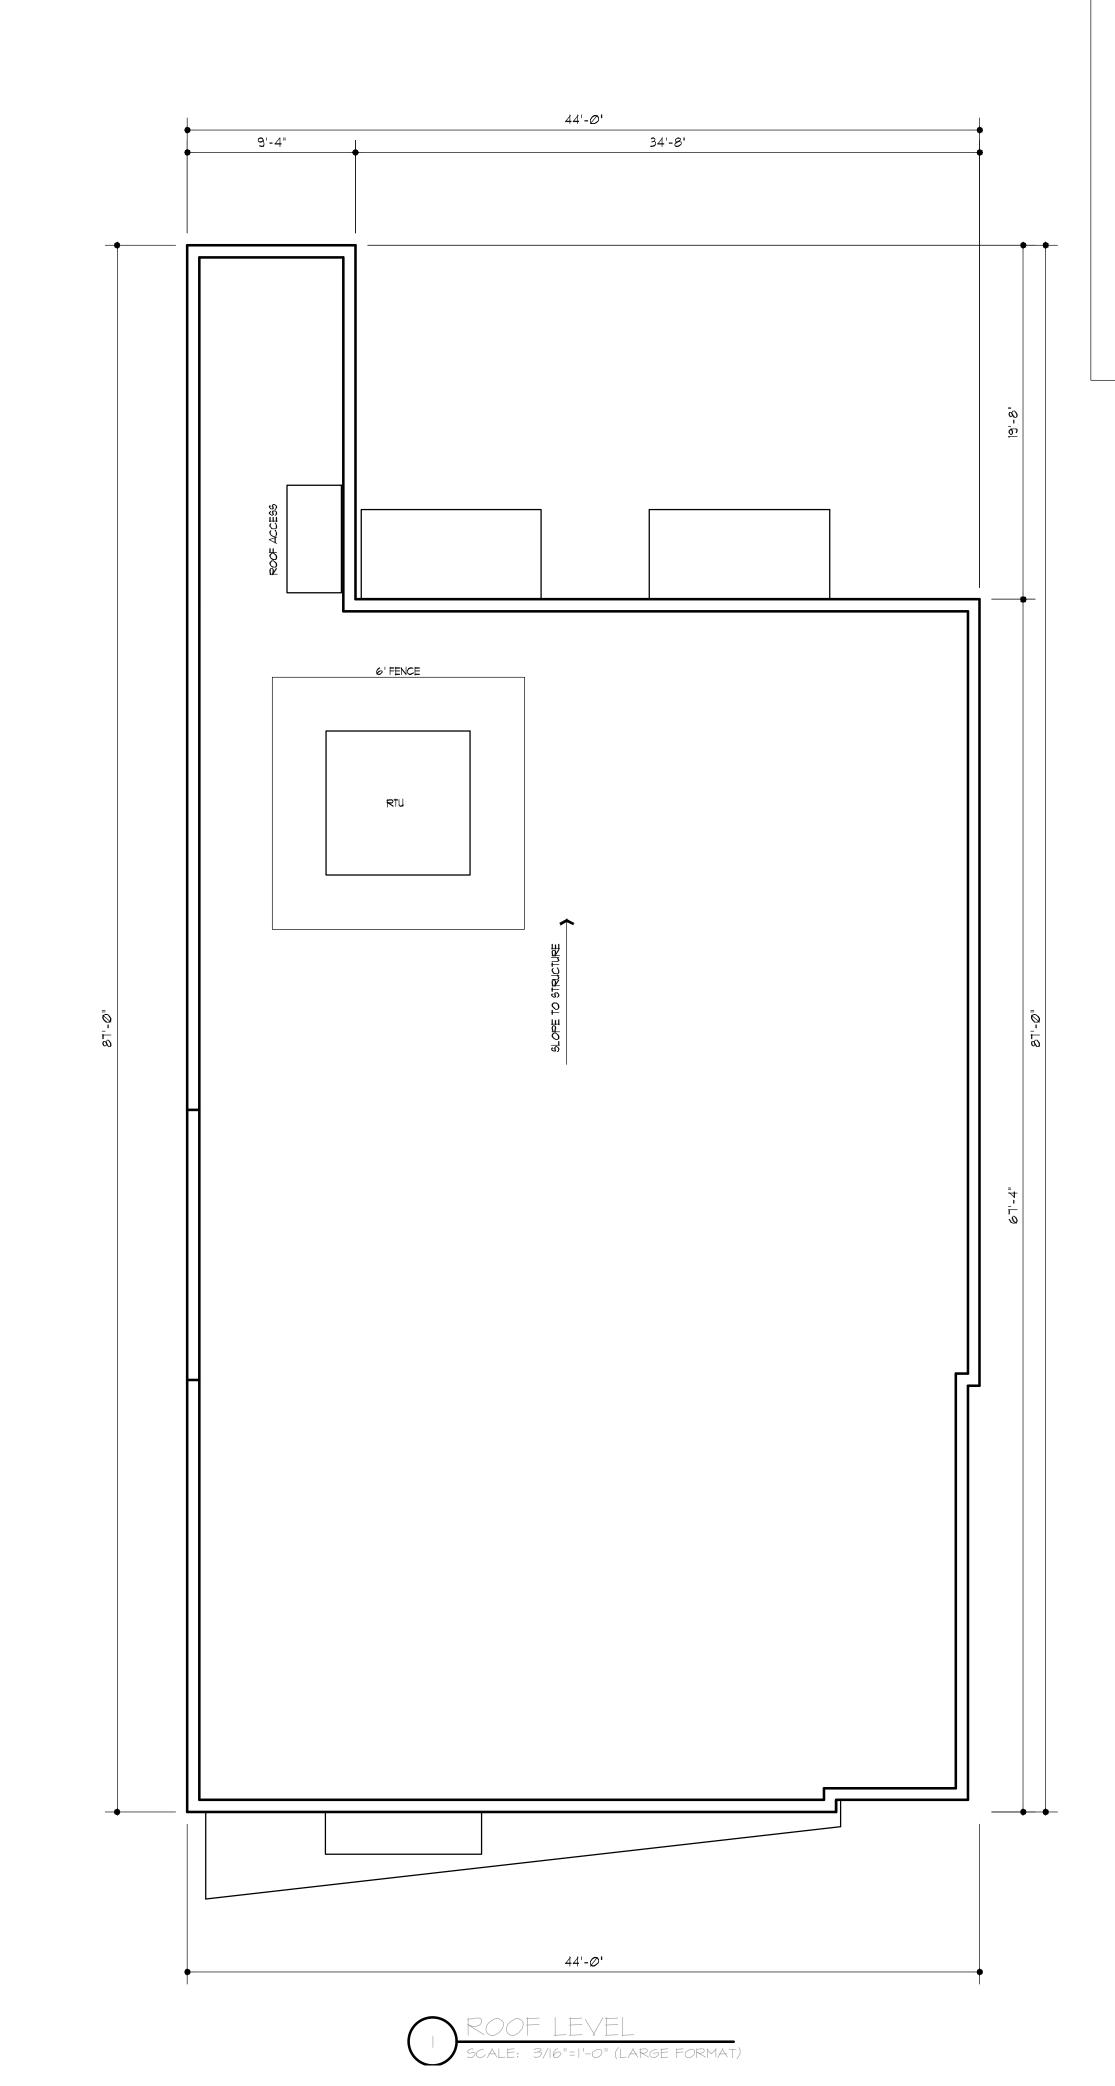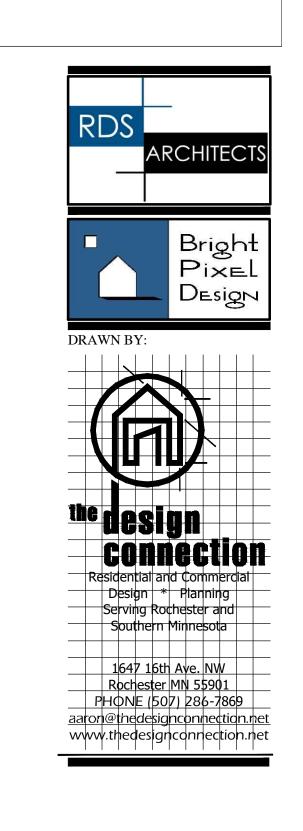FOURTH LEVEL







PROÆCT#;	20258
DRAWN BY:	CDB / IJN
CHECKED BY:	MJB CDE
FINAL DATE:	

PRINTED: Dec 14, 2020

ROOF LEVEL

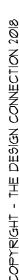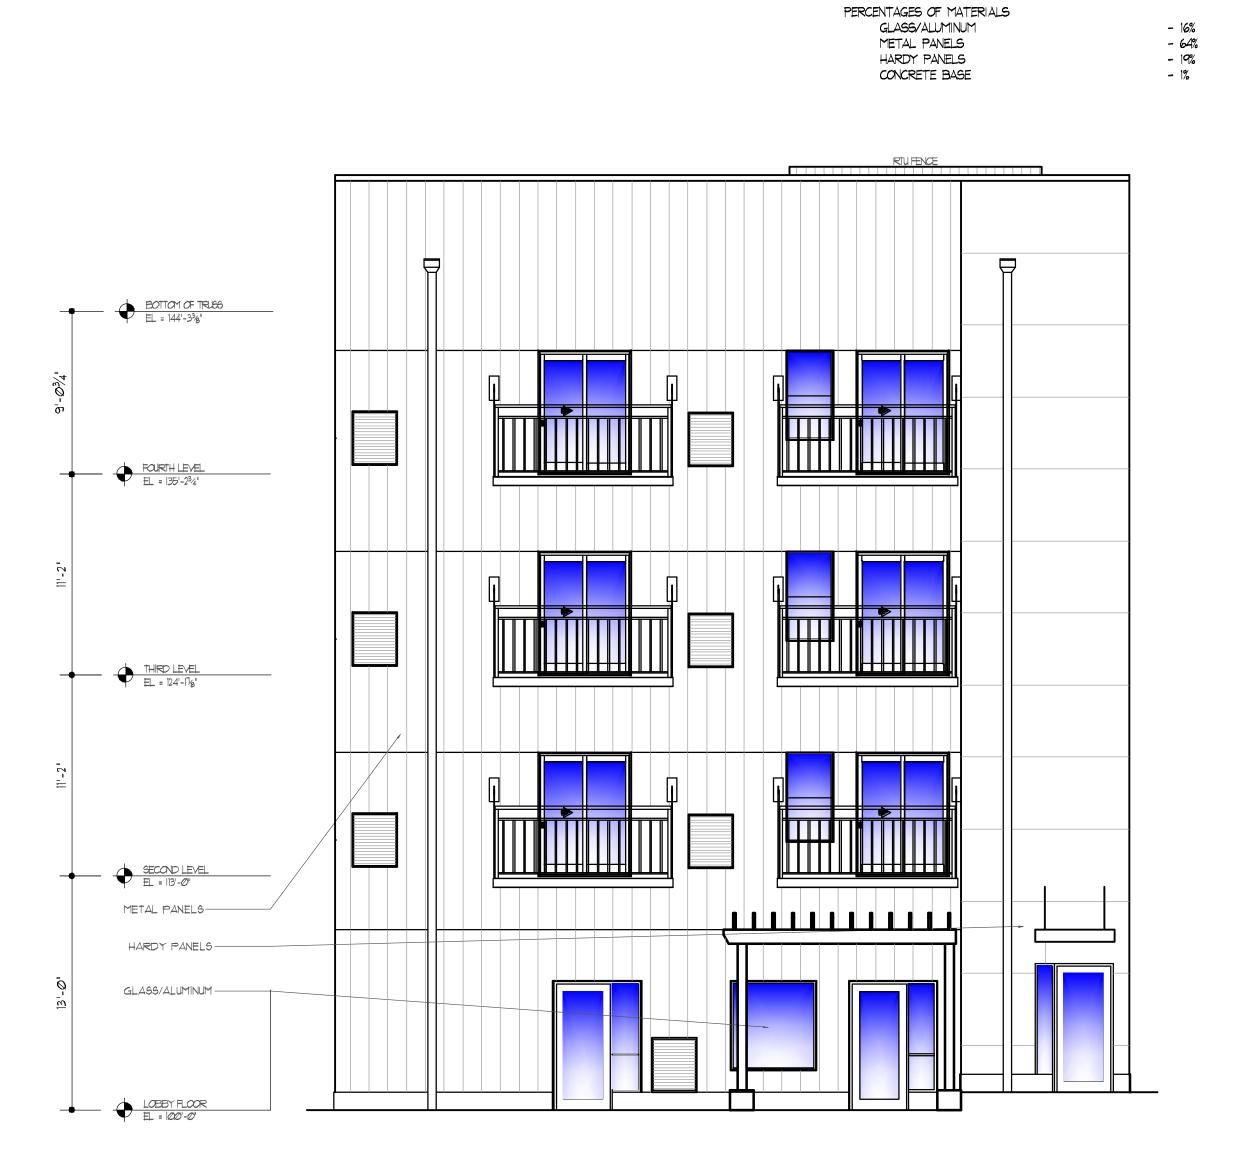A5.0





TOTAL ELEVATION AREA - 2282 SF

BOTTOM OF TRU66

EL = 144'-33%" FOURTH LEVEL EL = 135'-234' THIRD LEVEL
EL = 124'-17g' SIGNAGE SECOND LEVEL
EL = 113'-0' METAL PANELS -

PETERSEN PAC-CLAD WOOD— LOOK METAL PANEL SUGAR MAPEL

TOTAL ELEVATION AREA - 2292 SF

WOOD PANEL CONCRETE BASE COLORED METAL PANEL

- 23% - 4% - 53% - 16%

- 1% - 3%

PERCENTAGES OF MATERIALS GLASS/ALUMINUM

METAL PANELS

BRICK

ARCHITECTS Bright Pixel Design DRAWN BY: Design \* Planning
Serving Rochester and
Southern Minnesota 1647 16th Ave. NW Rochester MN 55901 PHONE (507) 286-7869 aaron@thedesignconnection.net www.thedesignconnection.net

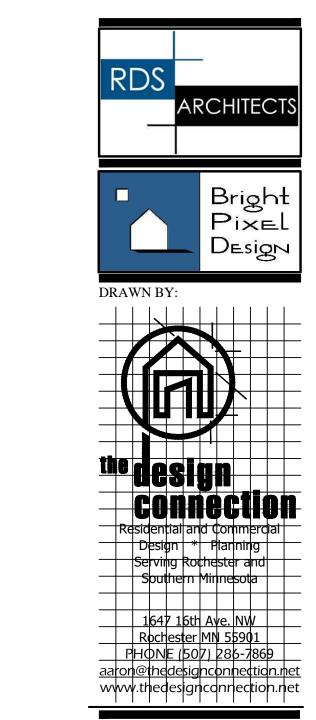
> STREET AKE

PROJECT #: DRAWN BY: CDB / IJN CHECKED BY: MJB CDB FINAL DATE:

Dec 14, 2020 PRINTED;

> NORTH & SOUTH **ELEVATIONS**





TOTAL ELEVATION AREA - 4560 SF

- %

- 1%

PERCENTAGES OF MATERIALS GLASS/ALUMINUM BRICK

114 LAKE STREET I

PROJECT #:	20258
DRAWN BY:	CDB / IJN
CHECKED BY:	MJB / CDB
FINAL DATE:	


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EAST ELEVATIONS


A8 2

TOTAL ELEVATION AREA - 4480 SF

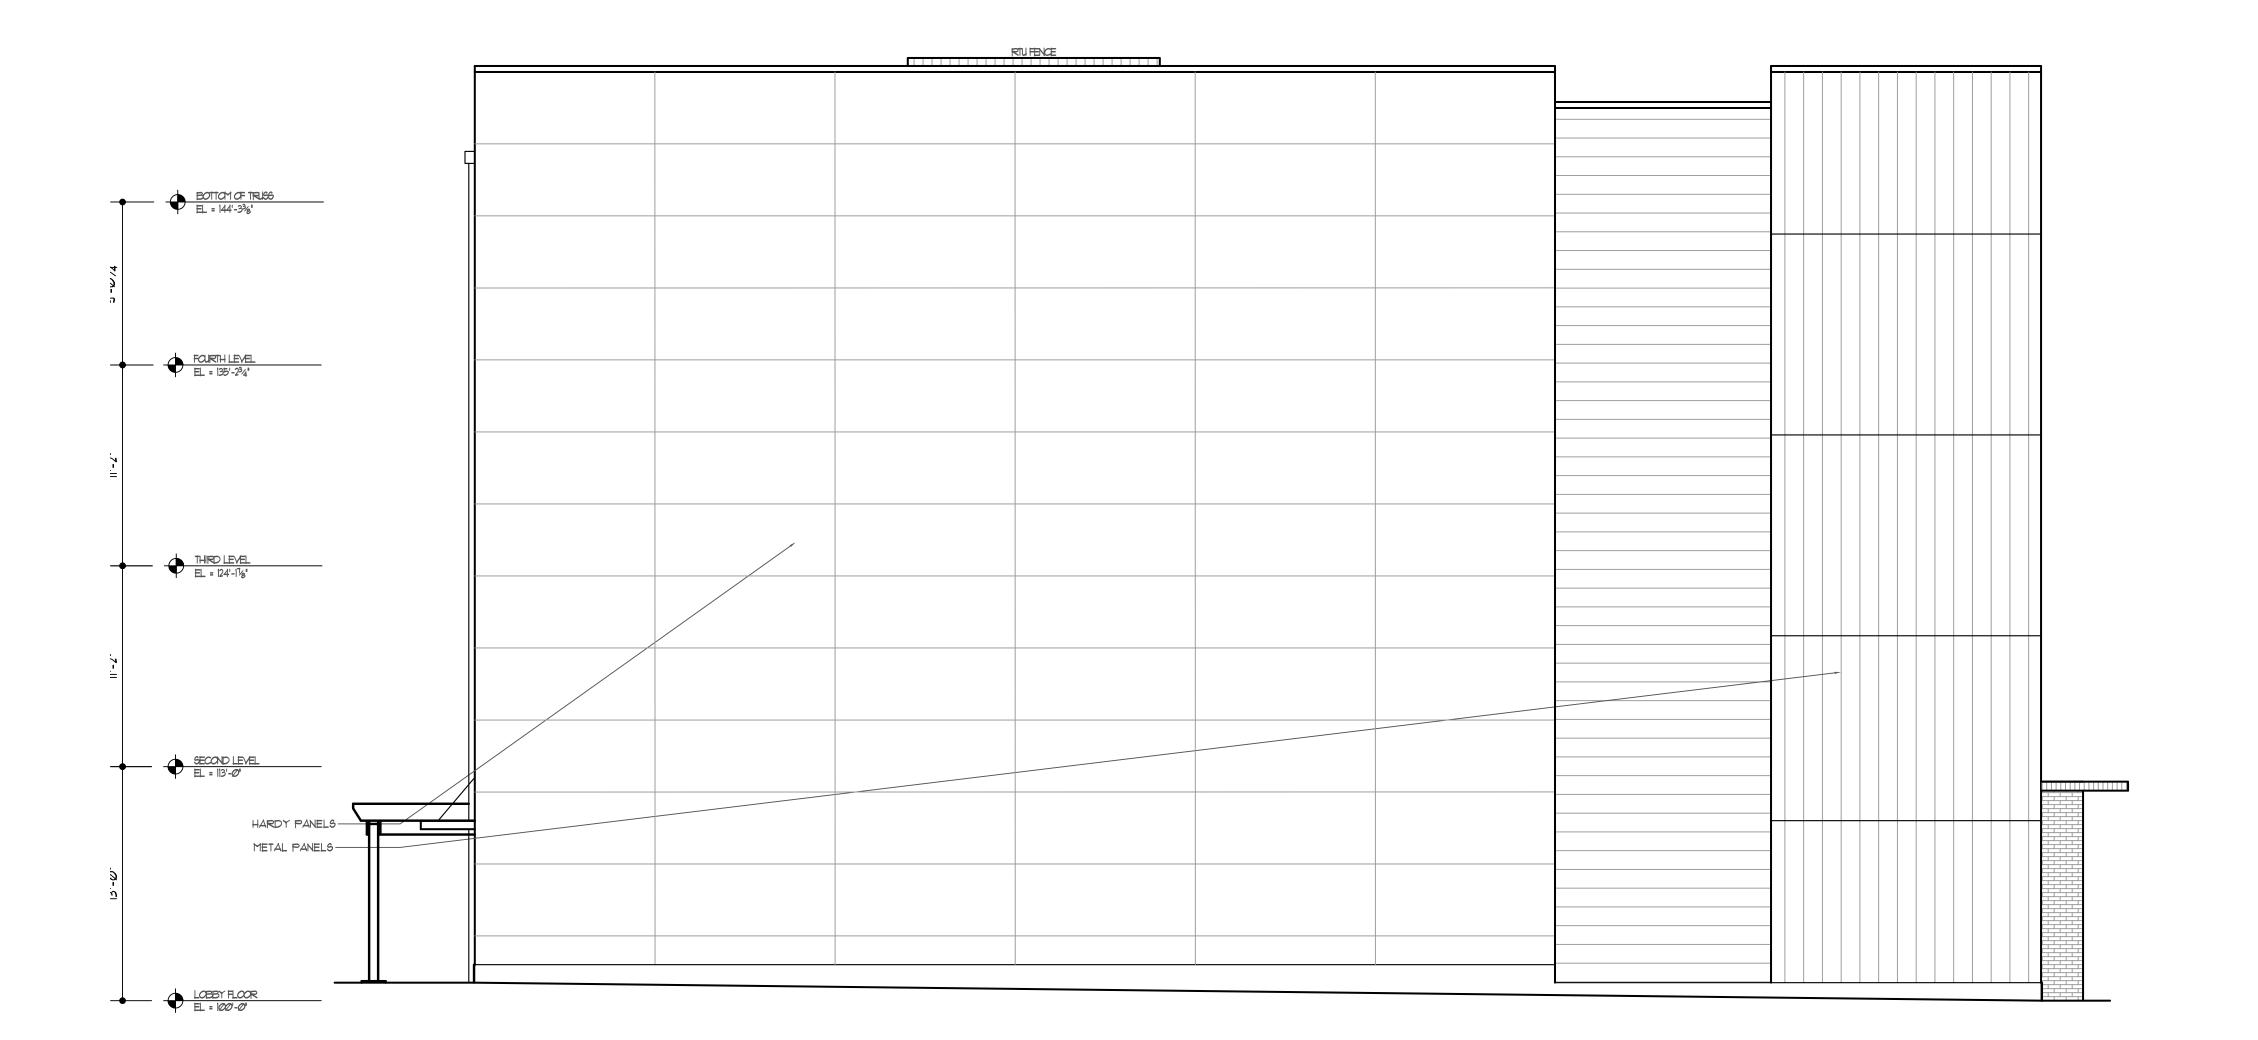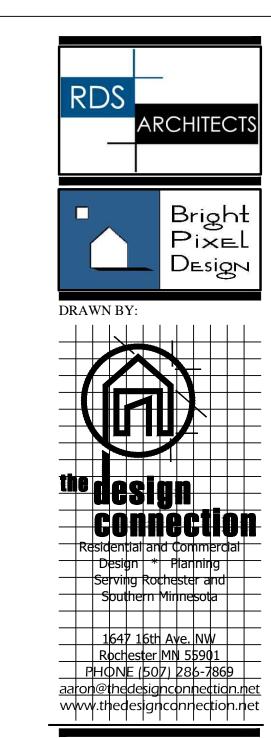PERCENTAGES OF MATERIALS
BRICK - 1%
METAL PANELS - 30%
HARDY BOARD - 67%
CONCRETE BASE - 2%








114 LAKE STREET
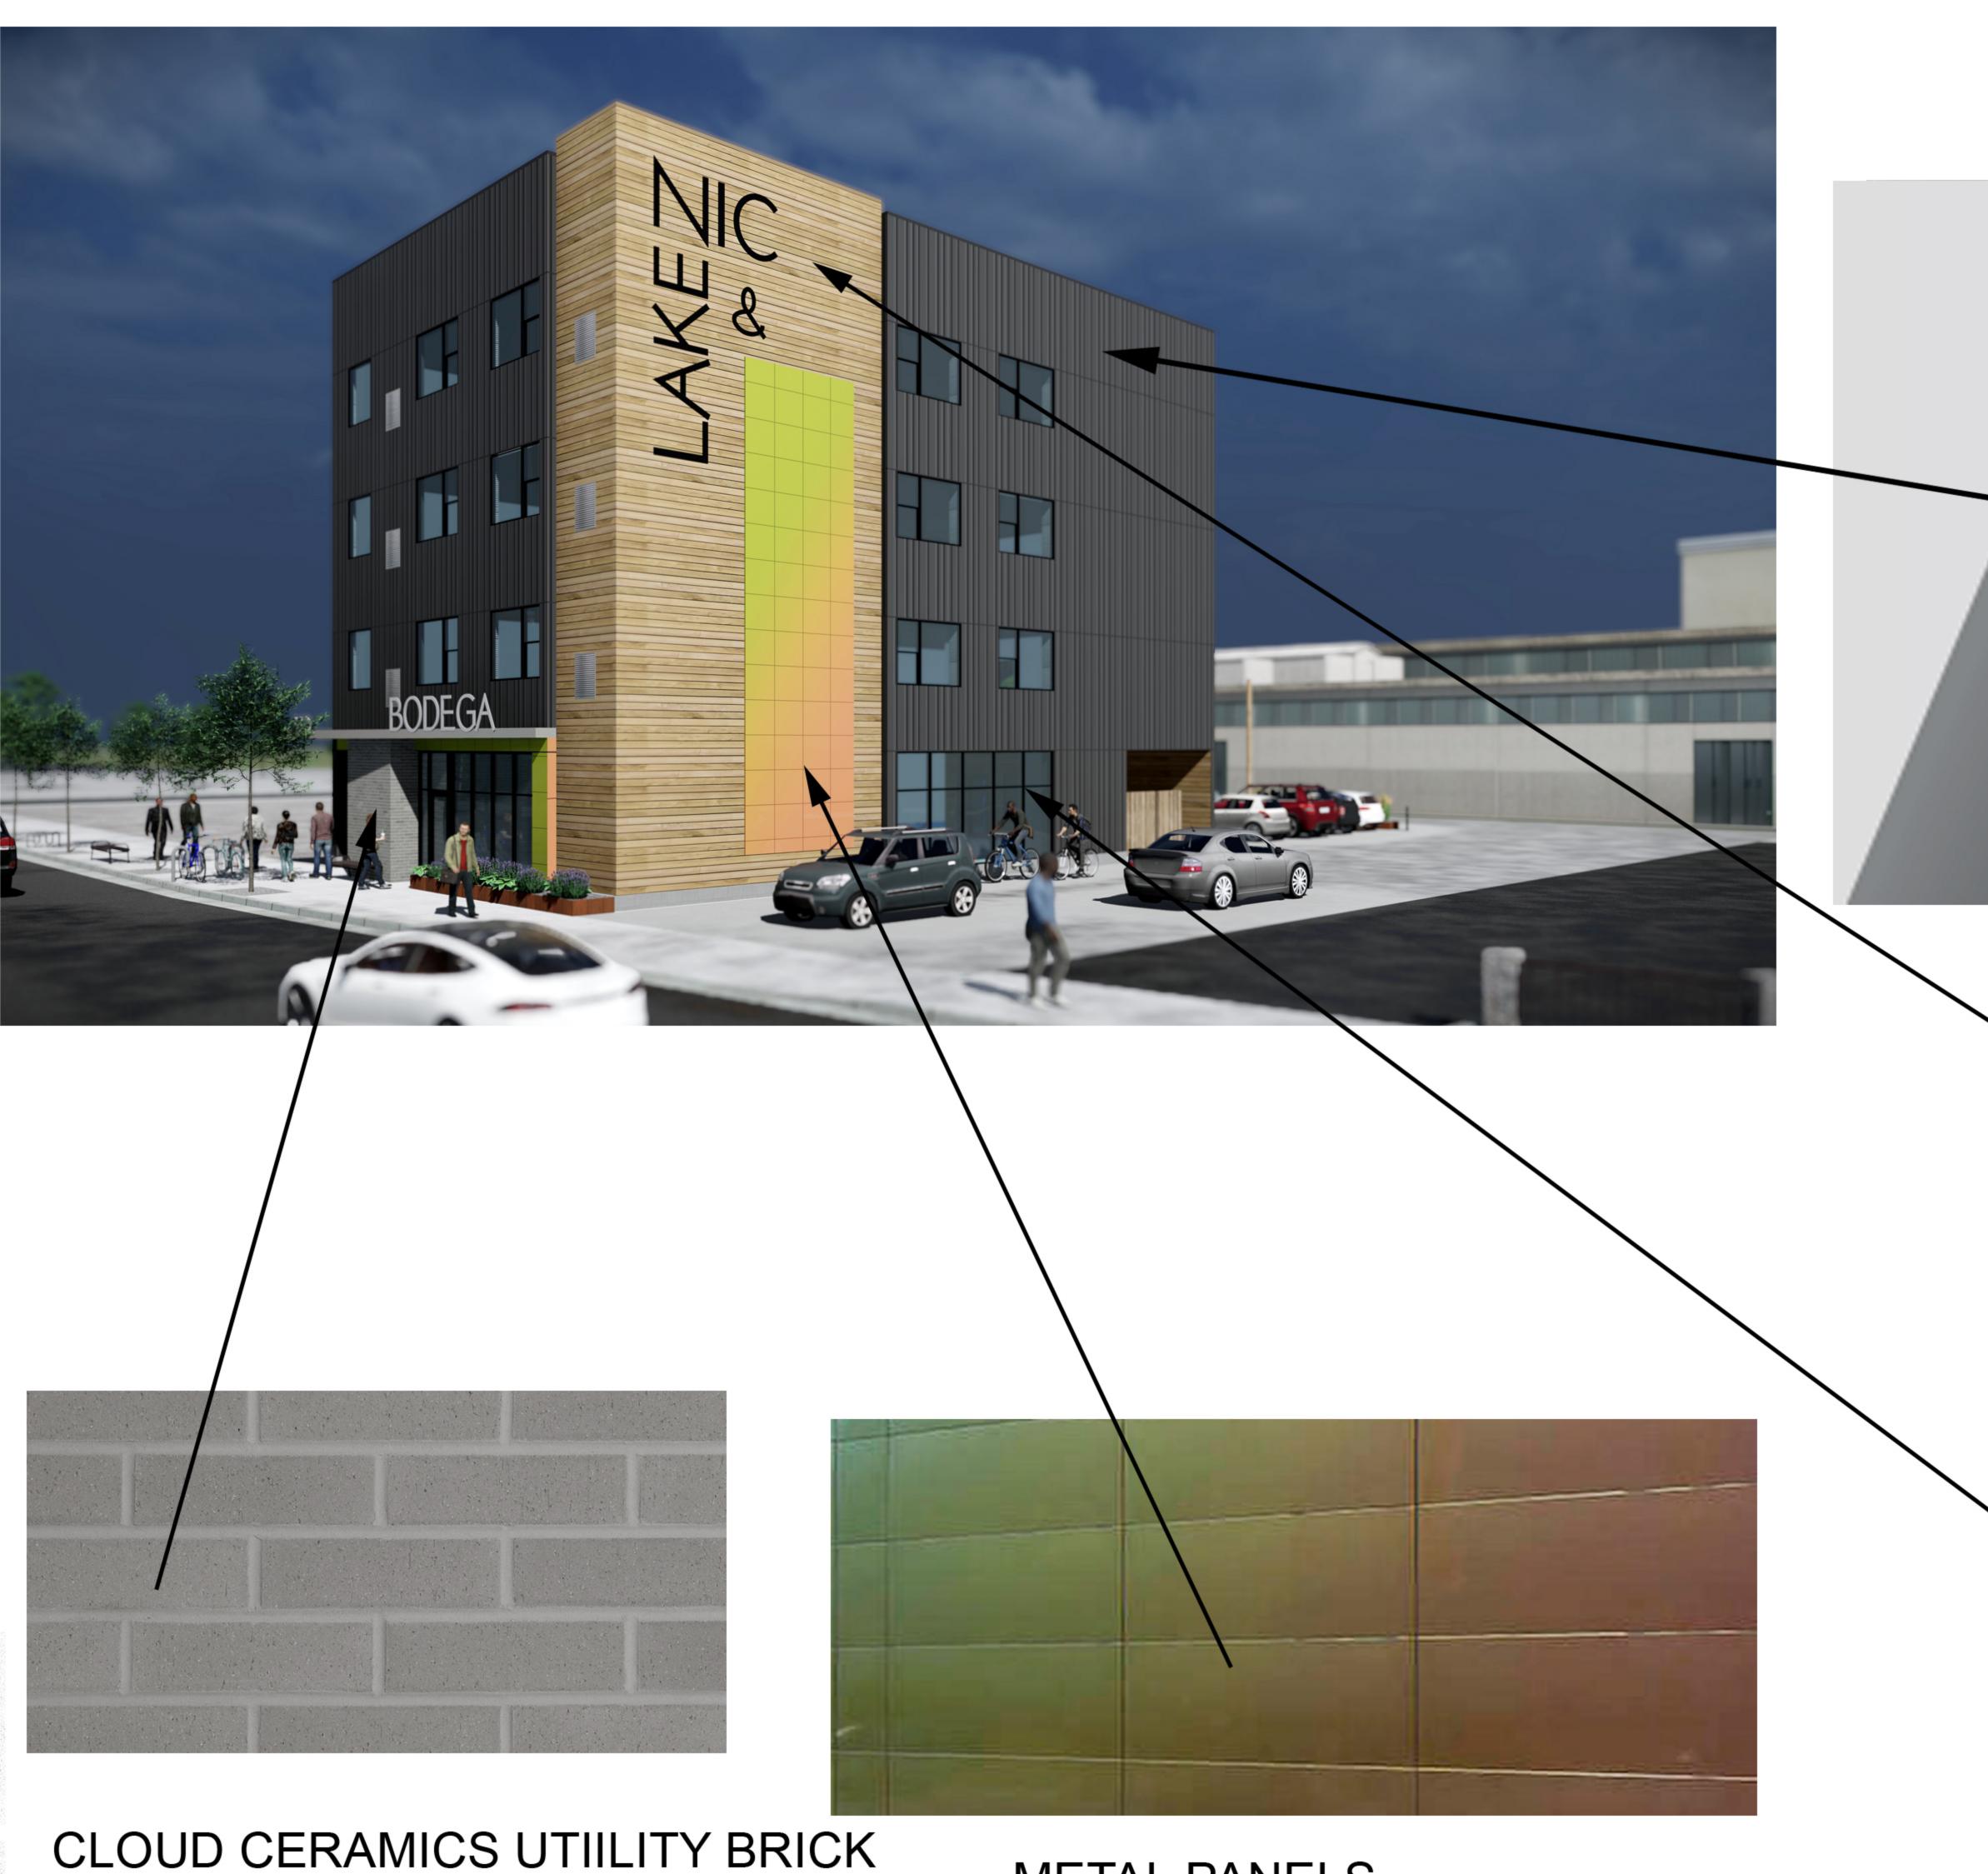
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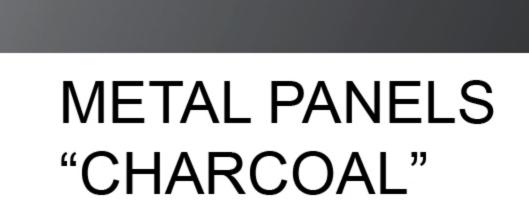
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WEST ELEVATIONS A8.3




"CLOUD GREY"

METAL PANELS
PRISM FX COLOR SHIFT
"SPRING LAKE"






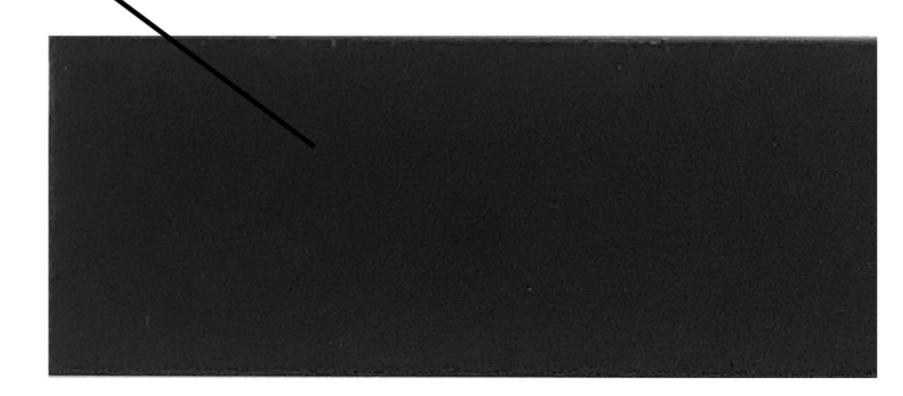WALL PANELS W/ REVEAL "SUGAR MAPLE"



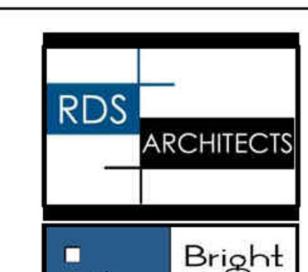STOREFRONT AND WINDOW FRAMES "BLACK POWDERCOATED ALUMINUM"







$\stackrel{\smile}{\leftarrow}$	
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DIBCT#:	2025
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ECKED BY:	MUB/C
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INTROS Oct 09 202

EXTERIOR MATERIALS

EX1.0



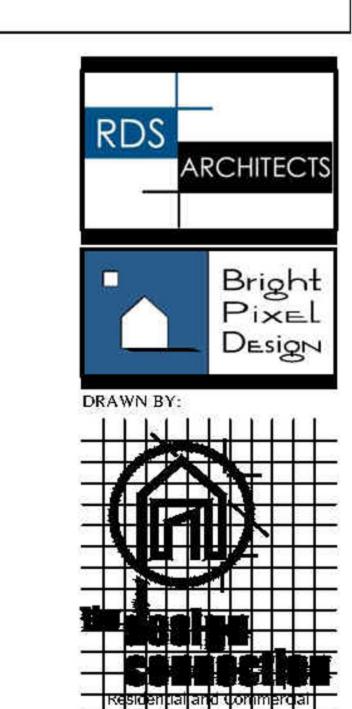
SOUTHEAST VIEW





NORTHEAST VIEW





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PROJECT#:	20258
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FINAL DATE:	

EXTERIOR RENDERINGS

EX2.0

SOUTHWEST VIEW



SOUTHEAST VIEW



NORTHEAST VIEW







EXTERIOR RENDERINGS EX3.0

SOUTHWEST VIEW COURTYARD VIEW

Schedule															
Symbol	Label	Image	QTY	Manufacturer	Catalog Number	Description	Lamp	Number Lamps	Filename	Lumens per Lamp	Lumen Multiplie r	LLF	Wattage	Efficiency	Distribut ion
	AA2		1	Luminis Canada Inc.	BVA21-L1L40-TYP4	Bellevue Area	(30) Nichia NVSL219C c/w Philips Advance Xitanium- XI095C275V054BSS1@ 120V	1	BVA21-L1L40- TYP4.ies	3775	1	0.9	67.4	100%	TYPE IV
	W		6	Lithonia Lighting	WPX1 LED P2 40K Mvolt	WPX1 LED wallpack 3000lm 4000K color temperature 120- 277 Volts		1	WPX1_LED_P2_ 40K_Mvolt.ies	2913	1	0.9	24.42	100%	TYPE III, SHORT, BUG RATING: B1 - U0 - G1

Statistics						
Description	Symbol	Avg	Max	Min	Max/Min	Avg/Min
Parking and Concrete Areas	ж	3.2 fc	7.6 fc	0.4 fc	19.0:1	8.0:1
Total Area @ Grade	+	1.0 fc	7.6 fc	0.0 fc	N/A	N/A

1. Davis and Associates, Inc does not assume responsibility for the

interpretation of this calculation, or compliance to local or state lighting codes and ordinances.

2. All readings/calculations are shown @ grade.

3. Fixture heights are shown on plan.



MATERIALS

Bellevue is made of 6063-T6 extruded aluminum alloy. Cast parts are made of corrosion resistant 356 aluminum alloy with a copper (CU) content of less

LED board is assembled on a thick extruded aluminum profile and protected by a clear tempered glass. The acrylic optics provide a wide range of roadway optics. The driver is mounted either in the pole access door (Single Head Configuration) or in the pole top cap (P2, P290, P3, P4) for ease of maintenance.

ELECTRICAL

DRIVER Standard driver is 120-277V multi-volt compatibility (50-60Hz), O-10V dimming-ready (dims to 10%). Optional 347/480V, operating temperatures of -40°C/-40°F to 55°C/131°F, output over voltage protection, output over current protection, output short circuit protection with auto-recovery.

LED Type II, III, IV or V light distribution lenses. Offered in 2700K, 3000K, 3500K, 4000K. See the CCT options for details. Optional true amber LED for turtle sensitive areas. Wavelengths: 584.5nm to 597nm.

60,000hrs L<sub>m</sub>B<sub>so</sub> (based on LM-80 report for lumen maintenance).

Five-stage preparation process includes preheating of cast aluminum parts for air extraction. Polyester powder coating is applied through an electrostatic process, and oven cured for long term finish.

# CERTIFICATION

Tested to UL1598 and CSA 22.2 #250. cULus listed wet location. Photometric testing performed by an independent laboratory in accordance with IES LM-79-08 standards at 25°C. Lumen depreciation in accordance with EPA value: 1.2 ft<sup>2</sup> IESNA LM80 standards. Rated IP65.

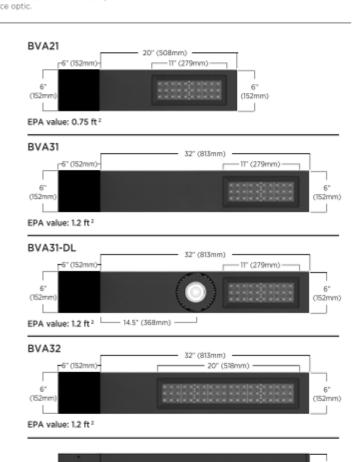
#### MOUNTING Maximum weight: 21 lbs (9.5 kg)

Bellevue is designed for ease of access and installation.

The head is secured on the pole by a set of (4) 5/16-18 bolts. The cast aluminum base plate is secured with a set of (4) 3/4"-10 x 18" lg. galvanized anchor bolts. Accessibility is done through a flush mount 3" x 10" (76 x 254) hand hole cover plate. See page 4 for pole base mounting details.

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Luminaires may be altered for design improvement without prior notice.



Specifications

**WPX LED** Wall Packs

Side View Front View

minaire | Height (H) | Width (W) | Depth (D) | Side Conduit Location | Weight WPX1 8.1"(20.6 cm) 11.1"(28.3 cm) 3.2"(8.1 cm) 4.0"(10.3 cm) 0.6"(1.6 cm) 6.1 lbs (2.8kg) WPX2 9.1"(23.1 cm) 12.3"(31.1 cm) 4.1"(10.5 cm) 4.5"(11.5 cm) 0.7"(1.7 cm) 8.2 lbs (3.7kg) WPX3 9.5"(24.1 cm) 13.0"(33.0 cm) 5.5"(13.7 cm) 4.7"(12.0 cm) 0.7"(1.7 cm) 11.0 lbs (5.0kg)

## Introduction

The WPX LED wall packs are energy-efficient, costeffective, and aesthetically appealing solutions for both HID wall pack replacement and new construction opportunities. Available in three sizes, the WPX family delivers 1,550 to 9,200 lumens with a wide, uniform distribution.

The WPX full cut-off solutions fully cover the footprint of the HID glass wall packs that they replace, providing a neat installation and an upgraded appearance. Reliable IP66 construction and excellent LED lumen maintenance ensure a long service life. Photocell and emergency egress battery options make WPX ideal for every wall mounted lighting application.

Ordering	Information		EXAMPLE: WPX2 LED 40K MVOLT DDBXD				
Series		Color Temperature	Voltage	Options	Finish		
WPX1 LED P1 WPX1 LED P2 WPX2 LED WPX3 LED	1,550 Lumens, 11W <sup>1</sup> 2,900 Lumens, 24W 6,000 Lumens, 47W 9,200 Lumens, 69W	30K 3000K 40K 4000K 50K 5000K	MVOLT 120V - 277V 347 347V <sup>3</sup>	(blank) None  E4WH Emergency battery backup, CEC compliant (4W, 0°C min) 2  E14WC Emergency battery backup, CEC compliant (14W, -20°C min) 2  PE Photocell 3	DDBXD Dark bronze DWHXD White DBLXD Black Note: For other options, consult factory.		

Note: The lumen output and input power shown in the ordering tree are average representations of all configuration options. Specific values are available on request.

 All WPX wall packs come with 6kV surge protection standard, except WPX1 LED P1 package which comes with 2.5kV surge protection standard. Add SPD6KV option to get WPX1 LED P1 with 6kV surge protection.
Sample nomenclature: WPX1 LED P1 40K MVOLT SPD6KV DDBXD 2. Battery pack options only available on WPX1 and WPX2. 3. Battery pack options not available with 347V and PE options.

## FEATURES & SPECIFICATIONS

INTENDED USE The WPX LED wall packs are designed to provide a cost-effective, energy-efficient solution for the one-for-one replacement of existing HID wall packs. The WPX1, WPX2 and WPX3 are ideal for replacing up to 150W, 250W, and 400W HID luminaires respectively. WPX luminaires deliver a

CONSTRUCTION WPX feature a die-cast aluminum main body with optimal thermal management that both enhances LED efficacy and extends component life. The luminaires are IP66 rated, and sealed

against moisture or environmental contaminants.

ELECTRICAL

Light regine(s) configurations consist of high-efficacy LEDs and LED lumen maintenance of
L90/100,000 hours. Color temperature (CCT) options of 3000K, 4000K and 5000K with minimum
CRI of 70. Electronic drivers ensure system power factor >90% and THD <20%. All luminaires have
6kV surge protection (Note: WPX1 LED P1 package comes with a standard surge protection rating of 2.5kV. It can be ordered with an optional 6kV surge protection). All photocell (PE) operate on MVOLT (120V - 277V) input. Note: The standard WPX LED wall pack luminaires come with field-adjustable drive current

INSTALLATION

WPX can be mounted directly over a standard electrical junction box. Three 1/2 inch conduit ports on three sides allow for surface conduit wiring. A port on the back surface allows poke-through conduit wiring on surfaces that don't have an electrical junction box. Wiring can be made in the integral wiring compartment in all cases. WPX is only recommended for installations with LEDs

facing downwards. CSA Certified to meet U.S. and Canadian standards. Suitable for wet locations. IP66 Rated. DesignLights Consortium® (DLC) qualified product. Not all versions of this product may be DLC qualified. Please check the DLC Qualified Products List at <a href="https://www.designlights.org/QPL">www.designlights.org/QPL</a> to confirm which versions are qualified. International Dark Sky Association (IDA) Fixture Seal of Approval (FSA) is available for all products on this page utilizing 3000K color temperature only.

5-year limited warranty. Complete warranty terms located at: Note: Actual performance may differ as a result of end-user environment and application. All values are design or typical values, measured under laboratory conditions at 25°C. feature. This feature allows tuning the output current of the LED drivers to adjust the lumen Specifications subject to change without notice.

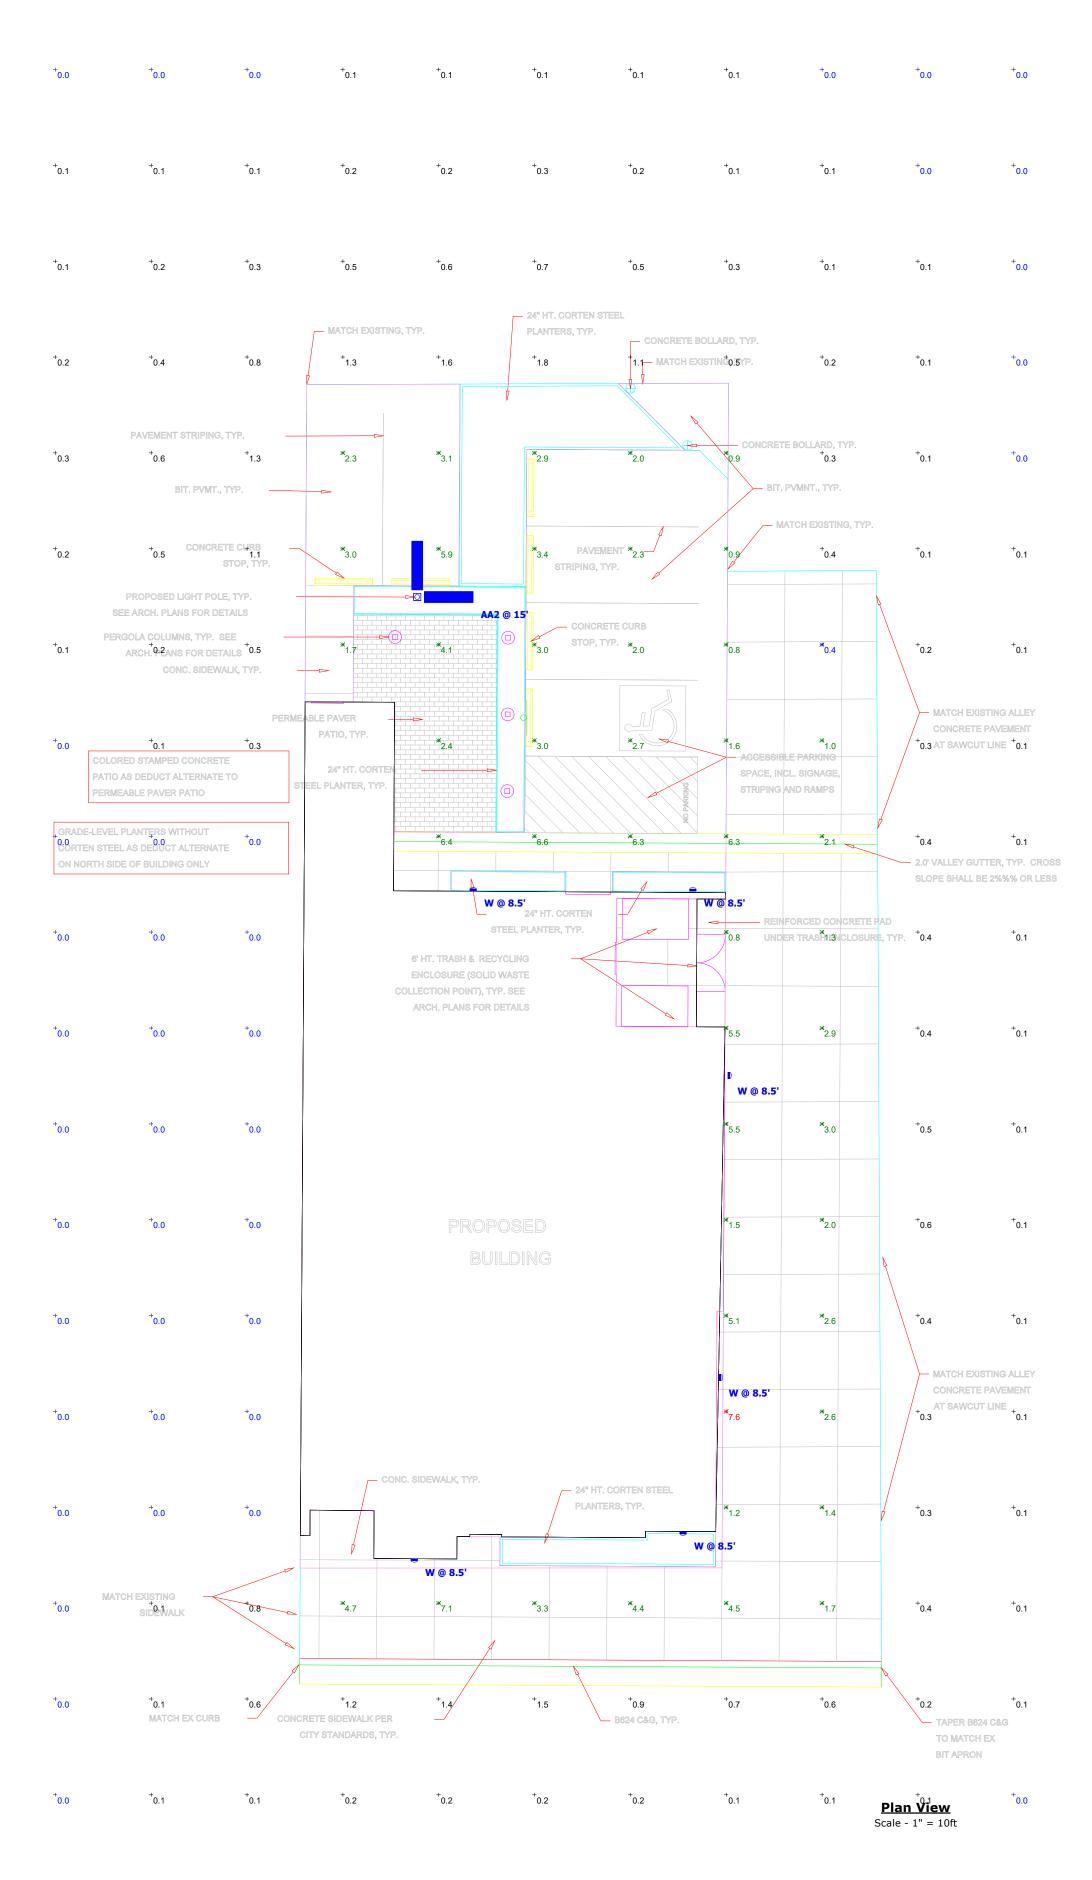


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Designer Date 12/8/2020 Scale As Noted Drawing No. Summary

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