EMERGENCY LIGHT/ SIGN

CENTRAL FIRE ALARM BOX

FIRE ALARM HORN AND PULL STATION

CNTR. CONTRACTOR

DEMO. DEMOLITION

DESIGN BUILD

DISHWASHER

DEEP (DEPTH)

EXPAN JOINT

DINING ROOM,DR

DIAMETER

C.TV. CABLE TV

DTL. DETAIL

DWG. DRAWING

ELEV. ELEVATION

ELEC. ELECTRICAL

E.M. ELEC METER

EMER. EMERGENCY

D.W.

DR.

E.J.

DETAIL REFERENCE

GENERAL CONT

GROUND-FAULT

HEAT DETECTOR

HOLLOW METAL

HORIZONTAL

GALVANIZED

GAUGE

GENERAL

GAS METER

HEAD

HDWD. HARDWOOD

HDWR. HARDWARE

HOUR

HEIGHT

HD.

ETCETERA

EXISTING

FLR. FLOOR

FLASH. FLASHING

FTG. FOOTING

FLUOR. FLUORESCENT

FIREPLACE

FOOT, FEET

GYP.BD. GYPSUM BOARD

PROJECT IMAGES & PROJECT TITLE:

A NEW 6 UNIT APARTMENT BUILDING ON A VACANT LOT

2413 1st Ave South

MINNEAPOLIS, MN 55409 PDR / ZONING SUBMISSION

PRIMARY CONTACTS:	INDEX TO DRAWINGS:	PROJECT DESCRIPTION	
OWNER / DEVELOPER: Eric Ollestad	ARCHITECTURAL / CIVIL SHEETS / STRUCTURAL SHEETS T1 TITLE SHEET	LEGAL DESCRIPTION:	
Value Homes, LLC 3495 Northdale Blvd NW #200 Coon Rapids, MN 55448	T1.1 URBAN CONTEXT T2 CODE SHEET T3 WALL TYPES AND FLOOR TYPES	PROPERTY ID WARD:	34-029-241-30-009 WARD 10 - Whittier Neighborhood Association
612-481-7841 GENERAL CONTRACTOR:	T4 WINDOW AND DOOR SCHEDULE T5 DETAILS T6 DETAILS	ZONING STAFF ASSIGNED: HPC STAFF ASSIGNED:	Council Member Lisa Bender Andrew Frenz Robert Skalecki
	- SURVEY C100 CIVIL SHEETS - DETAIL C101 CIVIL SHEETS - DETAIL	IBC OCCUPANCY TYPE: IBC CONSTRUCTION TYPE: BUILDING CODE	R2 TYPE VB MN STATE BUILDING CODE 2015
ARCHITECT Wells & Company Architects William Wells, Architect	C102 CIVIL SHEETS - EROSION CONTROL L100 SITE PLANS	FIRE SPRINKLER:	INCORPORATING THE 2012 IBC FULLY SPRINKLED NFPA 13R
PO BOX 8589 Minneapolis, MN 55408 wellsandcompany@yahoo.com ph. 612-669-2052	L200 SITE DETAILS L300 SITE DETAILS	LOT ZONED: LOT SIZE: EXISTING SITE USE:	R4 with Washburn Fair Oaks Historic District 5,900 sqft Vacant Lot
STRUCTURAL ENGINEER	A0 FOUNDATION AND BASEMENT PLANS A1 FIRST FLOOR PLAN A2 SECOND FLOOR PLAN	PROPOSED DEVELOPMENT:	6 Unit Apartment Building
Mark Hostetler, PE 5709 Lake Rose Dr Minnetonka, MN 55345	A3 THIRD FLOOR (ATTIC) PLAN A4 ROOF PLAN AND ROOF DETAILS A5 EXTERIOR BUILDING ELEVATIONS	PROPOSED IMPERVIOUS SURFACE: PROPOSED BUILDING FOOTPRINT: PROPOSED BUILDING AREA:	SEE ANALYSIS ON SITE PLAN SHEET L100
SURVEYOR: Gregory Prasch DEMARC	A6 EXTERIOR BUILDING ELEVATIONS A7 BUILDING SECTIONS	PROPOSED BUILDING HEIGHT:	2.5 STORIES WITH BASEMENT
Land Surveying 7601 73rd Ave S Minneapolis, MN 55428	SO - S3 STRUCTURAL SHEETS E1-E2 ELECTRICAL PLANS	PROPOSED PARKING:	5 SURFACE PARKING SPACES OFF STREET
763-560-3093 gregprasch@demarcinc.com		PROPOSED UNIT MIX: ADA REQUIREMENTS:	(6) Units and all units are 2 Bedroom + Office NO ADA units. The building has less than 7 units and all units are multi-level, therefore ADA exempt.

ZONING CODE REQUIREMENTS AND APPROVALS

CONCRETE

MASONRY UNIT

CASED OPENING

CERAMIC TILE

CARBON MON

CONSTRUCTION

CENTERLINE

CLOSET

COLUMN

CONC. CONCRETE

COR. CORRIDOR

CORD. COORDINATE

CSWK. CASEWORK

CONT. CONTINUOUS

C.M.U.

C.T.

C.O.

COL.

 \square Gar

☐ E.HEAT

A.B.

A.C.

ALT.

B.O.

BD.

ADD'L.

AND

ADD'N. ADDITION
A.H.U. AIR HANDELING
ADJ. ADJUSTABLE

ASSY. ASSEMBLY

BLDG. BUILDING

BLKG. BLOCKING

ANCHOR BOLT

ABOVE FINISH FLR

AIR CONDIT

ADDITIONAL

ALTERNATE

BY OWNER

BEDROOM

BREAKFAST RM

BOARD

GARAGE DOOR OPENER

ELECTRICAL HEATER

FLOOD LIGHT

GENERAL PROJECT NOTES

- 1. SEE STRUCTURAL SHEETS FOR FOUNDATION WALL AND FOOTING THICKNESS AND SPECIFICATIONS.
- 2. THE ARCHITECTURAL FLOOR PLANS SHOW THE FINISHED WALL THICKNESS.
- 3. GC MUST FIELD VERIFY DIMENSIONS.
- ALL BEDROOMS MUST HAVE A SMOKE DETECTOR HARD WIRED.

 ALL BEDROOMS MUST HAVE A CO DETECTOR WITHIN 10' OF THE BEDROOM DOOR

 AS REQUIRED BY CODE.
- 5. ALL BATHROOMS MUST HAVE EXHAUST FAN, VENT TO EXTERIOR. AND INSULATE THE PIPE TO R-8 AS REQUIRED WITHIN 3' OF EXTERIOR.
- 6. ALWAYS PROVIDE A FLOOR DRAIN OR A PAN UNDER THE WASHER / DRYER.
- SEE PLANS FOR LOCATION.
- 7. SEE "T" SHEETS FOR WALL TYPES
 - DO NOT SCALE OFF THE PLANS. THE CONTRACTOR MUST CONTACT ARCHITECT WITH DIMENSION QUESTIONS.
- THE ORIGINAL PRINTED PLAN SIZE IS 24" X 36".
- 10. THE CONTRACTOR AND SUBCONTRACTORS MUST VISIT THE SITE AND BECOME
- FAMILIAR WITH ALL EXISTING CONDITIONS PRIOR TO SUBMISSION OF BIDS.
- THE CONTRACTOR AND SUB CONTRACTORS SHALL PULL ALL NECESSARY PERMITS, AND CARRY INSURANCE, LICENSES AND CERTIFICATES.
- 12. CONTRACTOR SHALL FURNISH AND INSTALL ALL ITEMS WHICH ARE OBVIOUS AND NECESSARY TO INSURE GOOD WORKMANSHIP AND INSTALLATION EVEN IF NOT SPECIFICALLY MENTIONED ON THE DRAWINGS,
- INCLUDING BUT NOT LIMITED TO BLOCKING AND BRACING FOR ALL BATHROOM HARDWARE.

 13. ALL DOORS AND HARDWARE SHALL BE IN COMPLIANCE WITH APPLICABLE CODES AND ORDINANCES. ALL WORK TO BE DONE IN COMPLIANCE WITH THE LATEST LOCAL AND STATE BUILDING CODES AND ORDINANCES.
- 14. PROVIDE METAL CORNER BEADS AT ALL OUTSIDE CORNERS OF GYPSUM BOARD SURFACES.

- 15. UPON COMPLETION OF THE PROJECT, THE CONTRACTOR SHALL
- WASH CLEAN ALL SURFACES AND LEAVE THE WORK IN A CLEAN CONDITION.

 16. THE CONTRACTOR MUST OBTAIN THE OWNER'S WRITTEN PERMISSION BEFORE MAKING CHANGES TO THE BUILDING DESIGN, WHICH IMPACT THE FUNCTION,
- COST, OR OVERALL AESTHETIC OF THE PROJECT.

 18. SEE OWNER'S FINISH SCHEDULE FOR ALL INTERIOR ROOM FINISHES.
- 19. FIRESTOP ALL OPEN SPACES AROUND PENETRATIONS IN FIRE RATED ASSEMBLIES WITH INTUMESCING FIRESTOP, UL APPROVED, BY 3M OR EQUAL.
- 20. THE CONTRACTOR MUST PROVIDE THE ARCHITECT WITH SHOP DRAWINGS FOR ALL STAIRS, GATES, FENCES, RAILINGS, HANDRAILS, AND DECKS, WALKWAYS, FLOOR TRUSSES, SPRINKLER SYSTEM, ETC.
- 22. AT ALL WET LOCATIONS PROVIDE AQUA-TOUGH TILE BACKER BOARD OR MOLD RESISTANT GYP BD.
- 23. ALL CAULKING AT KITCHEN AND BATHROOM LOCATIONS TO BE SILICONE BASED.

 MATCH COLOR WITH ADJ FINISH.
- 24. THE CONTRACTOR SHALL AT ALL TIMES KEEP THE PREMISES SECURE AND FREE FROM WASTE. PROVIDE PROPER FENCES AND SIGNAGE AROUND SIDEWALKS. DO NOT STORE CONSTRUCTION MATERIALS IN THE PUBLIC RIGHT OF WAY OR ON THE NEIGHBOR'S PROPERTY.
- 25. SUBSTITUTIONS SHALL BE CONSIDERED AT BID STAGE. DURING CONSTRUCTION CONTRACTOR MUST GET WRITTEN APPROVAL FROM THE OWNER BEFORE MAKING ANY SUBSTITUTIONS.
- CONTRACTOR MUST GET WRITTEN APPROVAL FROM THE OWNER BEFORE MAKING 26. CONTRACTOR MUST SHOW SAMPLES TO OWNER BEFORE INSTALL.
- 27. SPECIAL INSPECTIONS AND SPECIAL TESTING ARE REQUIRED ON THE PROJECT.
 THE CONTRACTOR MUST COORDINATE ALL SPECIAL INSPECTIONS. THE OWNER MUST PAY
- FOR ALL THE SPECIAL INSPECTIONS.

 28. THE FOLLOWING TRADES ARE DESIGN-BUILD: FIRE SPRINKLER, ELECTRICAL, PLUMBING, MECHANICAL, FLOOR AND ROOF TRUSS FRAMING, THE SUB CONTRACTORS MUST PROVIDE CODE COMPLIANT SHOP DRAWINGS, STAMPED AND SIGNED BY AN ENGINEER AS REQUIRED BY CODE TO PULL A PERMIT AT THE CITY. THE SUB CONTRACTORS PROVIDING DESIGN BUILD SERVICES ARE REQUIRED TO BID AND INSTALL THE WORK PER CODE.

WELLS & COMP, A R C H I T E C

ANY

& Company Architects

PROJECT TITLE:

A New 6 Unit
Apartment Building
2413 1st Ave S
Minneapolis, MN

SHEET TITLE:

COVER SHEET

PROJECT #: 02-2020

DRAWN BY: WELLS

ISSUE: DATE

I hereby certify that this plan specification or report was prepared by me or under my direct supervision and that I am a duly registered architect under the law of

the state of: Minnesota

signed: William M. Wells, Architect
date: 5.22.2020 reg. no. 49615

SHEET NO:

NOTIFY ARCHITECT IN EVENTS OF DISCREPANCIES, OMISSIONS, AND/ OR CONFLICTS IN THE DRAWINGS OR SPECIFICATIONS. ALL QUESTIONS IN REFERENCE TO THE CONTRACT DOCUMENTS SHALL BE IMMEDIATELY DIRECTED TO THE ARCHITECT. THE CONTRACTOR SHALL NOT SCALE THE DRAWINGS

PLANS MUST BE PRINTED ON 24" X 36" SIZE PAPER TO BE AT SCALE

I hereby certify that this plan specification or report was prepared by me or under my direct supervision and that I am a duly registered architect under the law of

signed: William M. Wells, Architect

date: 5.22.2020 reg. no. 49615

SHEET NO:



PHOTO OF EXISTING CONDITIONS (VACANT LOT)

EXISTING CONDITIONS



NEW 6 UNIT APARTMENT BUILDING 2413 1st Ave SE


VACANT LOT 2413 1st Ave SE

ARCHITECTURAL RENDERING (NEW 6 UNIT APARTMENT BUILDING

PROPOSED IMPROVEMENTS

PLANS MUST BE PRINTED ON 24" X 36" SIZE PAPER TO BE AT SCALE

VIEW FROM 1st AVE S

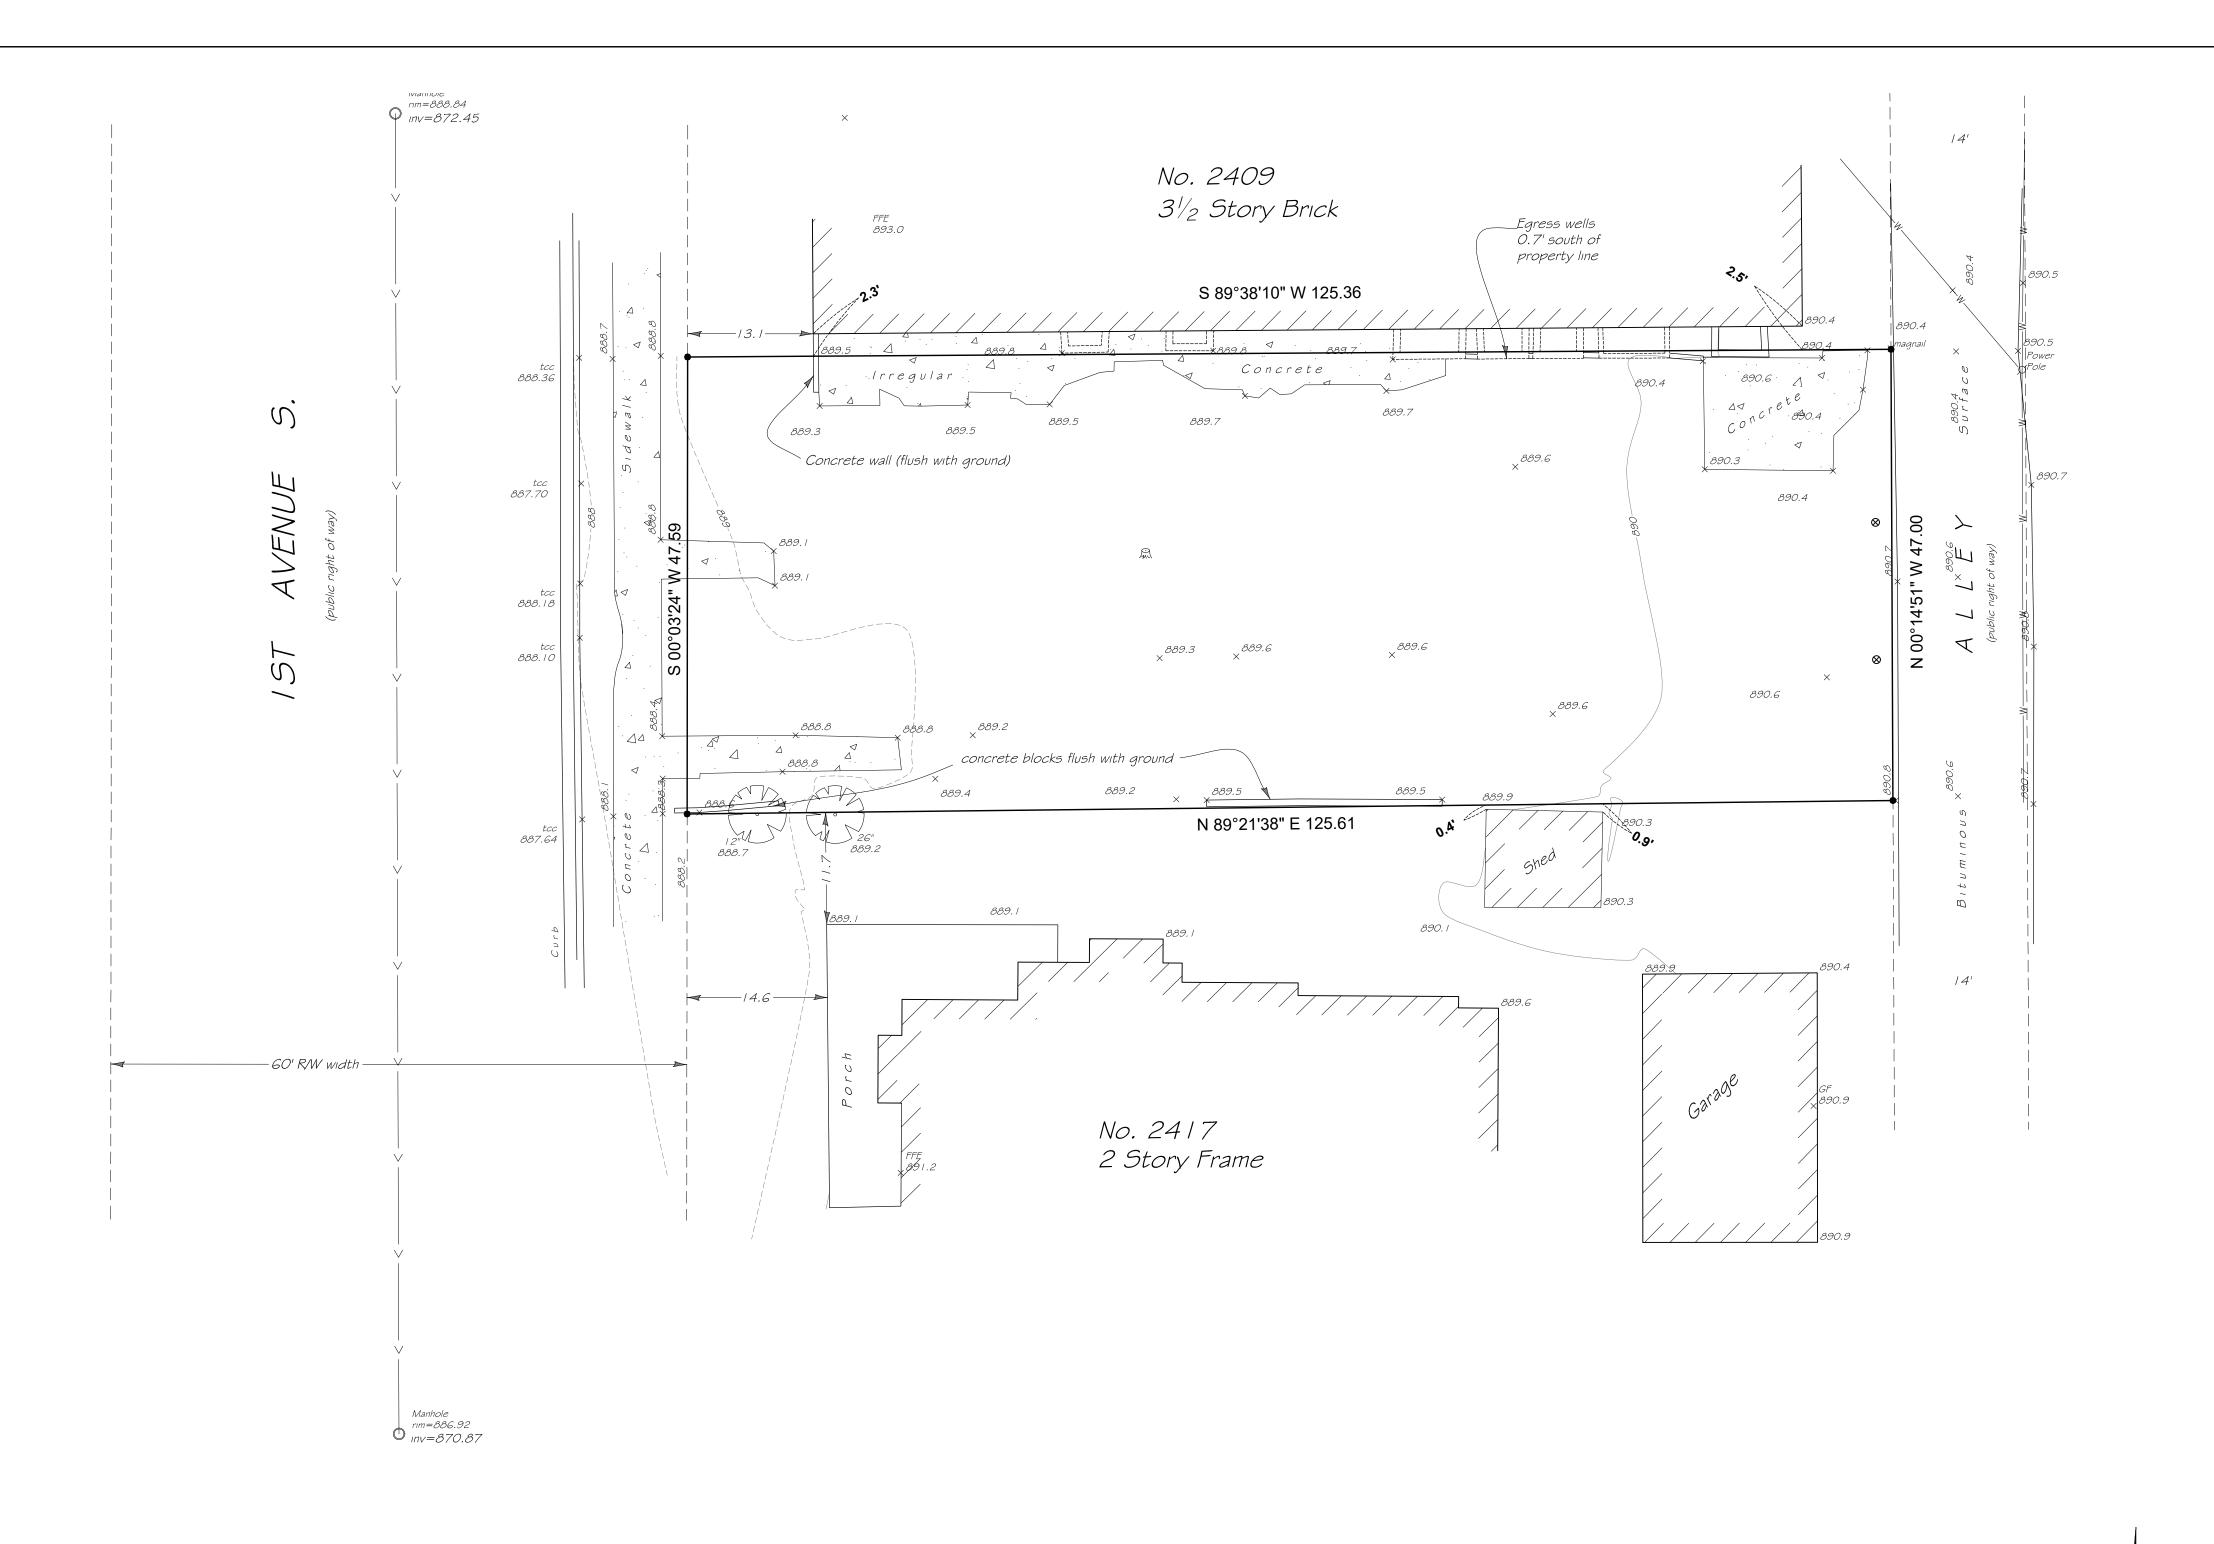

Legend of Symbols and Abbreviations

Denotes Existing Contours

Denotes Proposed Contours

Denotes Proposed Contours

Denotes Existing Elevation

Denotes Proposed Elevation

Denotes Surface Drainage

Denotes Found Iron Monument

Denotes Iron Monument Set

Bollard

Light

Power Pole

Manhole

Catch Basin

Gas Main

Underground Communications

UE Underground Electric

Sanitary Sewer

Storm Sewer

Overhead Wires

123 Height of building to adjacent ground

Statement of Encroachments

Egress wells over north lot line.


B Wall crosses over north lot line.

C Irregular concrete crosses over north lot line.

Source of Information: City of Minneapolis Zoning web site (minneapolismn.gov) City Address: 315 4th Street, Minneapolis, MN City Phone: (612)673-3000 Zoning District(s): R4 (library.municode.com Minneapolis, MN 546.560 - yard requirements) Zoning Definition: Multiple-Family (Medium Density) Building Setback Requirements R4 Observed Required Front Yard Setback Note: Refer to City Code 546.160 for Side Yard Setback N/A 6 feet exceptions to front yard setbacks. Rear Yard Setback N/A 5 feet Parking Tabulation See Note dependent on building type Handicapped Spaces Total Parking Spaces N/A Observed Max. Allowed see survey | see note | dependent on building type Maximum Height Observed Required 5934 sq.ft 1500 sq.ft dependent on building type

Current Zoning Information

NOTE: Because there may be a need for further interpretation of the applicable zoning codes, we refer you to the above referenced municipality and the applicable zoning codes.

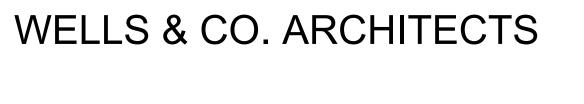

ALTA/NSPS LAND TITLE SURVEY FOR:

Legal Description

Lot 11, Block 1, BELLEVIEW ADDITION TO MINNEAPOLIS, Hennepin County, Minnesota.

Note Corresponding to Schedule B, Part II

As per Commitment No. 612654, dated April 24, 2020.

- 1 Item 1 Is not a survey issue or not to our knowledge.
- 2 Item 2 Not to our knowledge.
- 3 Item 3 Encroachments as shown hereon, see 'Statement of Encroachments'
- (4) Item 4 Not to our knowledge.
- (5) Item 5 Liens are not a survey issue.
- (6) Item 6 Taxes and assessments are not a survey issue.
- (7) Item 7 Taxes and assessments are not a survey issue.
- 8 Item 8 Items listed are not a survey issue.
- 9 Item 9 Taxes are not a survey issue.
- (10) Item 10 Assessments are not a survey issue.
- (11) Item 11 Property subject to Mineral rights to State of Minnesota.
- (12) Item 12 Leases are not a survey issue.
- (13) Item 13 Questions regarding title commitment to Nate Schultz at 651-697-6161.

Miscellaneous Notes

- Legal description and easements, if any, per title commitment from Old Republic National Title Insurance Company, File No. 612654, dated April 24, 2020.
- Property Address: 2413 1st Avenue South, Minneapolis, Minnesota Property Identification No.: 34-029-24-13-0009
- MN 3 Area of Parcel = 5,934 sq ft
- Property is in Flood Zone "X" (area of minimal flooding) per FEMA panel map number 27053C0359F, effective date 11-04-2016.
- Per item 6 of certification: No zoning report or letter provided. Zoning information shown obtained thru City web site.
- MN 6 There is no observable evidence of cemeteries or burial grounds on subject property.
- MN 7 There are no ponds, lakes, springs or rivers boarding on or running through subject property.
- MN 8 Access is gained to the subject property via public alley.
- There is no observable evidence of earth moving work, building construction or building additions within recent months.
- There are no changes in street right of way lines either completed or proposed as available from the controlling iurisdiction
- There is observable evidence of recent street or sidewalk construction or repairs.
- There is no observable evidence of site use as a solid waste dump, sump or sanitary landfill.
- Benchmark: Minneapolis Monument No. 461 located at East 22nd Street and Nicollett Avenue South
- Elevation 694.44 leet

Above ground utility locations have been field located as shown. All underground utility services which serve the property have attempted to be located through the services of Gopher State One Call per ticket number 201483497. Utilities as shown are from available maps and locations are only approximate. Before any digging contact Gopher State One Call (651-454-0002 or 811)

ALTA/NSPS Land Title Survey Certification

To Value Homes LLC, a Minnesota limited liability company; American Land & Capital, LLC its successors and/or assigns, as their interests may appear and Old Republic National Title Insurance Company.

This is to certify that this map or plat and the survey on which it is based were made in accordance with the 2016 Minimum Standard Detail Requirements for ALTA/NSPS Land Title Surveys, jointly established and adopted by ALTA, and NSPS, and includes Items 1, 2, 3, 4, 5, 6(b), 7(a)(c), 8, 9 and 11 of Table A thereof.

Field work completed on 5th day of May 2020.

basis of bearings is assumed

Prepared by:

DEMARC

LAND SURVEYING & ENGINEERING
7601 73rd Avenue North
Minneapolis, Minnesota 55428


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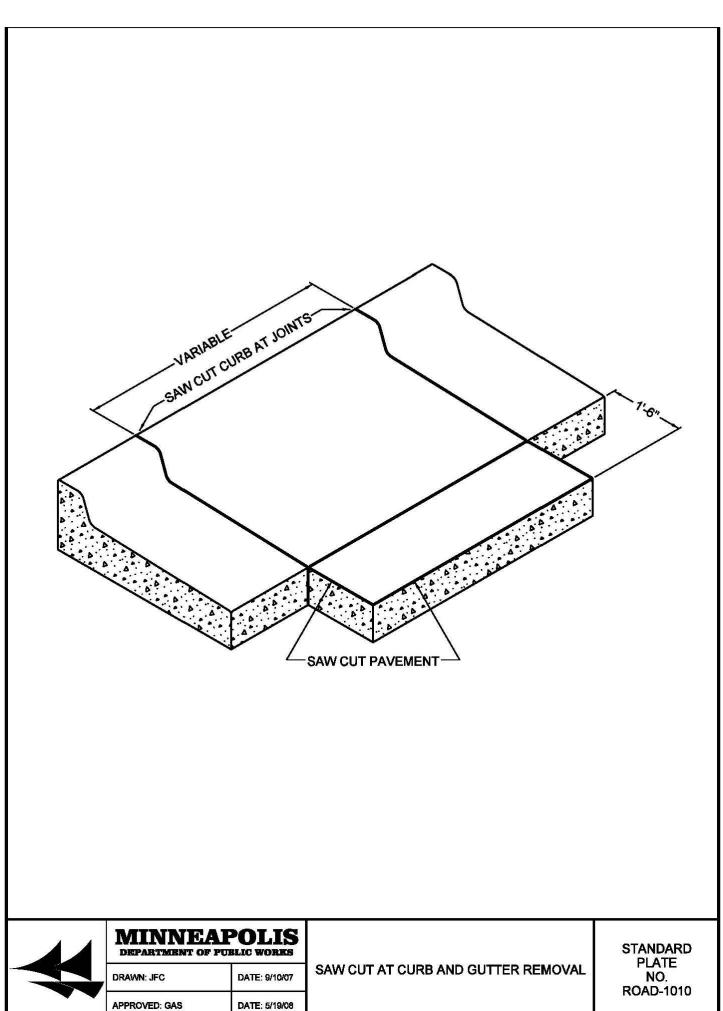
(763) 560-3093
DemarcInc.com


ed: Cregory R. Prasch Registration No. 24992


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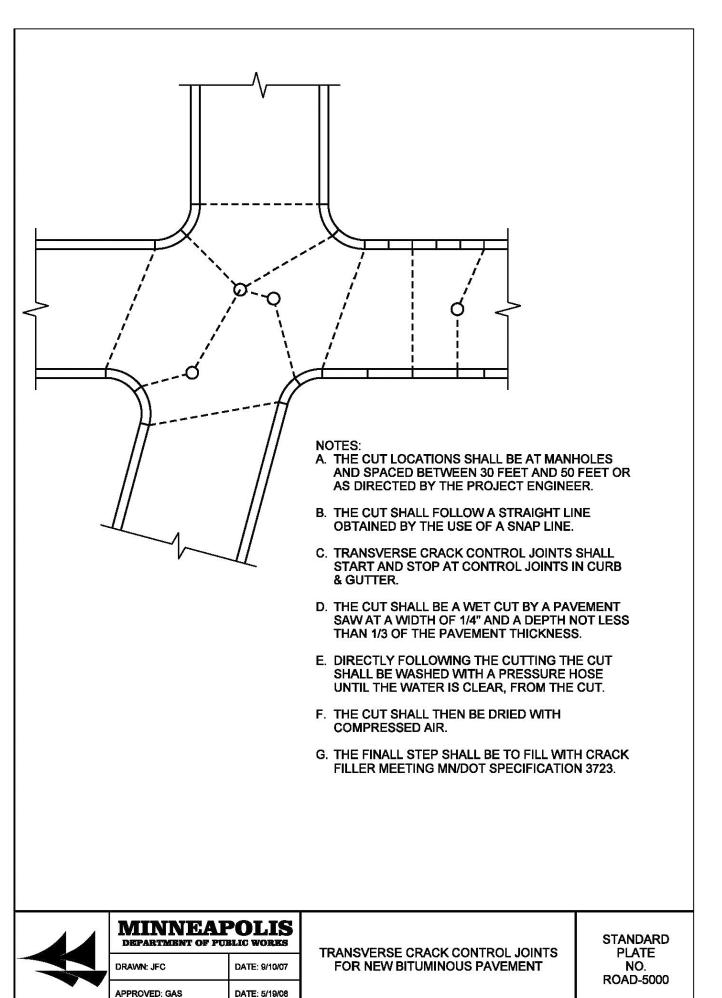
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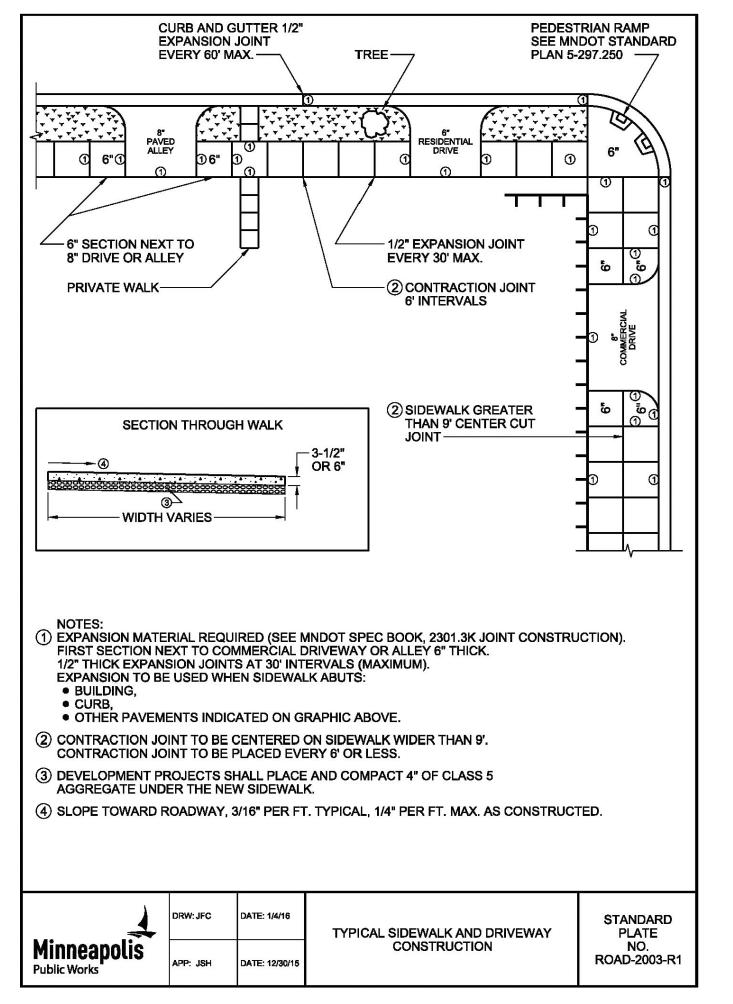
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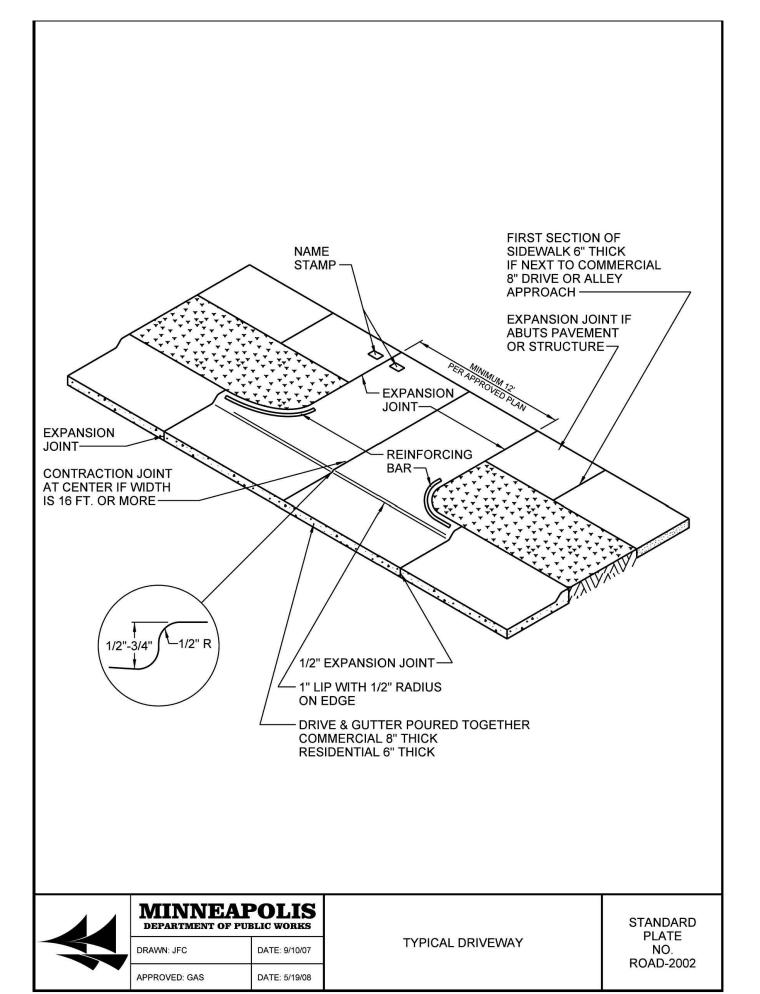
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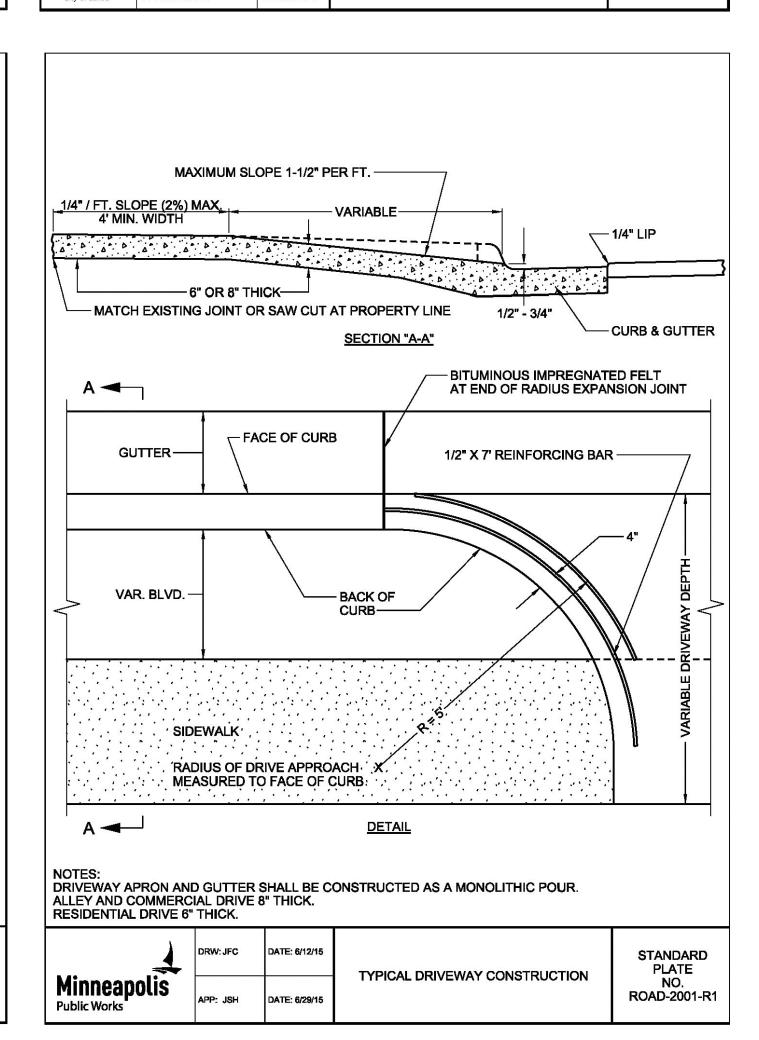
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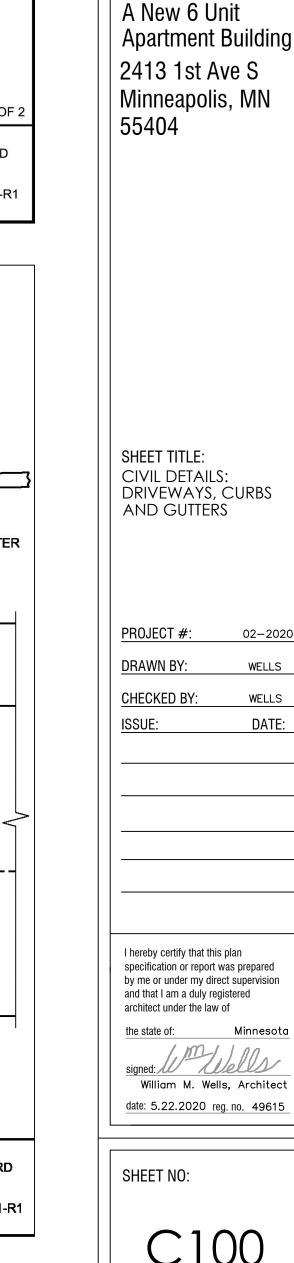
PLATE

ROAD-1003



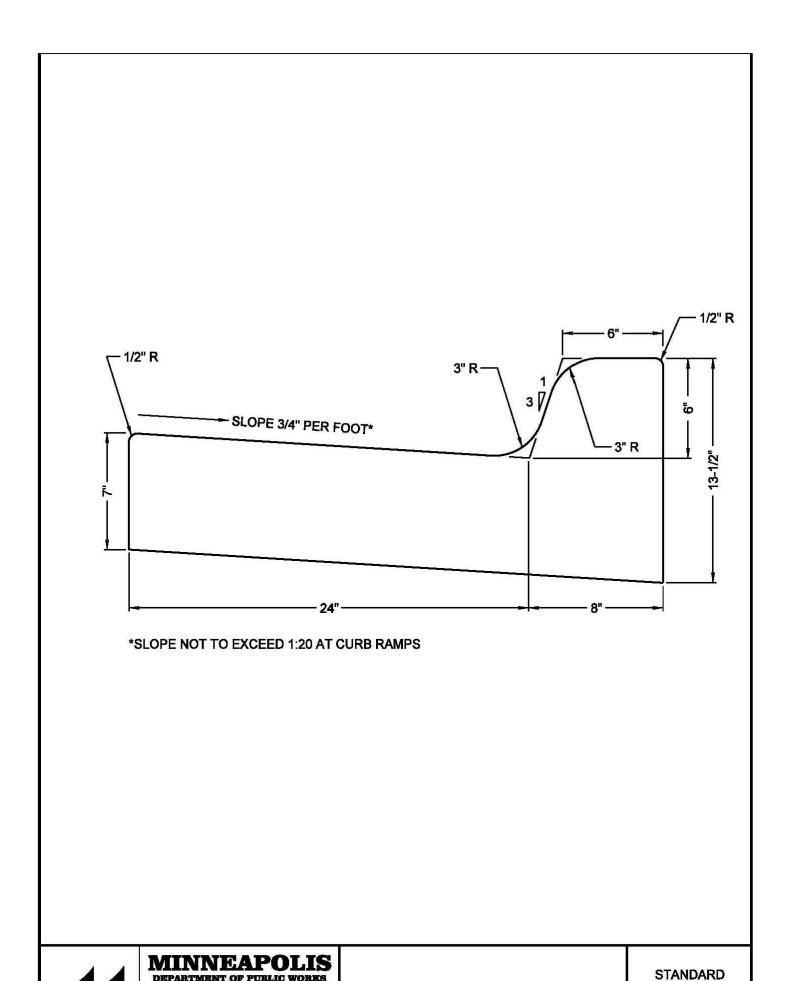


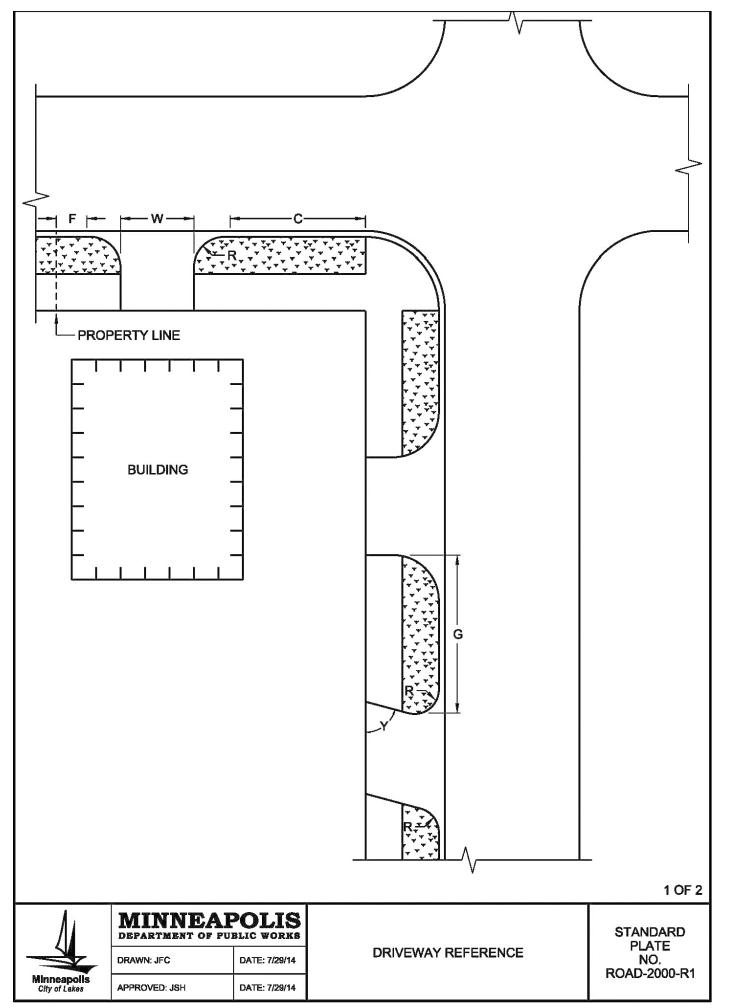


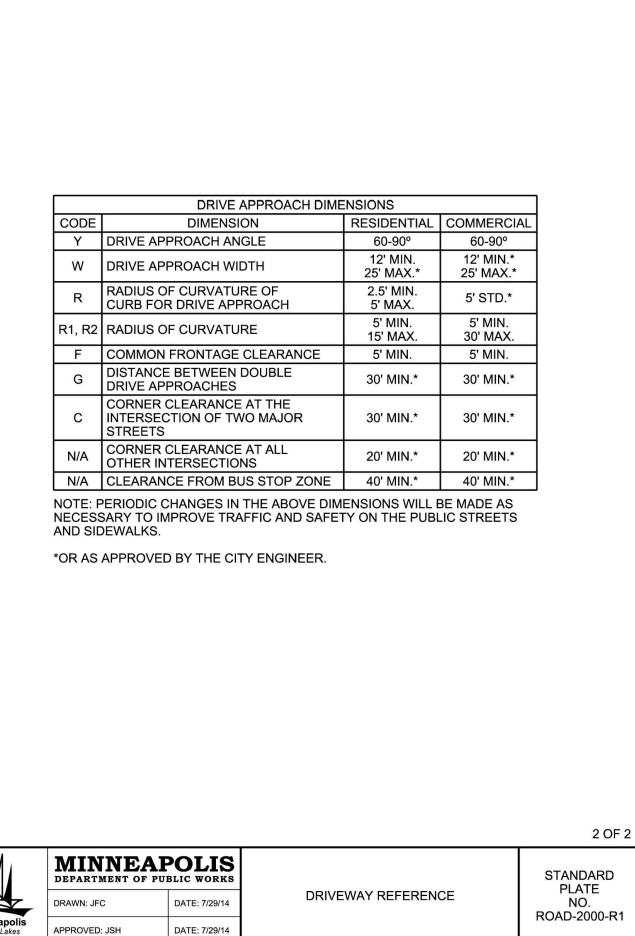



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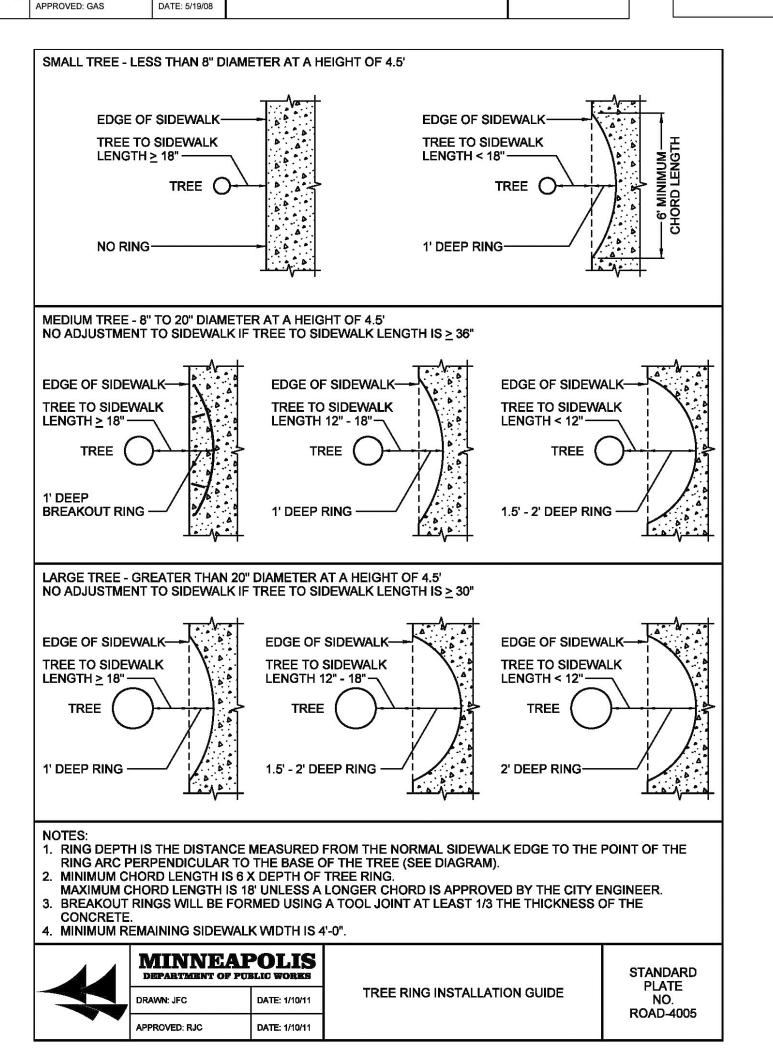
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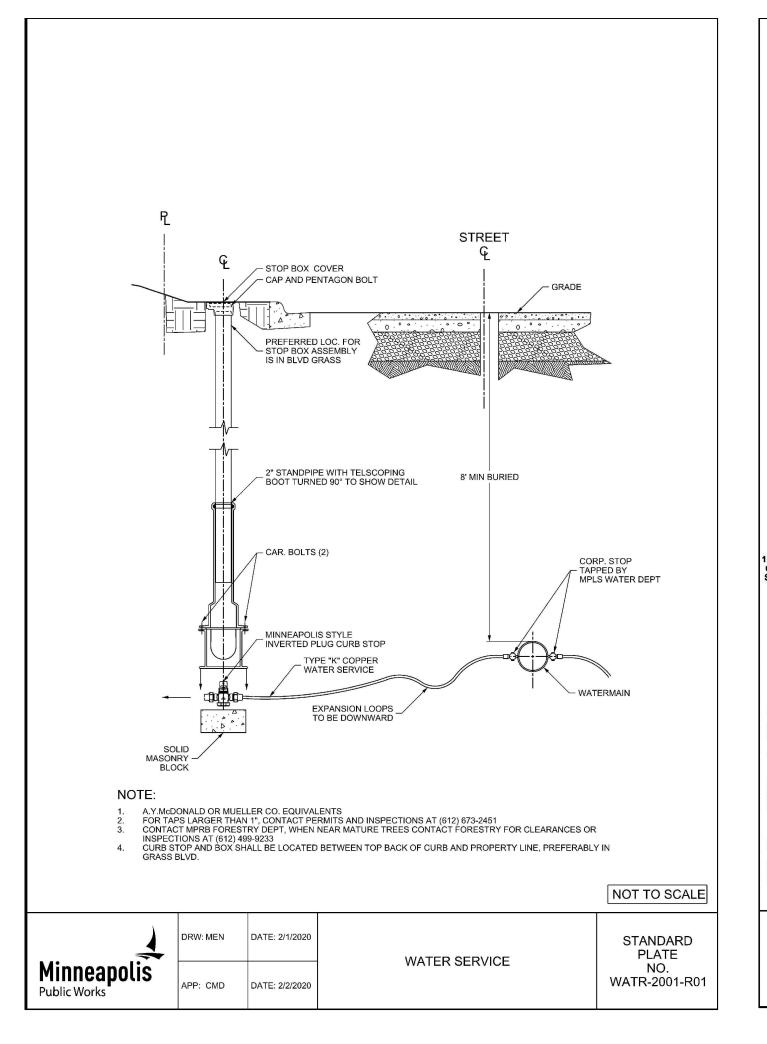





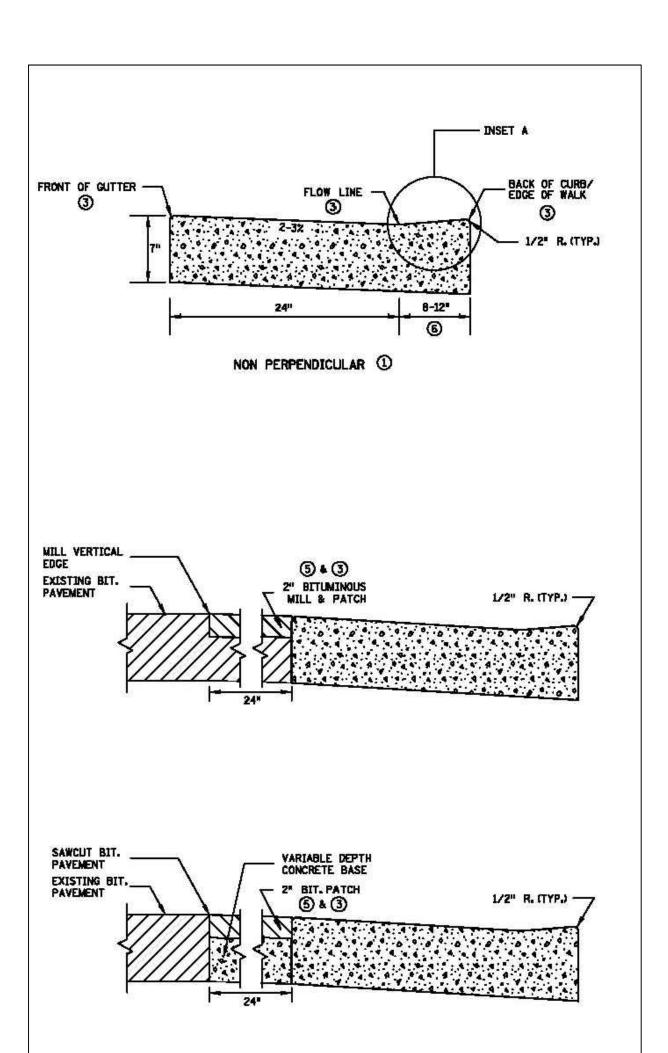


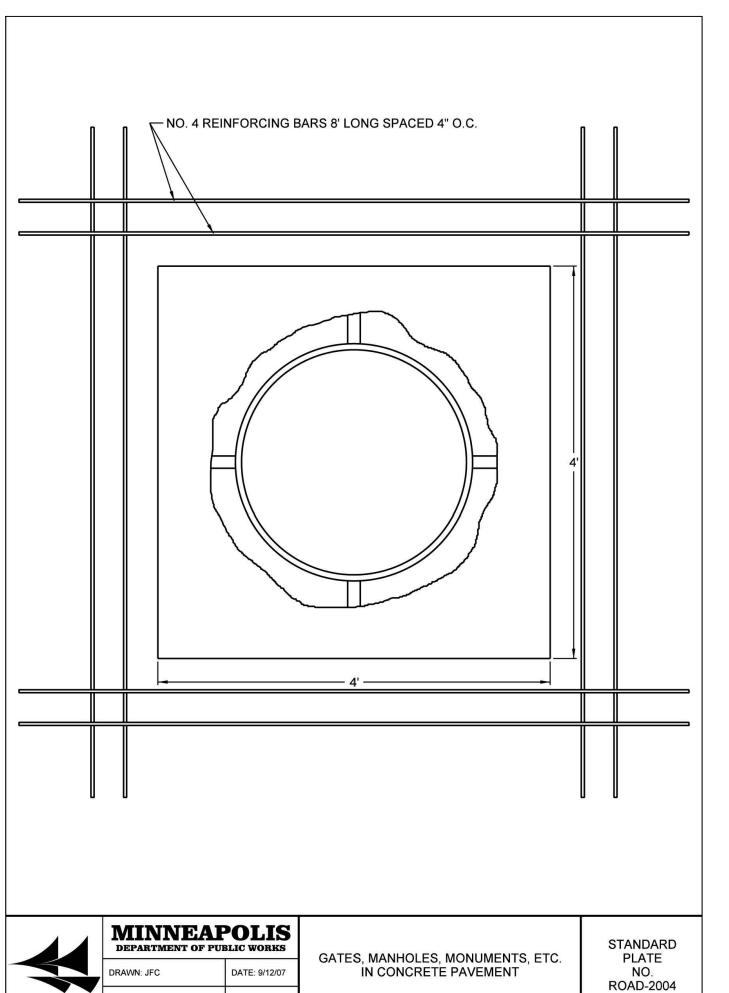

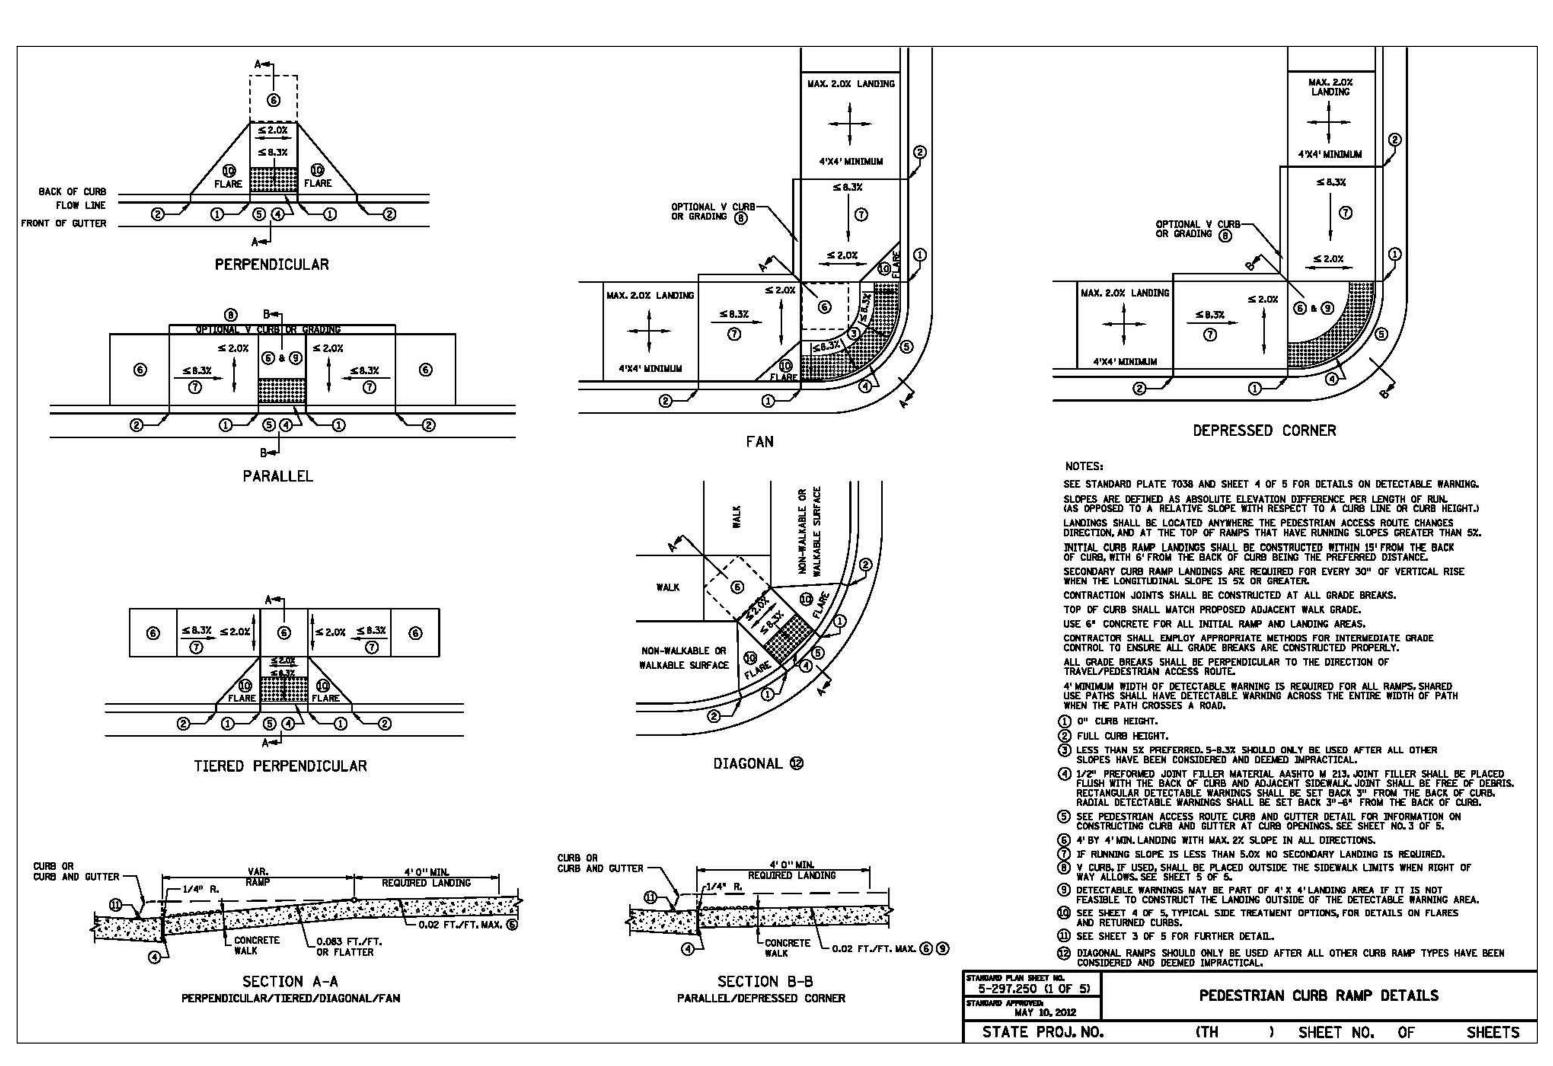

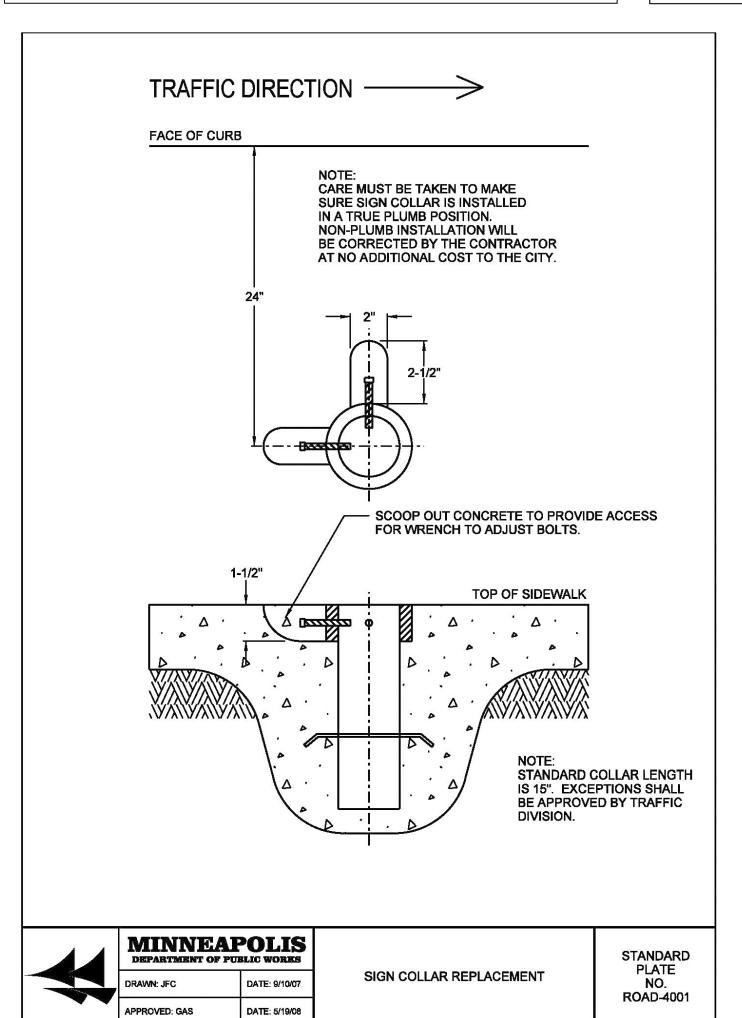

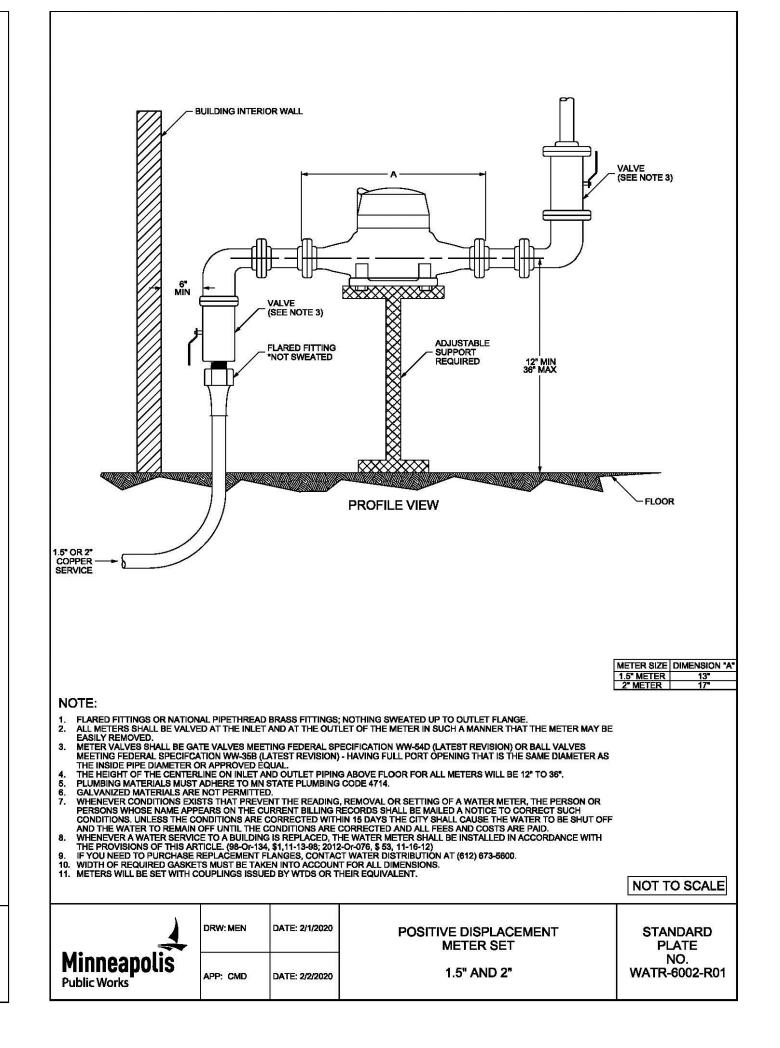

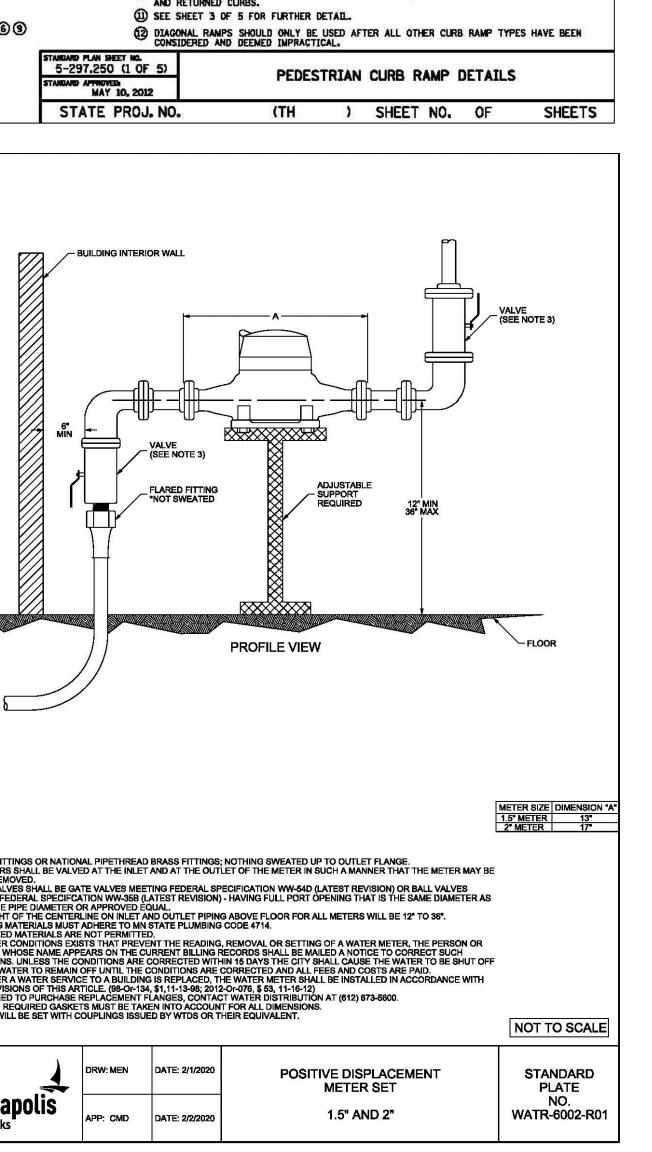

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LS

PROJECT TITLE: A New 6 Unit **Apartment Building** 2413 1st Ave S Minneapolis, MN 55404

SHEET TITLE: CIVIL DETAILS

PROJECT #: DRAWN BY:

I hereby certify that this plan specification or report was prepared by me or under my direct supervision and that I am a duly registered architect under the law of the state of: William M. Wells, Architect

SHEET NO:

C101

date: 5.22.2020 reg. no. 49615

STANDARD DEMOLITION AND EROSION CONTROL NOTES:

- Contractor must call for a pre-construction meeting 48 hours prior to any land disturbances 612-673-3867. Failure to do so may result in the revocation of permit and a stop work order being issued.
- Install perimeter erosion control at the locations shown on the plans prior to beginning construction or land disturbance. (Hay bales are not an acceptable perimeter control)
- Before beginning construction, install a temporary rock construction entrance at each point where vehicles exit the construction site. Use 2 inch or greater diameter rock in a layer at least 6 inches thick across the entire width of the entrance. Extend the rock entrance at least 50 feet into the construction zone. Use a geo-textile fabric beneath the aggregate in order to prevent migration of soil into the rock from below
- Remove all soils and sediments tracked or otherwise deposited onto public and private pavement areas. Removal shall be on a daily basis when tracking occurs. Sweeping may be ordered by at any time if conditions warrant. Sweeping shall be maintained throughout the duration of the construction and done in a manner to prevent dust being blown to adjacent properties.
- Install inlet protection at ALL public and private catch basin inlets, which receive runoff from the disturbed areas. Contractor shall clean, remove sediment or replace storm drain inlet protection devices on a routine basis such that devises are fully functional for the next rain event. Sediment deposited in and or plugging drainage systems is the responsibility of the contractor. NOTE: Hay bales or filter fabric wrapping the grates are not effective or acceptable form of inlet protection.
- Locate soil or dirt stockpiles no less than 25 feet from any public or private roadway or drainage channel. If remaining for more than seven days, stabilize the stockpiles by mulching, vegetative cover, tarps, or other means. Control erosion from all stockpiles by placing silt barriers around the piles. Temporary stockpiles located on paved surfaces must be no less than two feet from the drainage/gutter line and shall be covered if left more than 24 hours.
- Removal of all materials noted in the plans shall be in accordance with MNDOT, The State of Minnesota, and City Regulations and laws.
- All removed materials shall be disposed of to a legal off-site location.
- Damage done to neighboring properties during construction shall be the contractor's
- responsibility to repair and restore. • The contractor must provide a fence and site security to prevent falls.

- Maintain all temp erosion and sediment control devises in place until the contributing drainage area has been stabilized. Inspect temp erosion control and sediment control devices on a daily basis and replace deteriorated, damaged, or rotted erosion control devises immediately.
- Temporarily of permanently stabilize all construction areas which have undergone final grading, and all areas in which grading or site building construction operations are not actively underway against erosion due to rain, wind, and water within 7 to 14 days. use seed and mulch, erosion control matting, and or grass sod and staking in green space areas. Remove all temporary synthetic, structural, non-biodegradable erosion and sediment control devices after the site has undergone final stabilization and permanent vegetation has been established. Final stabilization for the purposes of this removal is 70% established cover over denuded areas.
- Ready mixed concrete and concrete batch plants prohibited within the public right of way. All concrete related production, cleaning, and mixing activities shal be done in designated concrete mixing and washout locations as shown in the erosion control plans. Under no circumstance may washout water drain onto the public right of way or into any public or private storm drain conveyance.
- Changes to the approved erosion control plan must be approved by the erosion control inspector prior to implementation. Contractor to provide installation and details for all proposed alternate types of devices.
- No Dewatering is needed for this site. If dewatering is needed the contractor must obtain a permit or approval for water discharge.
- Save and protect all trees in the right of way during construction with a chain link fence. and Tree Protection Notes on Sheet L200
- All existing building dimensions are measured to the finished siding and not the building foundation. No search was made for any easements.
- The location of all utilities shown are from either observed evidence in the field and/or from plans furnished by the utility companies and are approximate. Utility companies should be notified for exact location before doing any excavation.
- Protect any and all street signs from damage during construction.
- All unused existing water services within the proposed property limits shall be removed and abandoned back to the main per City of Minneapolis standards.

CALL BEFORE YOU DIG

THE CONTRACTOR MUST CALL GOPHER STATE ONE CALL BEFORE EXCAVATION. WWW.GOPHERSTATEONECALL.ORG 1-800-252-1166 651-454-0002

GENERAL EXCAVATION & SHORING NOTE:

DURING EXCAVATION FOR THE NEW FOUNDATION. THE SLOPES TO THE BOTTOM OF THE EXCAVATION CAN NOT EXCEED 1:1 AND THE CONTRACTOR MUST PROVIDE A FENCE AROUND THE SITE TO PREVENT UNAUTHORIZED ACCESS.

SHORING AND SECURITY FENCE MAY BE REQUIRED. DURING CONSTRUCTION THE CONTRACTOR SHALL DETERMINE IF CONTINUOUS SHORING AND A FENCE FOR FALL PROTECTION ALONG THE PROPERTY LINE AND AROUND THE SITE IS NECESSARY. CONTACT ARCHITECT IF SHORING IS NEEDED.

WIMCO - CATCH BASIN INLET PROTECTION DEVICE OVERFLOW (1) CENTER OF FILTER ASSEMBLY OVERFLOW ② TOP OF CURB BOX — 10" FILTER ASSEMBLY

CATCH BASIN NOTES

- 1. THE CONTRACTOR SHALL INSTALL INLET PROTECTION AT ALL IMPACTED CATCH BASINS NEAR THE SITE.
- 2. REPLACE INLET GRATE AFTER
- COMPLETE INSTALL OF DEVICE. 3. REMOVE ALL SEDIMENT AND DEBRI FROM THE SURFACE OF THE SYSTEM AFTER EACH STORM EVENT AND AT COMPLETION.
- 4. REFERENCE APPLE VALLEY STANDARD PLATE ER0-4C.

ZONING:

LOT COVERAGE CALCULATION:

PROPERTY DESCRIPTION

BENCHMARK

SITE SURVEYED BY

SURVEY NOTES:


 All existing building dimensions are measured to the finished siding and not the building foundation.

HIGH-FLOW FABRIC


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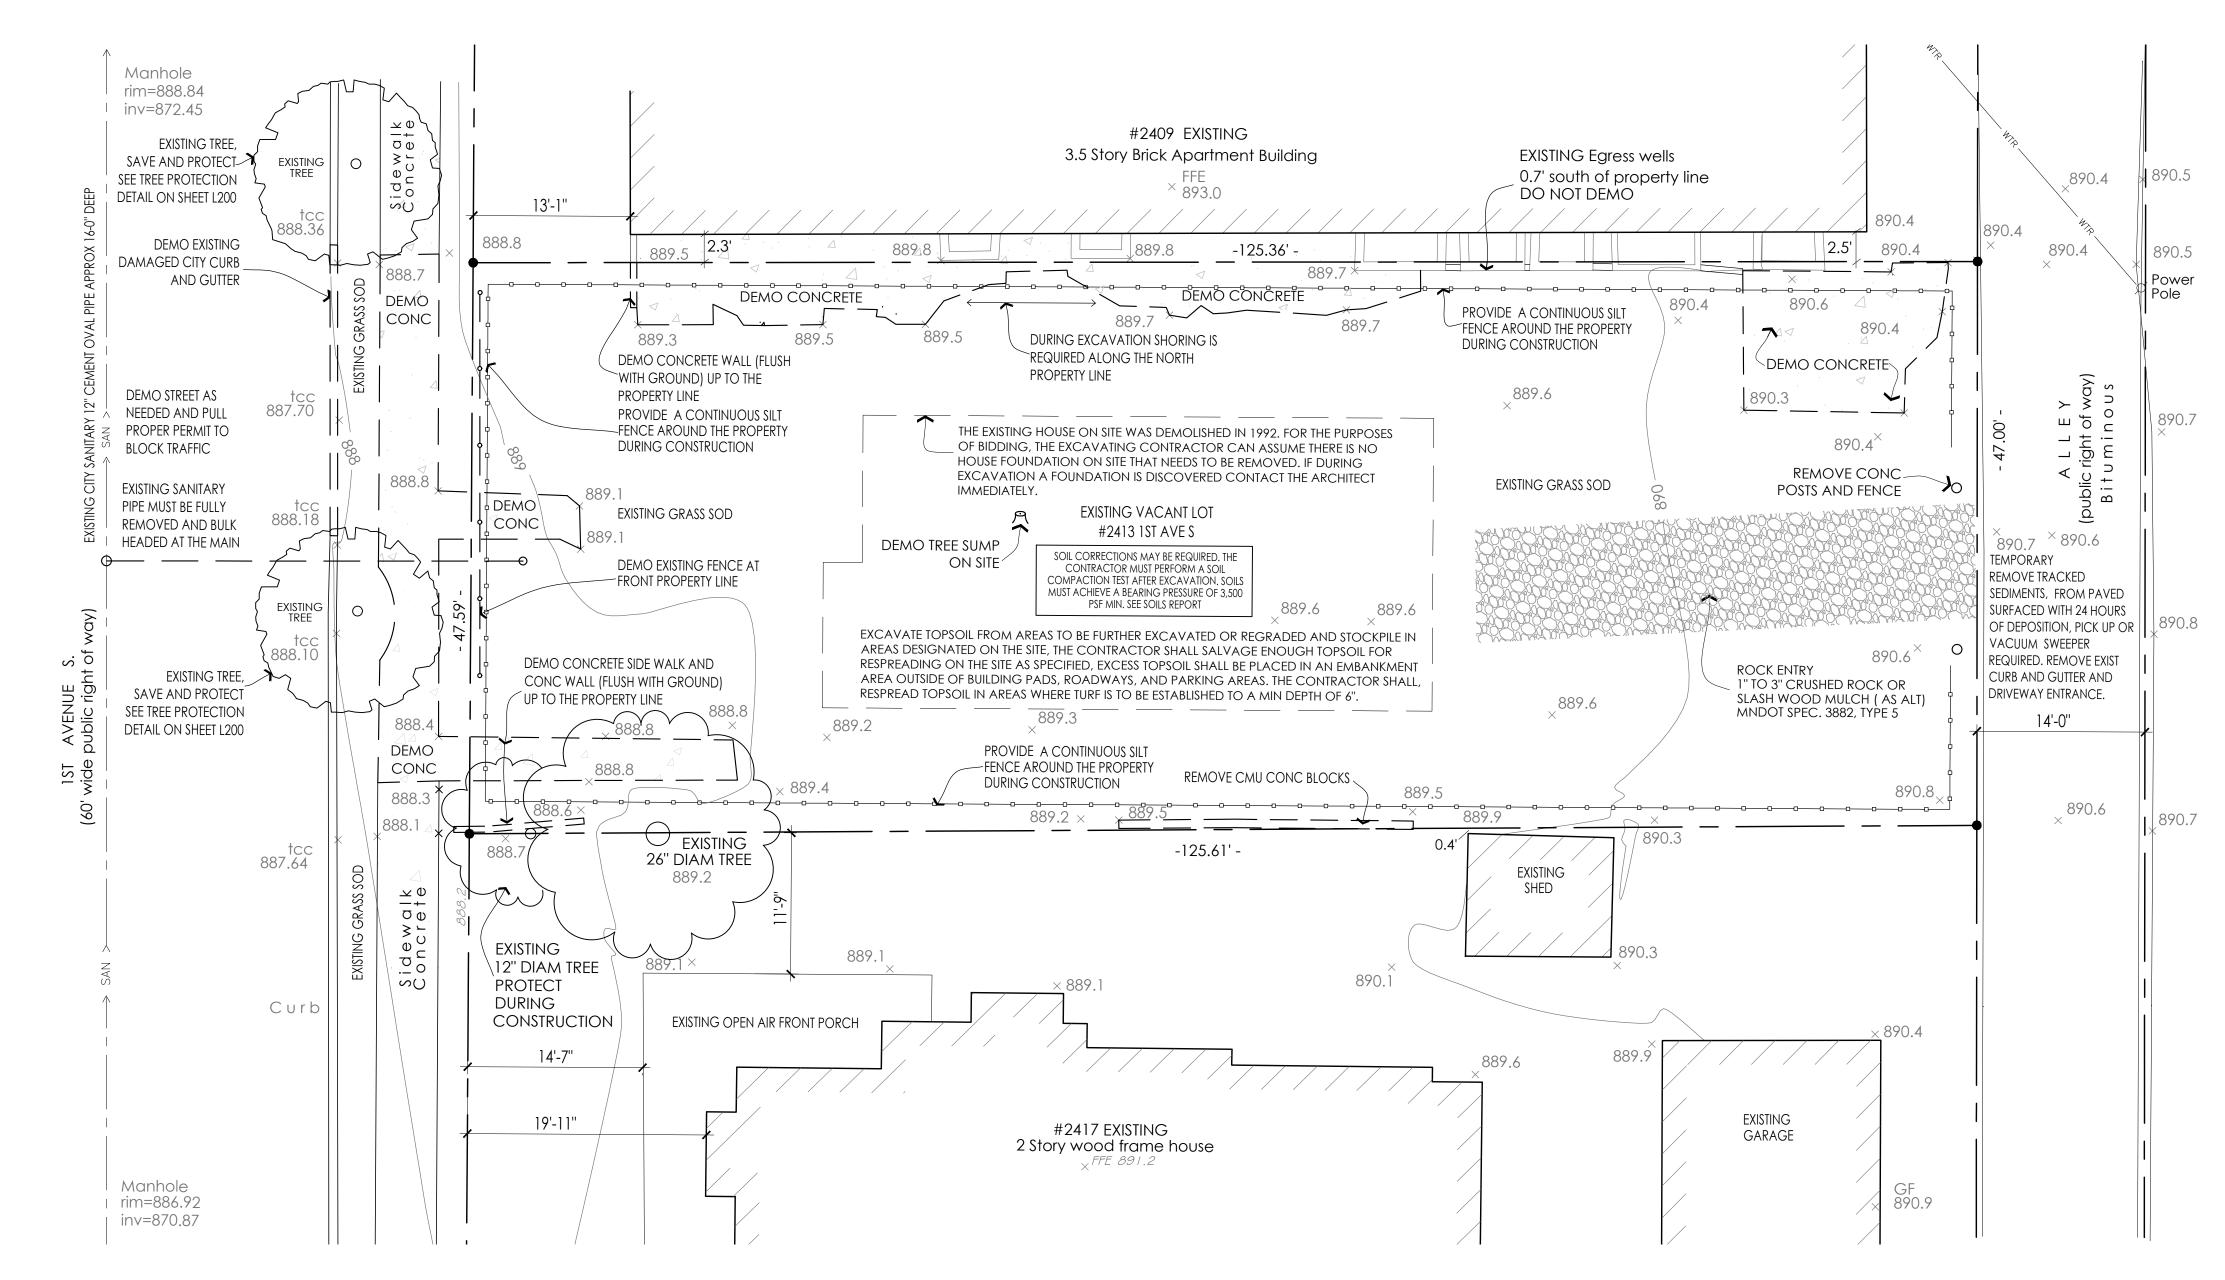
- No search was made for any easements.
- The location of all utilities shown are from either observed evidence in the field and/or from plans furnished by the utility companies and are approximate. Utility companies should be notified for exact location before doing any excavation.

SILT FENCE DETAIL

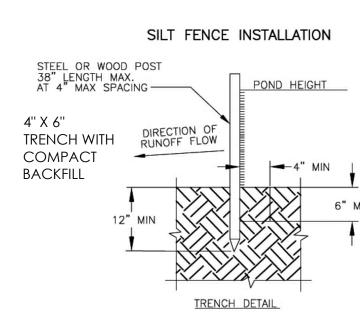


SYMBOL KEY



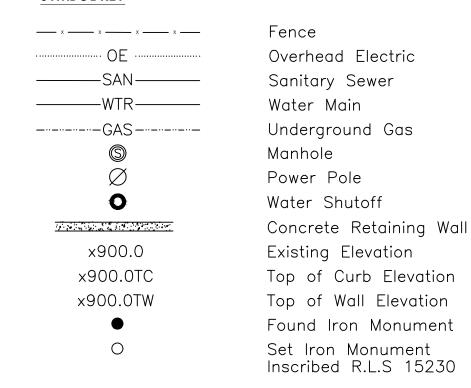



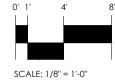



SHEET NO: C102

PLANS MUST BE PRINTED ON 24" X 36" SIZE PAPER TO BE AT SCALE

ANY OMP, E.C. So S Ш \triangleleft

PROJECT TITLE: A New 6 Unit **Apartment Building** 2413 1st Ave S Minneapolis, MN 55404

SHEET TITLE: DEMOLITION **EROSION CONTROL** PLAN AND NOTES

PROJECT #: DRAWN BY: CHECKED BY: WELLS

I hereby certify that this plan specification or report was prepared by me or under my direct supervision and that I am a duly registered architect under the law of the state of:

signed: W Wells William M. Wells, Architect date: 5.22.2020 reg. no. 49615

GENERAL SITE PLAN NOTES:

- See civil sheets C102 for erosion control plan and construction entrance.
- 2. Call the surveyor of record and have the proposed building staked before excavation.
- 3. Parkland Dedication Fee must be paid at the time the contractor picks up the permit. Minneapolis Ordinance 598.340
- 4. Contact Tom Frame 612-673-5807 to schedule an inspection need with Environmental Services to identify and register equipment and processes that impact the environment.
- 5. Street lighting installed as part of the Project shall be inspected by the City. Contractors shall arrange for inspections with the Traffic Department, please contact Dave Prehall at (612) 673-5759 for further information. Any lighting installations not meeting City
- specifications will be required to be reinstalled at Owner expense. 6. All snow shall be removed from the sidewalks.
- There is no long term snow storage on site.
- To protect root zones, no construction equipment or materials shall be placed, parked, or stored on any unpaved area within the drip line of any city owned tree. No chemicals or petroleum products shall be deposed of on any unpaved areas in the City-Right-of-Way.
- 9. Any Tree roots encountered are to be cleanly cut using hand tools.
- 10. No open excavation or bore pits allowed within 8' of city trees.
- 11. The Contractor must take care not to damage tree trunks or branches, contractor must contact forestry department inspections at 612-499-9233 at least 3 days prior to starting work to discuss any problems from trees in the City-Right-of-Way.
- 12. Contractor to verify locations and layouts of all site elements prior to beginning construction and have the site property lines staked by the surveyor of record.
- 13. The contractor must obtain all necessary permits prior to construction, including a right of way permit and/or street closure permit.
- 14. The Contractor must obtain soil borings before beginning the work and review the geo technical report.
- 15. The contractor must submit shop drawings and samples of all exterior building materials to the Owner and Architect for review before installation. Including: pavement, furnishings, benches, poles, lights, pavers, canopies, railings, etc.
- 16. Repair all city curb and gutter damaged during construction. Types shall be B624 unless otherwise noted on the plans. See civil sheet C100 and C101

REQUIREMENTS FOR OUTDOOR LIGHTING

shield for the the light source.

- Verify light fixture type and location of light fixture with owner before install. See light schedule on sheet E1
- The lighting plan must comply with Section 535.590 of the Minneapolis Zoning Code.
- Lighting levels shown on the site plan are in Footcandles.
- Lighting on the exterior must be on a photo censor located on the roof.
- See sheet E1 for comprehensive list of all light fixture locations, schedules, and switches. • Per Minneapolis Zoning Code: Lighting fixtures shall not exceed two thousand (2,000) lumens equivalent to a one hundred fifty (150) watt incandescent bulb unless there is a
- The lighting must comply with Section 535.590 of the Minneapolis Zoning Code. The lighting fixtures shall not exceed two thousand (2,000) lumens equivalent to a one hundred fifty (150) watt incandescent bulb) unless of a cutoff type that shields the light source from an observer at the closest property line of any permitted or conditional residential use. The lighting fixtures shall be effectively arranged as not to directly or indirectly cause illumination or glare in excess of one-half (½) footcandle for residential use, & five (5) footcandles measured at the street, curb or nonresidential property line nearest the light source.

LANDSCAPE DESIGN AND INSTALLATION NOTES:

- The landscape contractor and all subcontractors shall inspect the site and become familiar with the existing conditions relating to the nature and scope of the work, before providing a bid on the project.
- The landscape contractor shall verify plant layout, drainage, and dimensions on site and bring any discrepancies to the attention of the architect. The landscape contractor shall not change plant types without architect or Owner's written permission. The landscape contractor shall install all new plants and trees after all grading and construction has been completed and provide a one year warranty.
- The landscape contractor shall Sod all existing grass areas disturbed due to grading and construction. Where sod abuts paved surfaces, the finished grade or sod shall be held to 1" below the surface elevation of the paved area. The sod shall be laid parallel to the contours and shall have staggered joints.
- The landscape contractor shall assure compliance with all applicable codes and regulations governing the work and or materials supplied and all plant materials installed comply with the latest edition of the American Standards for Nursery Stock, ANSI Z60.1 unless noted otherwise.

LANDSCAPE DESIGN AND INSTALLATION NOTES CONTINUED

- The landscape contractor shall ensure all planting areas receiving ground cover, perennials, or annuals shall receive a minimum of 18" depth of planting soil consisting of at least 45 parts topsoil, 45 parts screened compost or manure and 10 parts sand.
- The landscape contractor shall provide min 4" deep shredded hardwood mulch in all shrub and plant beds as shown on plans, provide a fiber mat weed barrier.
- All trees that are to remain are to be protected from damage with a construction fence at the drip line. See landscape documents.
- There are no known non-storm water discharges on the existing site and non are proposed
- Grading on this sheet shows the design intent, the contractor must field verify and ensure that no areas are slopes less than 1%. Finished grade shall be uniform and smooth. All disturbed areas shall be restore. All boulevards & neighboring property to be repaired.
- Retaining walls taller than 3'-0" must be designed by a structural engineer.
- See sheet L200 for additional site plan and landscape notes:

GENERAL NOTE:

ALL PLANT MATERIALS SHALL CONFIRM WITH THE AMERICAN ASSOCIATION OF NURSERYMEN STANDARDS AND SHALL BE OF HARDY STOCK, FREE FROM DISEASE, DAMAGE AND DISFIGURATION, THE CONTRACTOR IS RESPONSIBLE FOR MAINTAINING PLUMBNESS OF PLANT MATERIALS. ALL PLANTS MUST HAVE A ONE YEAR WARRANTY FROM SUBSTANTIAL COMPLETION DATE. COORDINATE LOCATION OF SHRUBS AND TREES WITH UTILITIES, DOORS, AND SITE FURNISHINGS, ALL TREES AND SHRUBS MUST BE WATERED. If during excavation a water supply well is found the City will be notified, and proper permits will be pulled to seal the well per State of Regulation.

SITE PLAN NOTES CONTINUE ON SHEET L200 ...

REQUIRED LANDSCAPING PER MINNEAPOLIS ZONING CODE


Per Minneapolis Zoning Code at least 20 percent of the site not occupied by the building must be landscaped and the Applicant must provide one canopy tree per 500 saft of the required landscaped area. The

per 100 saft of the required landscaped area.

2,000 saft of Building Area 3,934 saft of site area not occupied by building. x 20% required by Zoning Code. Applicant must provide at least one shrub per

5,934 sqft Total Lot Area

786 sqft required landscaping Canopy Trees Required (1 per 500 sqft) 8 Shrubs Required (1 per 100 sqft)

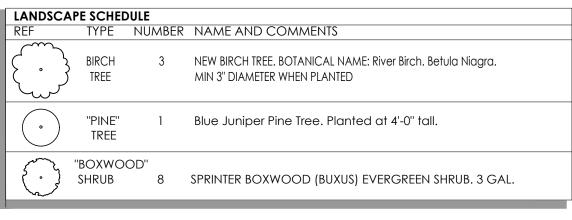

BENCHMARK

Minneapolis Monument No. 461 located at East 22nd St and Nicollett Ave S. Elev = 894.44 FIRE HYDRANT LOCATION:

The nearest fire hydrant is located less than 150' away on the corner of 1st Ave S and 24th St E

SITE PLAN DATA: LOT SIZE 5,934 saft 2,000 sqft **BUILDING FOOTPRINT**

SIDEWALKS 600 saft 100 saft **EGRESS WINDOW WELLS** DRIVEWAY 1,200 sqft TOTAL IMPERVIOUS SURFACE


GRASS AND LANDSCAPING INCLUDES PERVIOUS PAVERS

So S 3,900 sqft 66% OF SITE Ш 2,034 sqft 34% OF SITE 890.4

ANY

OMP,

 \bigcirc

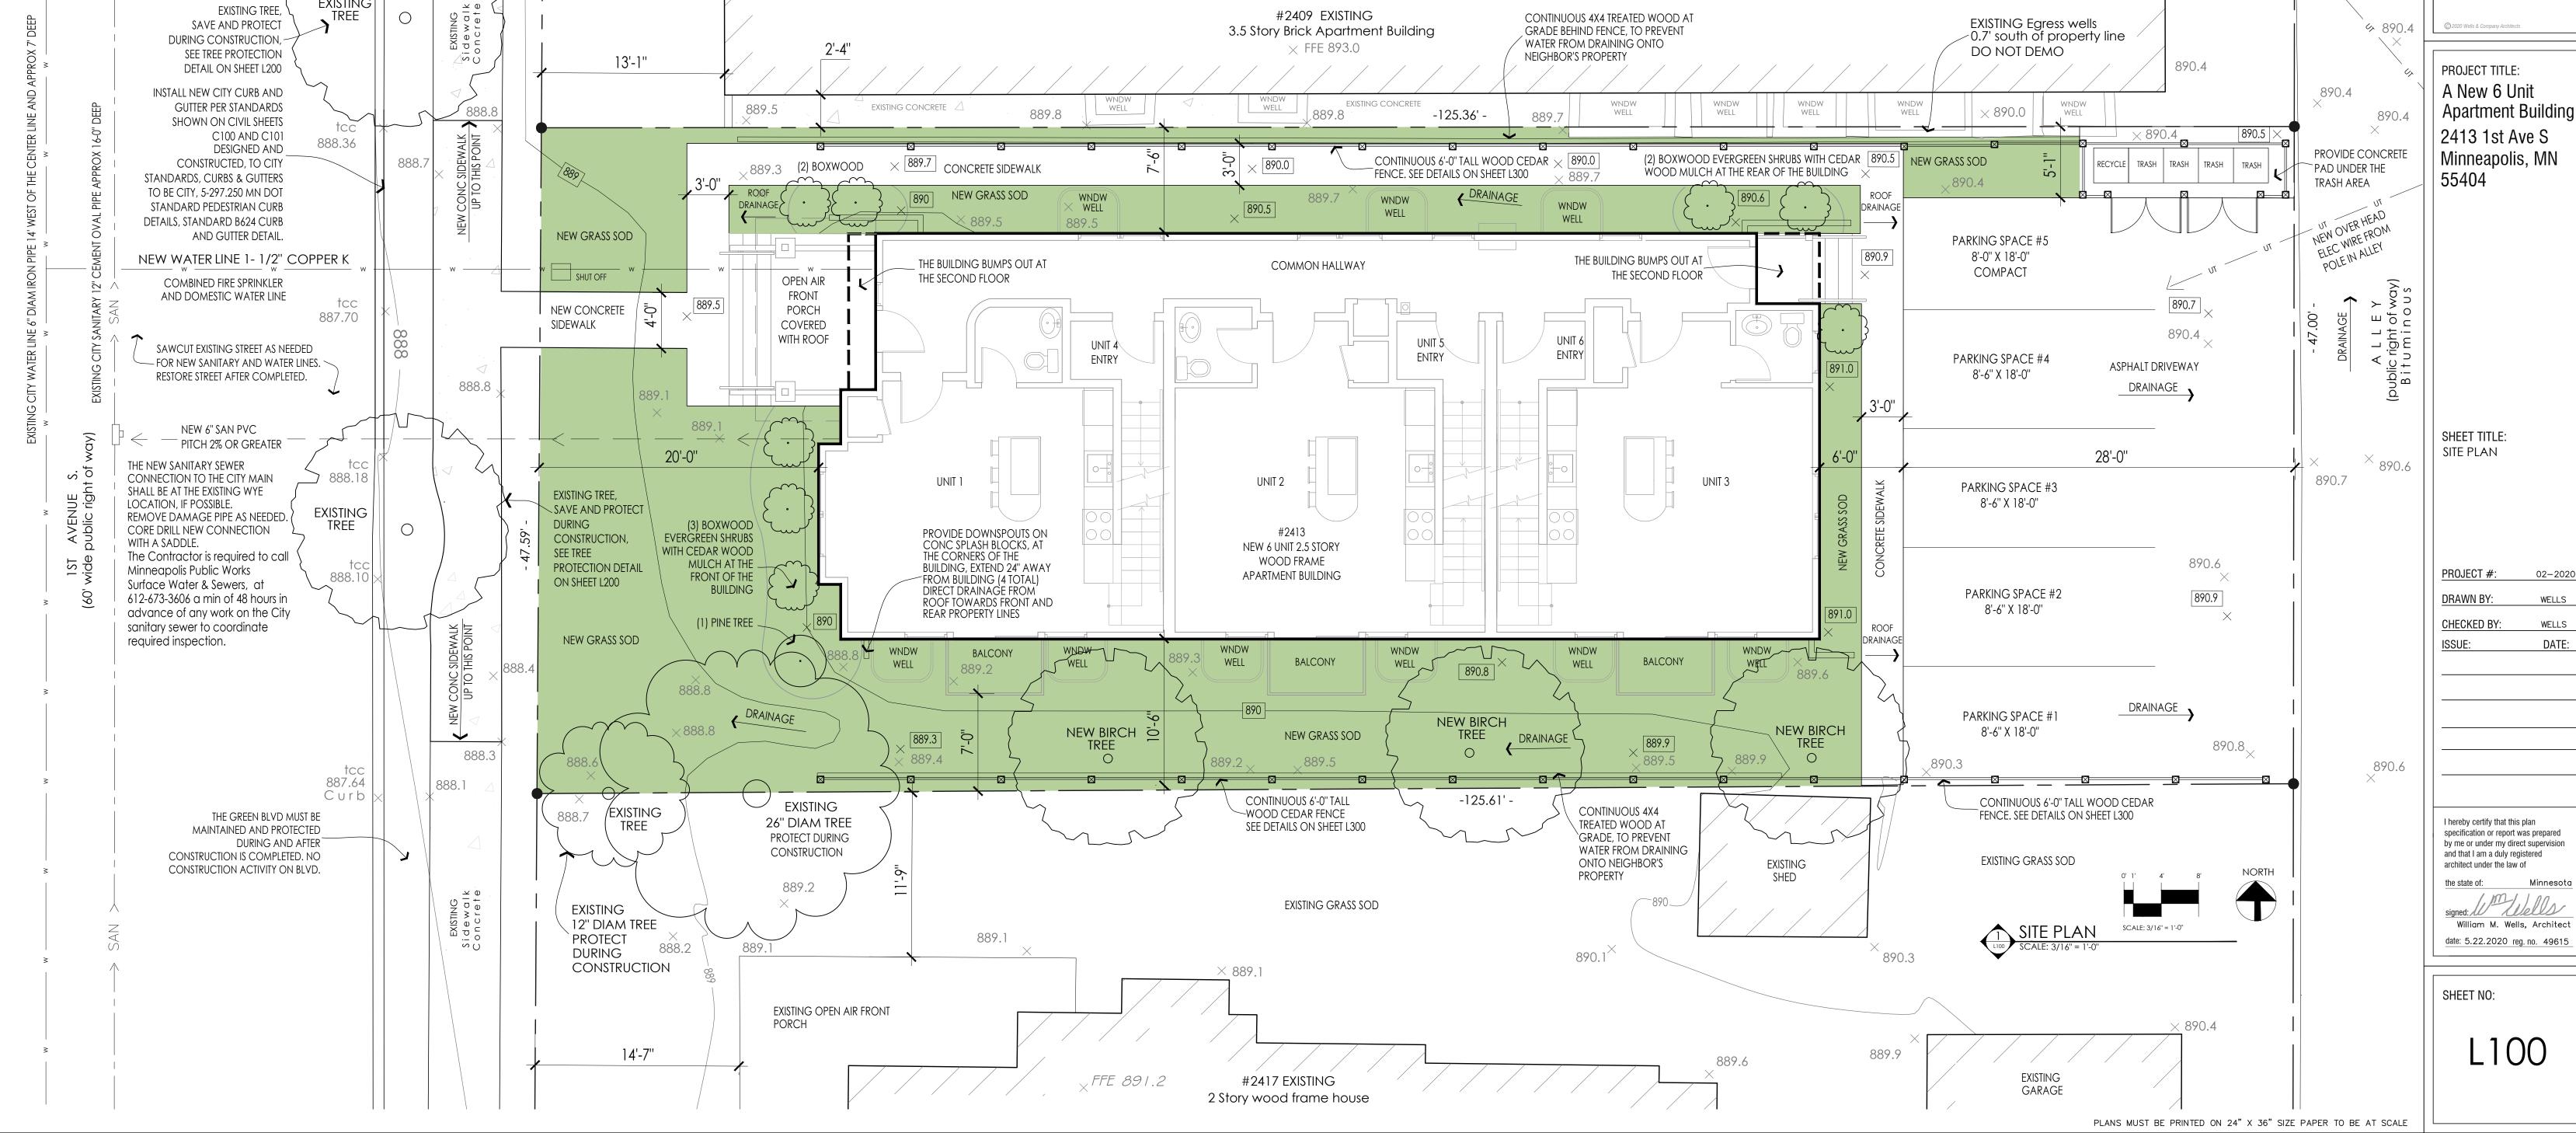

Plant material standards.


Landscape species shall be indigenous or proven adaptable to the climate, but shall not be invasive on native species. Plant materials shall comply with the following standards:

- All required trees shall be a minimum of two and one-half (2.5) inches caliper in size, except cluster or multiple trunk specimens, which shall be a minimum of one
- (1) inch caliper in size. All required shrubs shall be a minimum of one (1) gallon container size.
- All landscape materials shall be tolerant of specific site conditions, including but not limited to heat, cold, drought and salt Landscape materials that are used for screening shall be of a size that allows

growth to the desired height and opacity within two (2) years.

Installation and maintenance of materials.

- All landscape materials shall comply with the following standards: 1. Areas to be landscaped shall be prepared and improved as specified by current Minnesota Department of Transportation standards for soil
- preparation and drainage. All landscape materials shall be installed to current industry standards.
- Maintenance & replacement of landscape materials shall be the responsibility of the applicant or property owner including the maintenance of any trees planted in the public right-of-way. An adequate water supply shall be indicated in the site plan. Landscape maintenance should incorporate environmentally sound management practices, including the following:
 - a. The use of water and energy efficient systems such as drip
 - b. Pruning primarily for plant health and replacing dead materials
 - c. Anticipating and allowing plant community succession.

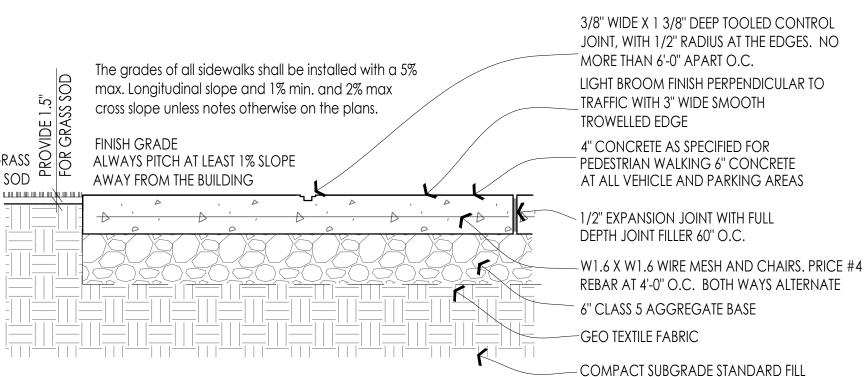

3" DECOMPOSED

BARK MULCH

2" WIDE WOVEN NYLON BINDINGS USE

2" x 2" HARDWOOD STAKES DRIVEN FIRMLY

WITH A MIN. OF 18" INTO THE SUB-GRADE

REMOVE TOP $\frac{1}{3}$ " OF BURLAP CUT ROPES

AT TOP OF BALL. REMOVE ALL

CREATE TOPSOIL SAUCER

NON-BIODEGRADABLE MATERIAL

WITH CONTINUOUS 75 MM (3") RIM

GENTLY COMPACTED TOPSOIL MIXTURE

TO ALNAS STANDARD "WELL GROOMED" SOIL


BINDINGS ON MAJOR STRUCTURAL

BRANCHES. ATTACH TO STAKE WITH

SHINGLE NAIL

PRIOR TO BACKFILING

SHRUB AND TREE PLANTING DETAIL

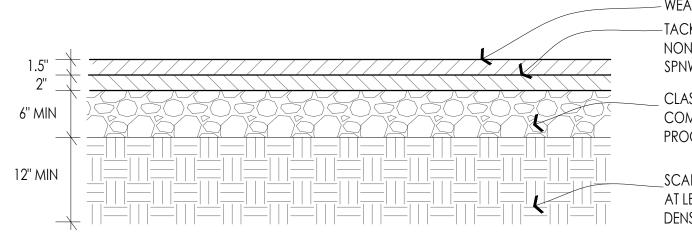

- WEAR COURSE PER MN/DOT 2360 SPWEA240 TACK COAT PER MN/DOT 2357 NON-WEARING COURSE PER MN/DOT 2360 SPNWB230

GENERAL NOTE

STAKE TO FIRST BRANCHES AS NECESSARY FOR FIRM

SUPPORT. THE WIRE SHALL NOT TOUCH OR RUB

ADJACENT TRUNKS OR BRANCHES

-CREATE TOPSOIL SAUCER (6") MIN

REMOVE TOP $\frac{1}{3}$ " OF BURLAP CUT

NON-BIODEGRADABLE MATERIAL

TO BOLNA STANDARD "WELL

GROOMED" SOIL

ROPES AT TOP OF BALL. REMOVE ALL

GENTLY COMPACT TOPSOIL MIXTURE

TAMPERED ADMIXTURES BACKFILL.

THIN BRANCHES BY \frac{1}{3} RETAIN

NORMAL PLANT SHAPE

-MULCH 4" DEEF

CLASS 5 AGGREGATE PER MN/DOT 3138 COMPACTED TO AT LEAST 100% STANDARD PROCTOR DENSITY


SCARIFY AND RECOMPACT SUBGRADE TO AT LEAST 100% STANDARD PROCTOR DENSITY-PROOF ROLL PER MN DOT 2111

BITUMINUOUS DRIVEWAY AND PARKING LOT

CONC SIDEWALK AND PARKING AREA

SIDEWALK NOTES:

- ALWAYS FOLLOW THE CITY OF MINNEAPOLIS SIDEWALK SPECIFICATIONS SHOWN ON SHEET CO AND C1.
- INSTALLATION AND REINFORCEMENT SHALL BE CERTIFIED AND IN ACCORDANCE TO AN ON-SITE A.C.I. TECHNICIAN AS SPECIFIED.
- SEE GEO-TECHNICAL RECOMMENDATIONS FOR GROSS WEIGHT REQUIREMENTS.
- SEE LAYOUT DRAWINGS FOR LIMITS OF WALKS.
- SEE CONCRETE JOINT DETAIL FOR REQUIREMENTS
- 6. 1/2" WIDE EXPANSION JOINT AND SEALANT AT ALL CURBS.
- WIRE MESH AND CHAIRS REQUIRED FOR ALL WALKS OR IN LOCATIONS FOR VEHICULAR TRAFFIC.

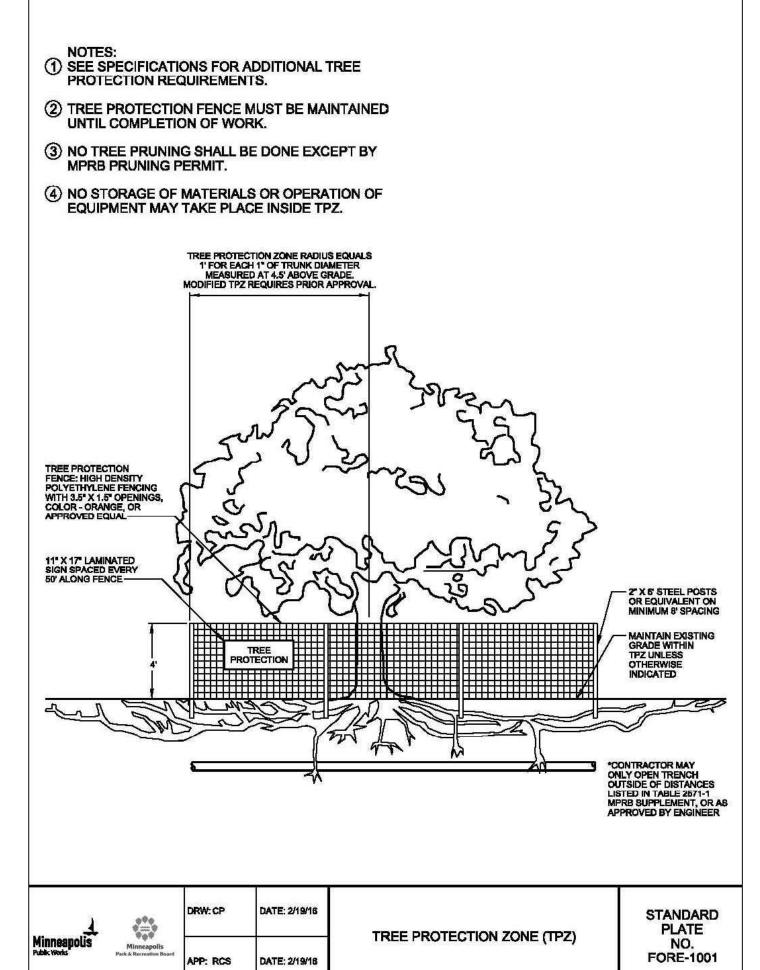

Minneapolis Park & Recreation Board

TREE PROTECTION SPECIFICATIONS

General - Tree protection has three primary functions: (1) to avoid physical damage from contact by equipment, materials, and activities; (2) to preserve roots and soil conditions in an intact and non-compacted state; and (3) to identify the Tree Protection Zone (TPZ) in which no soil disturbance is permitted and activities are restricted.

a. The Tree Protection Zone (TPZ) is a restricted area around the base of the tree at the drip line with a minimum radius of 1 foot for each inch DBH enclosed by fencing. **No work, storage, or equipment operation shall be** performed in this area.

b. Tree Protection: The fence shall enclose the entire area of the TPZ of the tree(s) to be protected for the duration of the construction project. For trees situated within a boulevard or near a sidewalk or driveway, only the planting strip and yard side of the TPZ shall be enclosed with the required protective fencing. Paved surfaces within the drip line may be excluded from the TPZ. Modified Tree protection zones may be specified by MPRB Forestry based on site restrictions.

c. Size, type, and area to be fenced: All trees to be preserved shall be protected with four (4) foot high fencing. Fencing is to be mounted on heavy duty steel T-posts driven into the ground to a depth of at least one (1) foot, six (6) inches (18" minimum) and no more than eight (8) foot spacing.

d. Warning Sign: A weatherproof warning sign shall be prominently displayed on each fence at 20-foot intervals on the tree protection fencing. The sign shall be a minimum 8.5 inches by 11 inches and clearly state: "WARNING - Tree Protection Zone".

e. Duration: Tree fencing shall be erected before construction begins and remain in place until final inspection of the

*An occupancy fence excluding trees from the work area is acceptable provided it meets specified clearance from any trees.

* The applicant shall be responsible for the repair or replacement of any publicly-owned trees that are damaged during the course of construction.

3. The following tree preservation measures apply to all trees to be saved:

(a) No storage of material, topsoil, vehicles, or equipment shall be permitted on unpaved surfaces within the TPZ. (b) The ground within the TPZ shall not be altered.

GENERAL SITE PLAN NOTES CONTINUED:

RIGHT OF WAY NOTES:

- Temporary and permanent related encroachments in the public right of way requires a permit, contact Robert Boblett at 612-673-2428 for more information.
- Snow storage is not permitted in the public right of way. • Contact Craig Pinkalla at 612-499-9233 cpinkalla@minneapolisparks.org regarding any questions related to planting,
- An obstruction permit is required anytime construction work is performed in the Public right-of-way. Please contact Scott Kramer at 612-673-2383 regarding details of sidewalk & lane closures. Log on to http://minneapolis.mn.roway.net/ for a permit.
- Contact Allan Klugman at (612) 673-2743 prior to construction for the temporary removal/relocation of any City of
- Mpls signal system that may be in the way of construction. All costs for relocation and/or repair of City Traffic facilities shall be borne by the Contractor.

removal, or the process for protecting trees during construction in the City Right of Way.

• Contact Doug Maday at (612) 673-5755 prior to construction for the removal of any City of Minneapolis right of way signs that may be in the way of construction.

WATER LINE, FIRE SPRINKLER LINE, AND SEWER (UTILITY DESIGN) NOTES:

- Provide COMBINED FIRE AND DOMESTIC Copper "K" domestic water line services to the building with water shut off valve. The shut off valve must be on private property. See site plan for sizes.
- The meters shall be located in the mechanical rooms.
- For comments or questions on Public Works Surface Water & Sewers Division related requirements please contact Jeremy
- Strehlo, (Professional Engineer) at (612) 673-3973, or jeremy.strehlo@minneapolismn.gov.
- There is no non-storm water discharge proposed.
- Contact Rock Rogers at 612-673-2286 to review domestic service design, and connections.
- Domestic water and fire service connections should run in a line perpendicular from the watermain straight into the building to the meter location, and be stubbed 12" above the floor line.
- The sewer line must have a min 2% positive slope from the building mech rm to existing sewer line in the public street. • The City of Minneapolis Water Treatment & Distribution Services Division requires that domestic water and fire supply service lines
- shall be sized based upon the total demand and shall be determined in accordance with recognized engineering methods and procedures. The contractor must submit calculations and shop drawings at the time of permitting, designing the domestic water and fire supply systems, and ensuring they are not oversized for their intended use so that turnover is sufficient to maintain water quality. Provide copies of shop drawing and calculations to the Architect and City before installing the water lines.
- Any existing water service connections to the site shall be noted on the plans for removal and shall be removed per the requirements of the **Utility Connections Department** before any new service lines can be installed, call **(612) 673-2451** for more information

CONSTRUCTION CODE SERVICES / BUILDING CODES

- During excavation for the new foundation, the slopes to the bottom of the excavation can not exceed 1:1 and the contractor must provide a fence around the site at all times to prevent unauthorized access. See structural sheets for shoring specifications.
- A Service Availability Charge (SAC) determination letter from the Met Council must be submitted with the building permit application. • See floor plans for individual unit addressing. Post signage in the front and in the rear on the building to be readily identified in case of fire or other emergency.

- If impacted soil are encountered, work must stop and notification provided to the MN State Duty officer at 615-649-5451.
- If dewatering is required during site construction see below for city permit requirements. The highest groundwater level expected for this site should be determined and used in establishing the basement floor with allowances water table fluctuations. Subgrade structures should be designed to prevent infiltration of groundwater without the need for a permanent dewatering system being installed. If a continuously operating permanent dewatering system is needed it must be approved as part of the sanitary sewer and storm drain site plan approval prior to construction beginning.
- The highest groundwater level expected for this site should be determined and used in establishing the lowest level for subgrade structures. A safety margin of at least two feet is recommended as ground water levels seasonal fluctuate and can be affected by local rain events. If soil borings deeper than 15 feet must be done a Temporary Environmental Well permit must be obtained by environmental services. If dewatering is required during site construction, see below for city permit requirements. Subgrade structures should be designed to prevent infiltration of groundwater without the need for a permanent dewatering system being installed. If a continuously operating permanent dewatering system is needed it must be approved as park of the sanitary sewer and storm drain site plan approval prior to construction beginning.
- No construction, demolition, or commercial power maintenance equipment shall be operated within the City between the hours of 6pm to 7pm on weekdays or during and hours on Saturdays, Sundays, and state and federal holidays, except under permit, Contact Environmental Services at 612-673-3516 for permit information.
- Permits and approvals are required from Environmental Services for the following activities: Temporary storage of impacted soils on site prior to disposal or reuse; Reuse of impacted soils on site; Dewatering and discharge of accumulated storm water or ground water, underground or aboveground tank installation or removal, well construction or sealing. Contact Tom Frame at 612-673-5807 for permit applications and approvals.

STREETS, SIDEWALKS, TRAFFIC AND PARKING NOTES:

- All driveway aprons, curbs, and gutters must be designed and constructed to City standards. All driveway aprons shall be shown graphically correct on all related plan sheets with the correct radii. Please refer to the following: http://www.minneapolismn.gov/publicworks/plates/public-works_road. For further information contact Paul Miller at (612) 673-3603 or paul.miller@minneapolismn.gov.
- A sidewalk construction permit must be obtained before the start of any work in the public right of way. The contractor must replace any concrete infrastructure in the City right of Way that is damaged during construction. A \$15,000 Sidewalk Contractor's Bond must be obtained from Public Works Sidewalk Inspections prior to the start of any work in the Public right-of-way.
- An obstruction permit is required before any work is performed in the public right of way. Contact Scott Kramer at 612-673-2383 for sidewalk and lane closures.
- All parking lot paint stripping to be white 4" wide typical. All trash removal shall occur at the driveway entrance.
- The Owner is responsible for ordering all dumpsters and trash bins
- AN ENCROACHMENT PERMIT IS NEEDED FOR ANY HANDRAILS OR FENCES PROPOSED IN THE PUBLIC RIGHT OF WAY.

CITY OF MINNEAPOLIS UTILITY NOTES:

- The contractor or property owner shall contact Minneapolis surface waters and sewers 48 hours prior to any excavation or construction related to or in the location of the proposed stormwater management BMP (contact Paul Chellsen 612-673-2406)
- Upon the project's completion, the general contractor, property owner, or responsible party, shall provide to the department of public works a final stormwater management report including record drawings. This report will serve as a means of verification that the intent of the approved stormwater management design has been met. This final report shall substantiate that all aspects of the original design have been adequately provide for by the construction of the project.
- The contractor shall sawcut and remove public pavements, curbs, and walks, for installation of utilities, upon completion of utility work replace all materials, in kind, and to city standards and approval.
- The contractor shall cut off, plug, and abandon all unused existing sanitary services at right of way line.
- The Contractor and subcontractors shall field verify location and elevations of existing utilities and topographic features prior to construction, the contractor shall immediately notify the architect regarding any discrepancies or variations from the plans.
- All existing utility locations shown are approximate and must be field verified. The Contractor must contact Gopher State One Call at 1-800-252-1166 to locate utilities, 48 hours prior to construction, the contractor shall repair or replace any utilities that are damaged during construction at no cost to the Owner.
- A min of 8'-0" of ground cover is required over all watermain lines, unless otherwise noted, extra depth may be required to maintain a min of 18" vertical separation to sanitary or storm sewer lines, A min of 18" of vertical separation and 10' of horizontal separation is required for all utilities, unless otherwise noted.
- All connections to existing utilities shall be in accordance with City Standards and coordinated with the City prior to Construction. All proposed work in the Public right-of-way shall comply with the current edition of the City of Minneapolis Standard Supplemental Specifications for Construction and Minnesota Department of Transportation Standard Specifications for Construction, current edition and its attachments, please refer to the following website: http://www.minneapolismn.gov/publicworks/plates/index.htm

ANY OMP, E C \bigcirc So S 山 丘 \triangleleft

A New 6 Unit Apartment Building 2413 1st Ave S Minneapolis, MN 55404

PROJECT TITLE:

SHEET TITLE: SITE PLAN DETAILS

AND NOTES


PROJECT #: 02-2020 DRAWN BY: CHECKED BY:

I hereby certify that this plan specification or report was prepared by me or under my direct supervision and that I am a duly registered architect under the law of

the state of: William M. Wells, Architect date: 5.22.2020 reg. no. 49615

SHEET NO:


L200

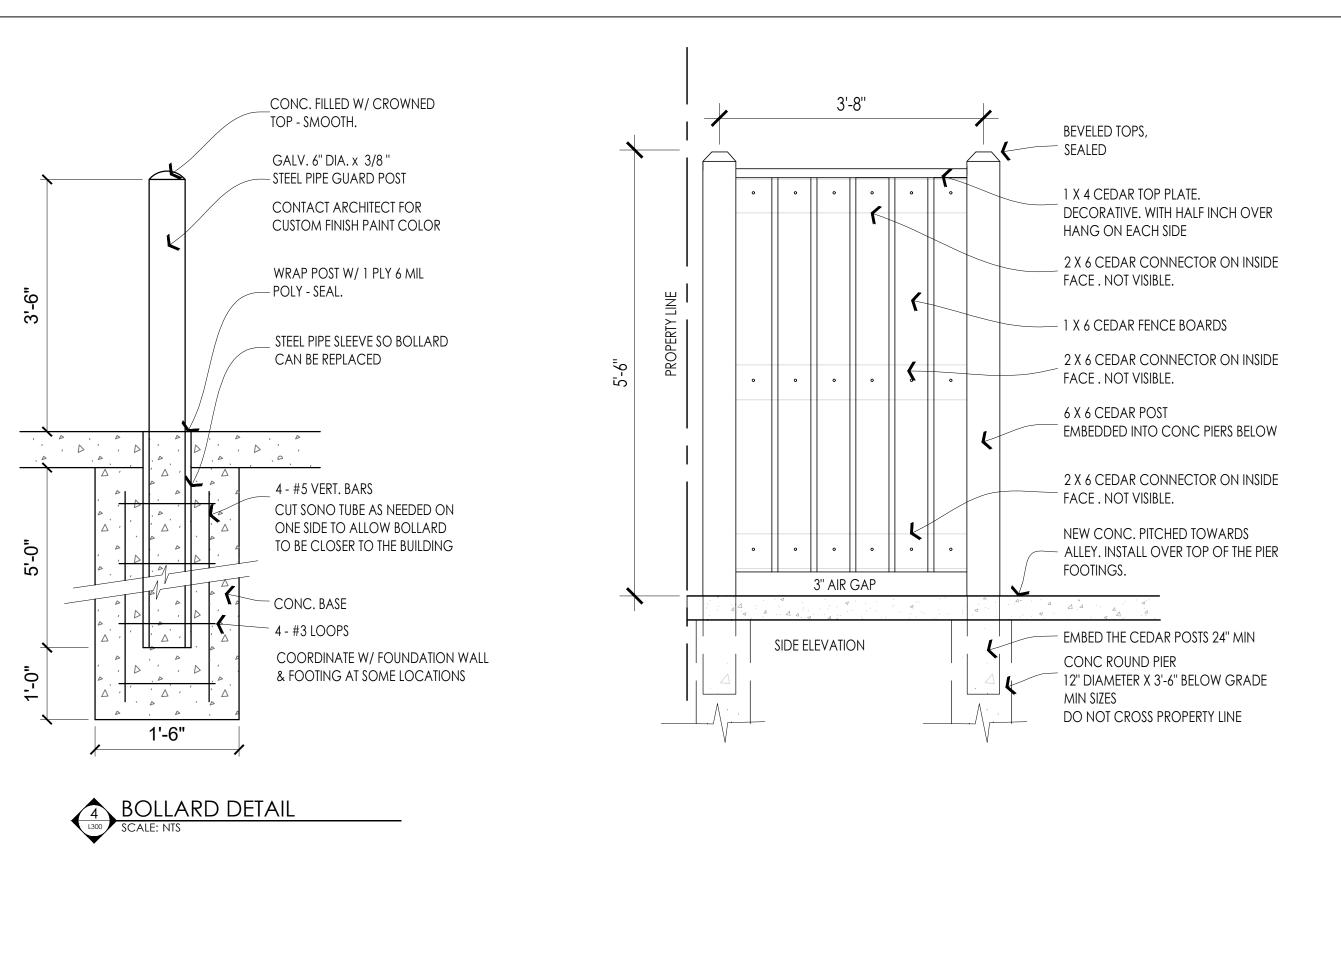

REQUIREMENTS FOR OUTDOOR LIGHTING

- Per Minneapolis Zoning Code: Lighting fixtures shall not exceed two thousand (2,000) lumens equivalent to a one hundred fifty (150) watt incandescent bulb unless there is a shield for the the light source.
- Lighting fixtures shall be effectively arranged so as not to directly or indirectly cause illumination or glare in excess of one-half (1/2) footcandle measured at the closest property line of any permitted or conditional residential use, and five (5) footcandles measured at the street curb line or nonresidential property line nearest the light source.
- Verify light fixture type and location of light fixture with owner before install. see light schedule on sheet E1
- The lighting plan must comply with Section 535.590 of the Minneapolis
- Lighting levels shown on the site plan are in Footcandles.
- Lighting on the exterior must be on a photo censor located on the roof. See sheet E1 for comprehensive list of all light fixture locations, schedules, and switches.

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APPROX $\frac{3}{4}$ " AIR GAP BETWEEN THE

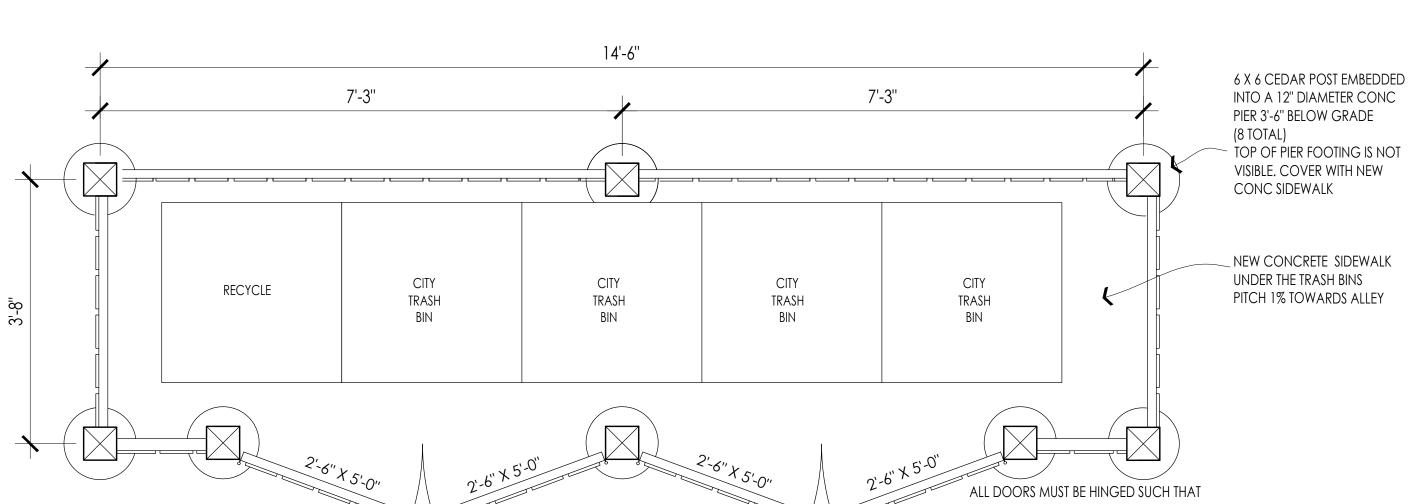
DOORS WHEN FULLY CLOSED


3" AIR GAP

THEY CAN OPEN 180 DEGREES

THE DOORS MUST BE ABLE TO

OPEN THE FULL 180 DEGREES

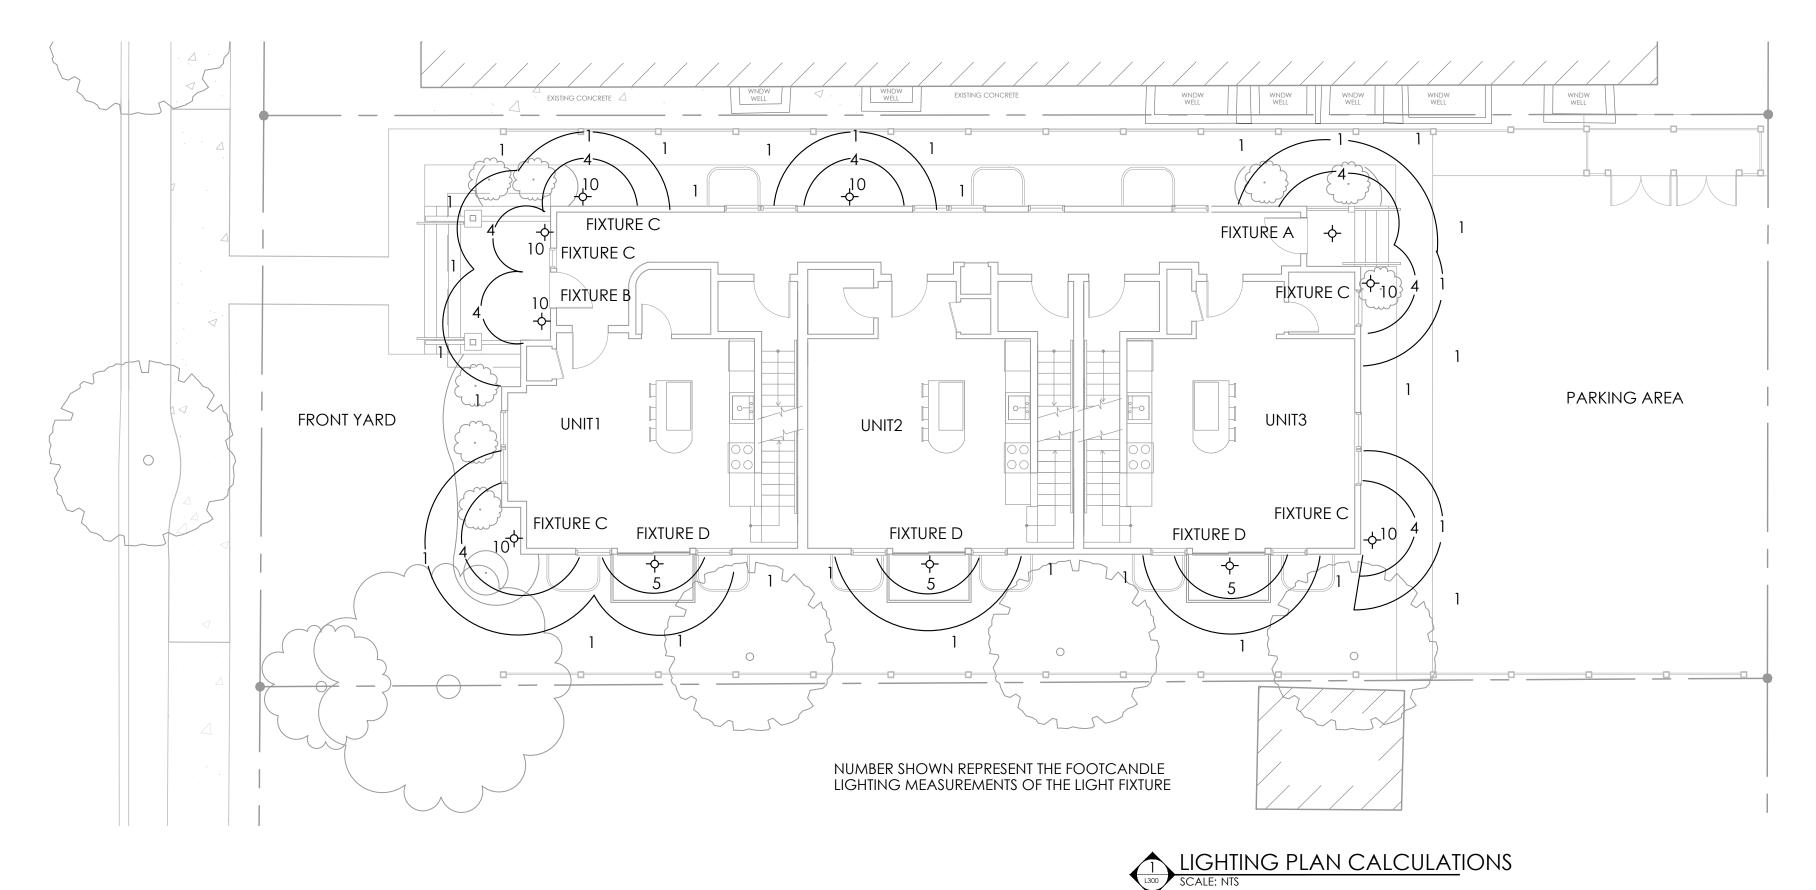

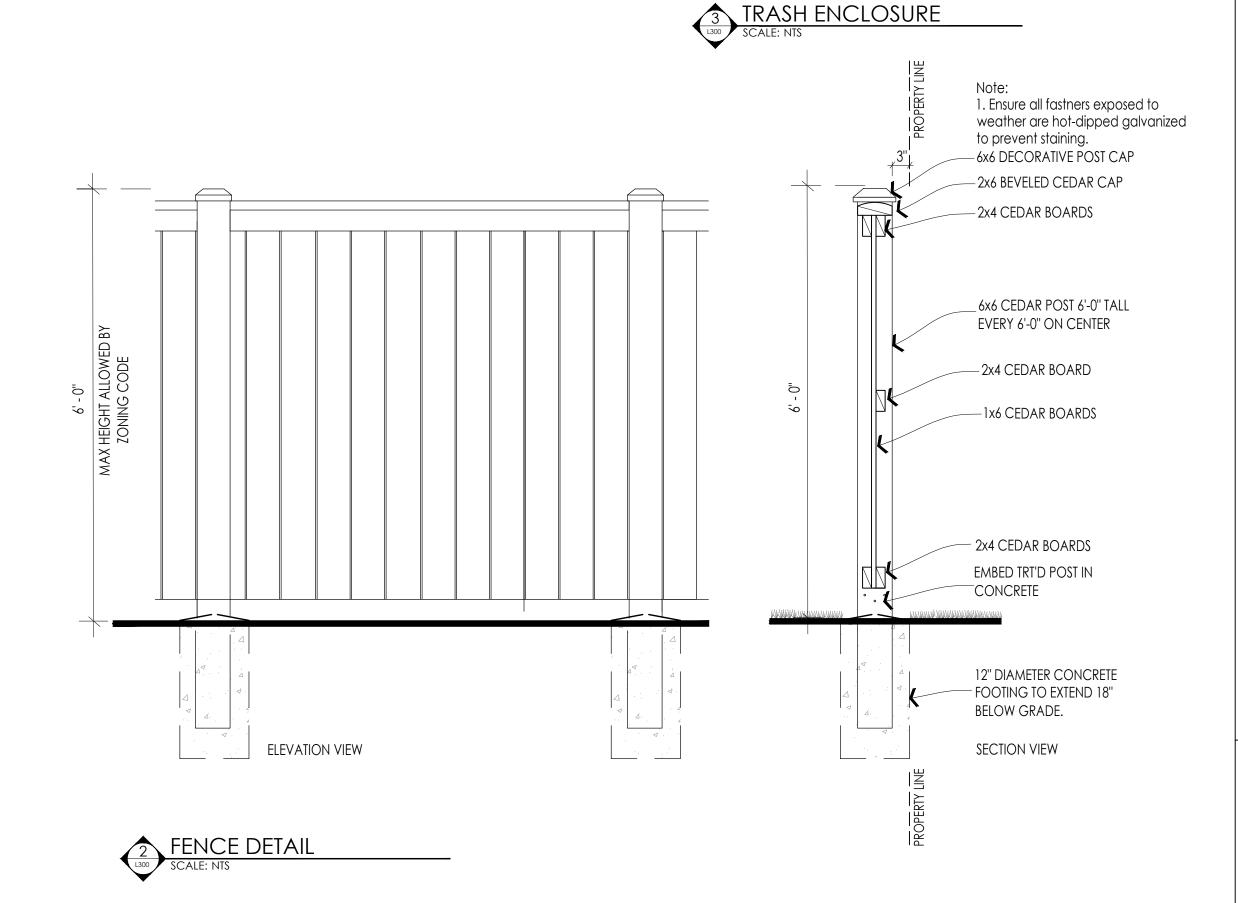

APPROX $\frac{3}{4}$ AIR GAP BETWEEN THE

DOORS WHEN FULLY CLOSED

OMPANY FECTS \odot So WELLS A R C F

DOORS MUST BE HINGED SUCH THAT

1" DIAMETER 24" LONG CANE BOLT

2 X 4 CEDAR CONNECTOR ON INSIDE

THEY CAN OPEN 180 DEGREES

(2 TOTAL)

FACE. NOT VISIBLE.

INFILTRATION

3" AIR GAP

- 1 X 4 CEDAR FENCE BOARDS

6 X 6 CEDAR POST WITH A BEVELED

CONCRETE SIDEWALK UNDER THE

EMBED THE POST 24" MIN.

SHALL COVER THE PIERS.

THE NEW CONC PIERS MUST BE

BELOW GRADE MIN . (8 TOTAL)

THE NEW CONCRETE SIDEWALK

12" DIAMETER MIN AND 3'-6"

DUMPSTER. PITCH TOWARDS THE ALLEY

TOP. SEAL THE TOP TO PREVENT WATER

 $\frac{3}{4}$ " PIPE SET INTO CONCRETE PAD (2 TOTAL)

PROJECT TITLE: A New 6 Unit **Apartment Building** 2413 1st Ave S Minneapolis, MN 55404

SHEET TITLE: SITE PLAN DETAILS AND NOTES

PROJECT #: DRAWN BY: CHECKED BY:

I hereby certify that this plan specification or report was prepared by me or under my direct supervision and that I am a duly registered architect under the law of the state of:

William M. Wells, Architect date: 5.22.2020 reg. no. 49615

SHEET NO:

L300

2012 IBC BUILDING CODE REQUIREMENTS FOR STAIRWAYS 1. Any wood touching concrete must be treated wood. 16. All windows that are operable shall be equipped with a screen and fall prevention device that • In Group R2 occupancies, the maximum riser height shall be 7.75" and the minimum tread depth shall be 10". A nosing not less than .75" but not more than 1.25" shall be provided on 2. See structural sheets for footing and foundation specifications. limits the window opening to less than 4" in accordance with MSBC 1303.2320 stairways with solid risers where the tread depth is less than 11" 3. All mechanical, electrical, and plumbing is design-build. 17. Carbon monoxide alarms required in accordance with MN Stat 299F.50. Can not be more than • The min width of a stairway in a dwelling unit is 36" 4. All subs must verify plumbing and mechanical layouts with owner prior to install. 10'-0" from a bedroom door. • Stairways shall have a min head room clearance of 80" 5. The following subcontractors and consultants must provide shop drawings to architect for review: 18. Interior and exterior signage required to identity unit numbers. • Handrails shall be 34" to 36" above the stair tread - HVAC / Mechanical subcontractor 19. HVAC piping conveying fluids above 105 to below 55 degrees F must be insulated to R-3 or higher. - Floor & Roof truss manufacturer 20. Smoke detectors shall be installed: on each level on the unit, and in all bedrooms, and in the STAIR SECTION ALLOWED INSIDE A DWELLING UNIT: - Window and door shop drawings hallway outside the bedrooms. Smoke alarms shall receive their primary power from the building - Fire sprinkler drawings wiring where such wiring is served from a commercial source and shall be equipped with a battery 10" TREAD MEASURED 6. Always slope concrete and soils around the building away from the foundation. 2% min slope. backup. Smoke alarms shall emit a signal when the batteries are low. Wiring shall be permanent NOSE TO NOSE 7. See "T sheets" for wall types and wall construction details. and without a disconnecting switch. Smoke alarms are not required to be equipped with a battery CODE MIN ALL STAIR RISERS AND TREADS MUST HAVE A backup in Group R2 occupancy equipped throughout with an automatic sprinkler system. 8. See sheet E1, E2, for electrical and lighting plan. 10.75" CODE MIN UNIFORM DIMENSION IN 9. The floor and roof truss system shall be pre-manufactured wood trusses. See structural sheets for size and 21. ALL BEDROOMS MUST HAVE AUDIBLE FIRE ALARMS. A FLIGHT OF STAIRS specs. The contractor must coordinate all shop drawings and provide plans to architect for review, 22. Radon mitigation required in the building. See "T sheets" for specs. Provide electrical outlet in the before ordering the trusses. attic for future radon fan as required by code. see "T sheets" for specs. 7.75" CODE MAX .75" | MIN NOSE 10. All dryers must vent to the exterior. Insulate ducts to R-8 continuous 3'-0" from exterior wall. Always 23. All outlets in kitchen and bathrooms must be GFI outlets. provide a floor drain near the washer / dryer in all units. 24. Max allowable floor truss deflection allowed for truss design is 0.75" under max load. 11. In the case of ambiguities, discrepancies, or irregularities, in the drawings, the contractor must request 25. The general contractor shall call Gopher State One Call before excavating to locate underground clarification from the architect before proceeding. Liability for proceeding without obtaining clarification from the architect will be borne solely by the contractor. 26 Every excavation on a site located 5 feet or less from the street property line shall be enclosed with 12. Do not scale the drawings to build walls or install windows, fixtures, or purchase equipment. a barrier not less than 6'-0" high, when located more than 5 feet from the street lot line, a barrier 13. The general contractor and all subcontractors must visit the site prior to providing bids. The general shall be erected when required by the building official. Barriers shall be of adequate strength to GENERAL STRUCTURAL NOTES: contractor is responsible for field verifying all dimensions and existing conditions prior to construction. resist wind pressure. ALL POINT LOADS MUST BE BLOCKED SOLID DOWN TO FNDN, THROUGH 27. Contractor shall coordinate inspections with third party special inspectors, as required. The special 14. All toilets must have a min 18" clear space on each side from the centerline of the toilet to the face of FLOOR TRUSS CAVITY SPACE. 2. CONTRACTOR MUST PROVIDE ROOF AND FLOOR TRUSS SHOP DRAWINGS the finished wall. inspections schedules are shown on the structural sheets. The special inspections are coordinated by the Contractor and paid for directly by the Owner. 15. All bedrooms must contain a smoke detector, and carbon monoxide detector within 10' of the bedroom TO ARCHITECT FOR REVIEW, BEFORE ORDERING THE TRUSSES. 3. MAX FLOOR TRUSS DEFLECTION IS: door. All bedrooms must have a closet, egress window, and electrical outlets and fixtures per code. Smoke detectors shall be provided in accordance with UL 217 & installed in accordance with MNSBC & SPAN / 480 LIVE LOAD. NOT TO EXCEED 0.75" OF TOTAL DEFLECTION. NFPA 72 UNDER MAX LOAD CONDITIONS. 5'-8'' 69'-4" · A A . A. **FURNACE** FURNACE ON RAISED SUMP ON RAISED CONC CONC PAD PAD MECH RM HW PANEL OFFICE ON RAISED FIRE SPRINKLER RISER. SEE FIRE SPRINKLER SHOP DRAWINGS DRYER MECH RM UNIT 103 BASEMENT UP 🔷 SD Co WASHER **BASEMENT** WASHER WASHER **BASEMENT** CLOSET CLOSET

BEDROOM 1

3'-0"

BEDROOM 2

SD

9'-4 1/2"

23'-0''

70'-0''

CLOSET

CLOSET

BEDROOM 1

A.A. M. A.

23'-6"

BEDROOM 2

3'-0"

CLOSET

8'-1 1/2"

SYMBOL KEY AND WALL TYPES

CONC FOUNDATION WALL

EXTERIOR 2X6 INSULATED WALL INTERIOR 2X4 LOAD BEARING WALL

INTERIOR 2X4 NON-LOAD BEARING WALL

SMOKE / CO DETECTOR
HARDWIRED AND INTERCONNECTED WITH BATTERY BACKUP WINDOW AND DOOR REFERENCE TAG SEE SCHEDULE AND SPECS ON "T SHEETS"



FURNACE

CONC

DRYER

BEDROOM 1

3'-0''

23'-6"

8'-6"

BEDROOM 2

UNDER THE MN STATE BUILDING CODE 2015 SECTION 903.2.8 THIS BUILDING MUST BE SPRINKLED TO NFPA 13-R BECAUSE THE BUILDING IS MORE THAN 4,500 SQFT.

COMPANY T E C T S , ∡ ⊥ ∨ LS C F WEL A R © 2020 Wells & Company Architects PROJECT TITLE:

A New 6 Unit Apartment Building 2413 1st Ave S Minneapolis, MN 55404

SHEET TITLE: BASEMENT FLOOR PLAN SCALE: 3/8" = 1'-0"

PROJECT #: DRAWN BY: CHECKED BY:


I hereby certify that this plan specification or report was prepared by me or under my direct supervision

architect under the law of

and that I am a duly registered

William M. Wells, Architect date: 5.22.2020 reg. no. 49615

SHEET NO:

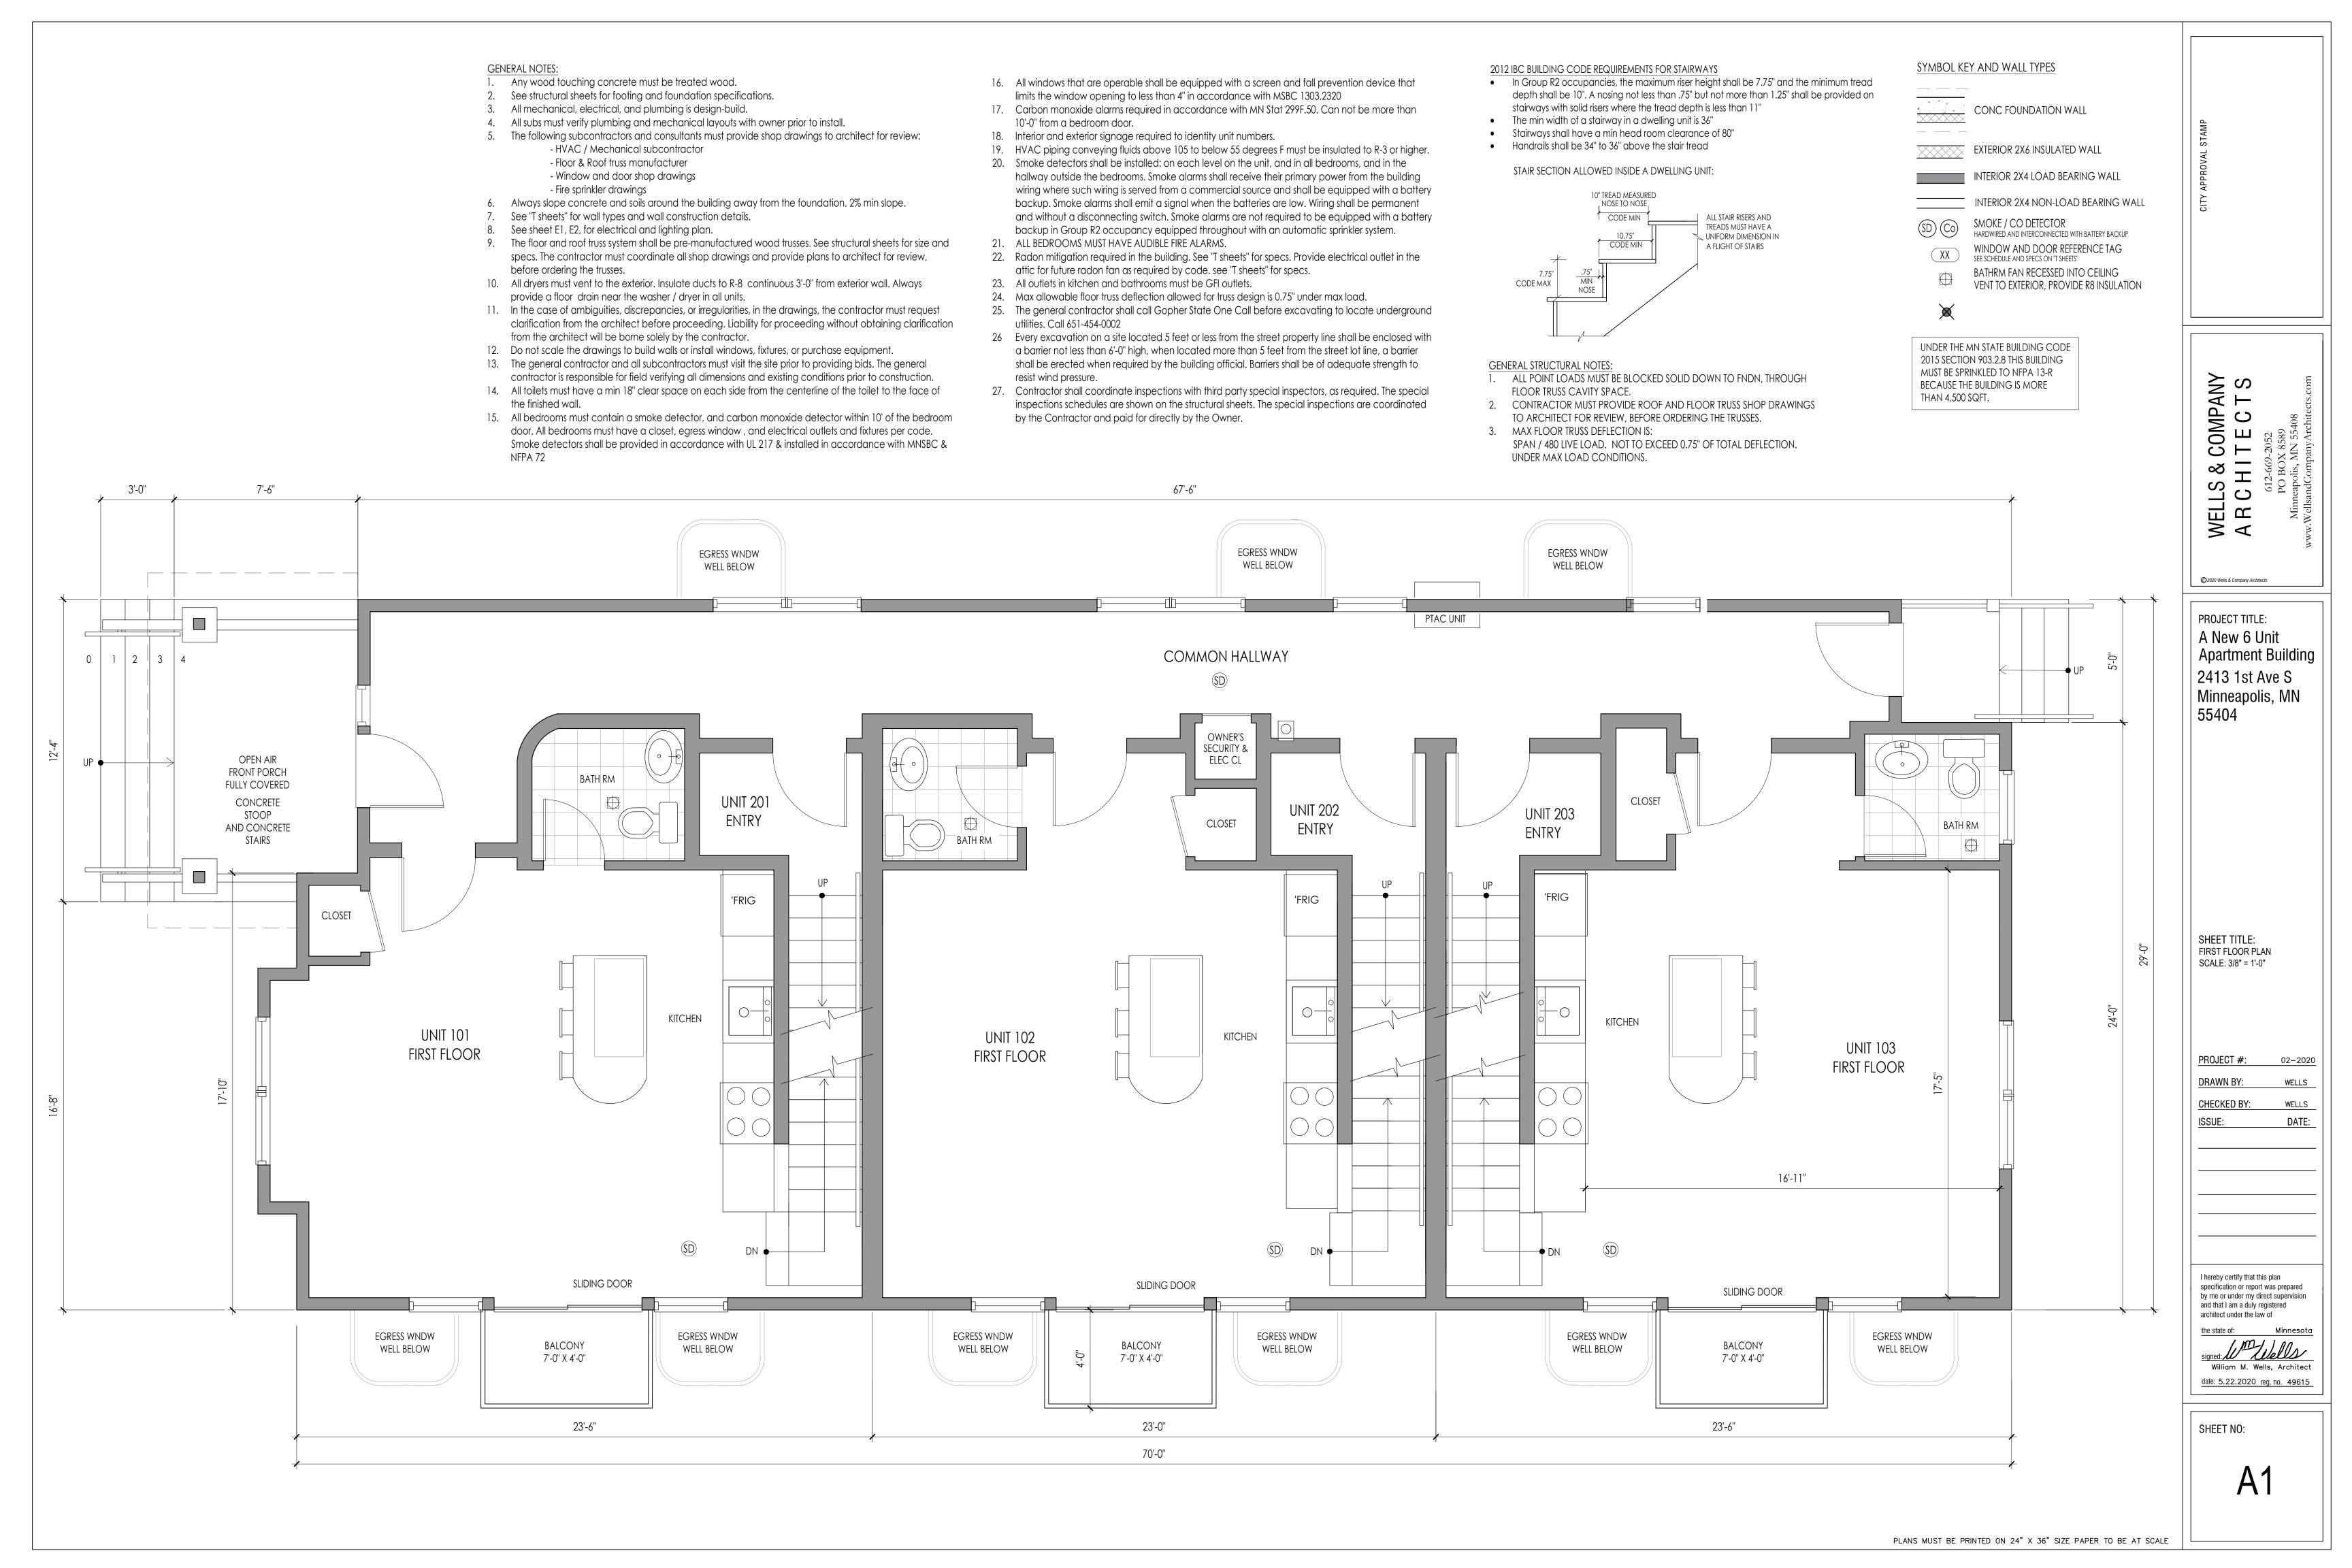

GENERAL NOTES:


- 1. Any wood touching concrete must be treated wood.
- 2. See structural sheets for footing and foundation specifications.
- 3. All mechanical, electrical, and plumbing is design-build.
- 4. All subs must verify plumbing and mechanical layouts with owner prior to install.
 5. The following subcontractors and consultants must provide shop drawings to architect for review:
 - following subcontractors and consultants must provide shop a - HVAC / Mechanical subcontractor
 - Floor & Roof truss manufacturer
 Window and door shop drawings
 - Fire sprinkler drawings
- 6. Always slope concrete and soils around the building away from the foundation. 2% min slope.
- 7. See "T sheets" for wall types and wall construction details.
- 8. See sheet E1, E2, for electrical and lighting plan.
 9. The floor and roof truss system shall be pre-manufactured wood trusses. See structural sheets for size and specs. The contractor must coordinate all shop drawings and provide plans to architect for review, before ordering the trusses.
- 10. All dryers must vent to the exterior. Insulate ducts to R-8 continuous 3'-0" from exterior wall. Always provide a floor drain near the washer / dryer in all units.
- 11. In the case of ambiguities, discrepancies, or irregularities, in the drawings, the contractor must request clarification from the architect before proceeding. Liability for proceeding without obtaining clarification from the architect will be borne solely by the contractor.
- 12. Do not scale the drawings to build walls or install windows, fixtures, or purchase equipment.
- 13. The general contractor and all subcontractors must visit the site prior to providing bids. The general contractor is responsible for field verifying all dimensions and existing conditions prior to construction.
- 14. All toilets must have a min 18" clear space on each side from the centerline of the toilet to the face of the finished wall.
- 15. All bedrooms must contain a smoke detector, and carbon monoxide detector within 10' of the bedroom door. All bedrooms must have a closet, egress window, and electrical outlets and fixtures per code. Smoke detectors shall be provided in accordance with UL 217 & installed in accordance with MNSBC & NFPA 72

- 16. All windows that are operable shall be equipped with a screen and fall prevention device that limits the window opening to less than 4" in accordance with MSBC 1303.2320
- 17. Carbon monoxide alarms required in accordance with MN Stat 299F.50. Can not be more than 10'-0" from a bedroom door.
- 18. Interior and exterior signage required to identity unit numbers.
- 19. HVAC piping conveying fluids above 105 to below 55 degrees F must be insulated to R-3 or higher.
- 20. Smoke detectors shall be installed: on each level on the unit, and in all bedrooms, and in the hallway outside the bedrooms. Smoke alarms shall receive their primary power from the building wiring where such wiring is served from a commercial source and shall be equipped with a battery backup. Smoke alarms shall emit a signal when the batteries are low. Wiring shall be permanent and without a disconnecting switch. Smoke alarms are not required to be equipped with a battery backup in Group R2 occupancy equipped throughout with an automatic sprinkler system.
- 21. ALL BEDROOMS MUST HAVE AUDIBLE FIRE ALARMS.
- 22. Radon mitigation required in the building. See "T sheets" for specs. Provide electrical outlet in the attic for future radon fan as required by code. see "T sheets" for specs.
- 23. All outlets in kitchen and bathrooms must be GFI outlets.
- 23. All others in kitcher and barricoms most be of rothers.24. Max allowable floor truss deflection allowed for truss design is 0.75" under max load.
- 25. The general contractor shall call Gopher State One Call before excavating to locate underground utilities. Call 651-454-0002
- Every excavation on a site located 5 feet or less from the street property line shall be enclosed with a barrier not less than 6'-0" high, when located more than 5 feet from the street lot line, a barrier shall be erected when required by the building official. Barriers shall be of adequate strength to resist wind pressure.
- 27. Contractor shall coordinate inspections with third party special inspectors, as required. The special inspections schedules are shown on the structural sheets. The special inspections are coordinated by the Contractor and paid for directly by the Owner.

2012 IBC BUILDING CODE REQUIREMENTS FOR STAIRWAYS

- In Group R2 occupancies, the maximum riser height shall be 7.75" and the minimum tread depth shall be 10". A nosing not less than .75" but not more than 1.25" shall be provided on stairways with solid risers where the tread depth is less than 11"
- The min width of a stairway in a dwelling unit is 36"
- Stairways shall have a min head room clearance of 80"
- Handrails shall be 34" to 36" above the stair tread

STAIR SECTION ALLOWED INSIDE A DWELLING UNIT:

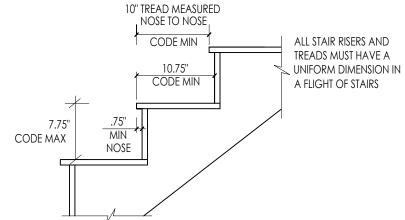

GENERAL STRUCTURAL NOTES:

ALL POINT LOADS MUST BE BLOCKED SOLID DOWN TO FNDN, THROUGH
FLOOR TRUSS CAVITY SPACE.

- 2. CONTRACTOR MUST PROVIDE ROOF AND FLOOR TRUSS SHOP DRAWINGS TO ARCHITECT FOR REVIEW, BEFORE ORDERING THE TRUSSES.
- 3. MAX FLOOR TRUSS DEFLECTION IS:

 SPAN / 480 LIVE LOAD. NOT TO EXCEED 0.75" OF TOTAL DEFLECTION.

 UNDER MAX LOAD CONDITIONS.

SYMBOL KEY AND WALL TYPES

CONC FOUNDATION WALL

EXTERIOR 2X6 INSULATED WALL

INTERIOR 2X4 LOAD BEARING WALL

___ INTERIOR 2X4 NON-LOAD BEARING WALL

SMOKE / CO DETECTOR
HARDWIRED AND INTERCONNECTED WITH BATTERY BACKUP

WINDOW AND DOOR REFERENCE TAG
SEE SCHEDULE AND SPECS ON "T SHEETS"





UNDER THE MN STATE BUILDING CODE 2015 SECTION 903.2.8 THIS BUILDING MUST BE SPRINKLED TO NFPA 13-R BECAUSE THE BUILDING IS MORE THAN 4,500 SQFT.



WELLS & COMPANY
A R C H I T E C T S
612-669-2052
PO BOX 8589
Minneapolis, MN 55408
www.WellsandCompanyArchitects.com

Apartment Building 2413 1st Ave S Minneapolis, MN 55404

PROJECT TITLE:

A New 6 Unit

SHEET TITLE: SECOND FLOOR PLAN SCALE: 3/8" = 1'-0"

PROJECT #: 02–2020

DRAWN BY: WELLS

CHECKED BY: WELLS

I hereby certify that this plan specification or report was prepared by me or under my direct supervision

by me or under my direct supervision and that I am a duly registered architect under the law of

the state of:

Minnesot

signed: Wells, Architect date: 5.22.2020 reg. no. 49615

SHEET NO:

A2


- Any wood touching concrete must be treated wood.
- 2. See structural sheets for footing and foundation specifications.
- 3. All mechanical, electrical, and plumbing is design-build.
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 - Floor & Roof truss manufacturer
 - Window and door shop drawings - Fire sprinkler drawings
- 6. Always slope concrete and soils around the building away from the foundation. 2% min slope.
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- 9. The floor and roof truss system shall be pre-manufactured wood trusses. See structural sheets for size and specs. The contractor must coordinate all shop drawings and provide plans to architect for review, before ordering the trusses.
- 10. All dryers must vent to the exterior. Insulate ducts to R-8 continuous 3'-0" from exterior wall. Always provide a floor drain near the washer / dryer in all units.
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- 26 Every excavation on a site located 5 feet or less from the street property line shall be enclosed with a barrier not less than 6'-0" high, when located more than 5 feet from the street lot line, a barrier shall be erected when required by the building official. Barriers shall be of adequate strength to resist wind pressure.
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STAIR SECTION ALLOWED INSIDE A DWELLING UNIT:



GENERAL STRUCTURAL NOTES:

ALL POINT LOADS MUST BE BLOCKED SOLID DOWN TO FNDN, THROUGH FLOOR TRUSS CAVITY SPACE.

- 2. CONTRACTOR MUST PROVIDE ROOF AND FLOOR TRUSS SHOP DRAWINGS TO ARCHITECT FOR REVIEW, BEFORE ORDERING THE TRUSSES.
- 3. MAX FLOOR TRUSS DEFLECTION IS: SPAN / 480 LIVE LOAD. NOT TO EXCEED 0.75" OF TOTAL DEFLECTION. UNDER MAX LOAD CONDITIONS.

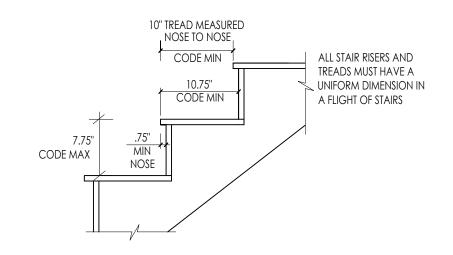
SYMBOL KEY AND WALL TYPES

CONC FOUNDATION WALL

EXTERIOR 2X6 INSULATED WALL INTERIOR 2X4 LOAD BEARING WALL

INTERIOR 2X4 NON-LOAD BEARING WALL

SMOKE / CO DETECTOR
HARDWIRED AND INTERCONNECTED WITH BATTERY BACKUP WINDOW AND DOOR REFERENCE TAG SEE SCHEDULE AND SPECS ON "T SHEETS" BATHRM FAN RECESSED INTO CEILING

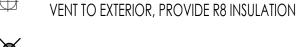

UNDER THE MN STATE BUILDING CODE 2015 SECTION 903.2.8 THIS BUILDING MUST BE SPRINKLED TO NFPA 13-R BECAUSE THE BUILDING IS MORE THAN 4,500 SQFT.

69'-4" WALL BELOW WALL BELOW **ROOF BELOW** 11'-0'' BEDROOM 3 BEDROOM 3 SD (SD) DR 4 16 15 14 13 12 11 **UNIT 203 UNIT 201** Co(SD) 3RD FLOOR 3RD FLOOR BATH RM BATH RM HW HW HVAC HVAC WALK IN CLOSET 11'-0'' BEDROOM 2 BEDROOM 2 BEDROOM 2 (SD) (SD) L____ WALL BELOW WALL BELOW 5'-0" 5'-0'' 12'-0" 6'-0'' 12'-0'' 5'-0'' 12'-0'' 6'-6" 6'-6'' 23'-6" 23'-0" 23'-6" 70'-0"

COMPANY T E C T S , ∡ ⊥ , LS C F WEL A R

PROJECT TITLE: A New 6 Unit Apartment Building 2413 1st Ave S Minneapolis, MN

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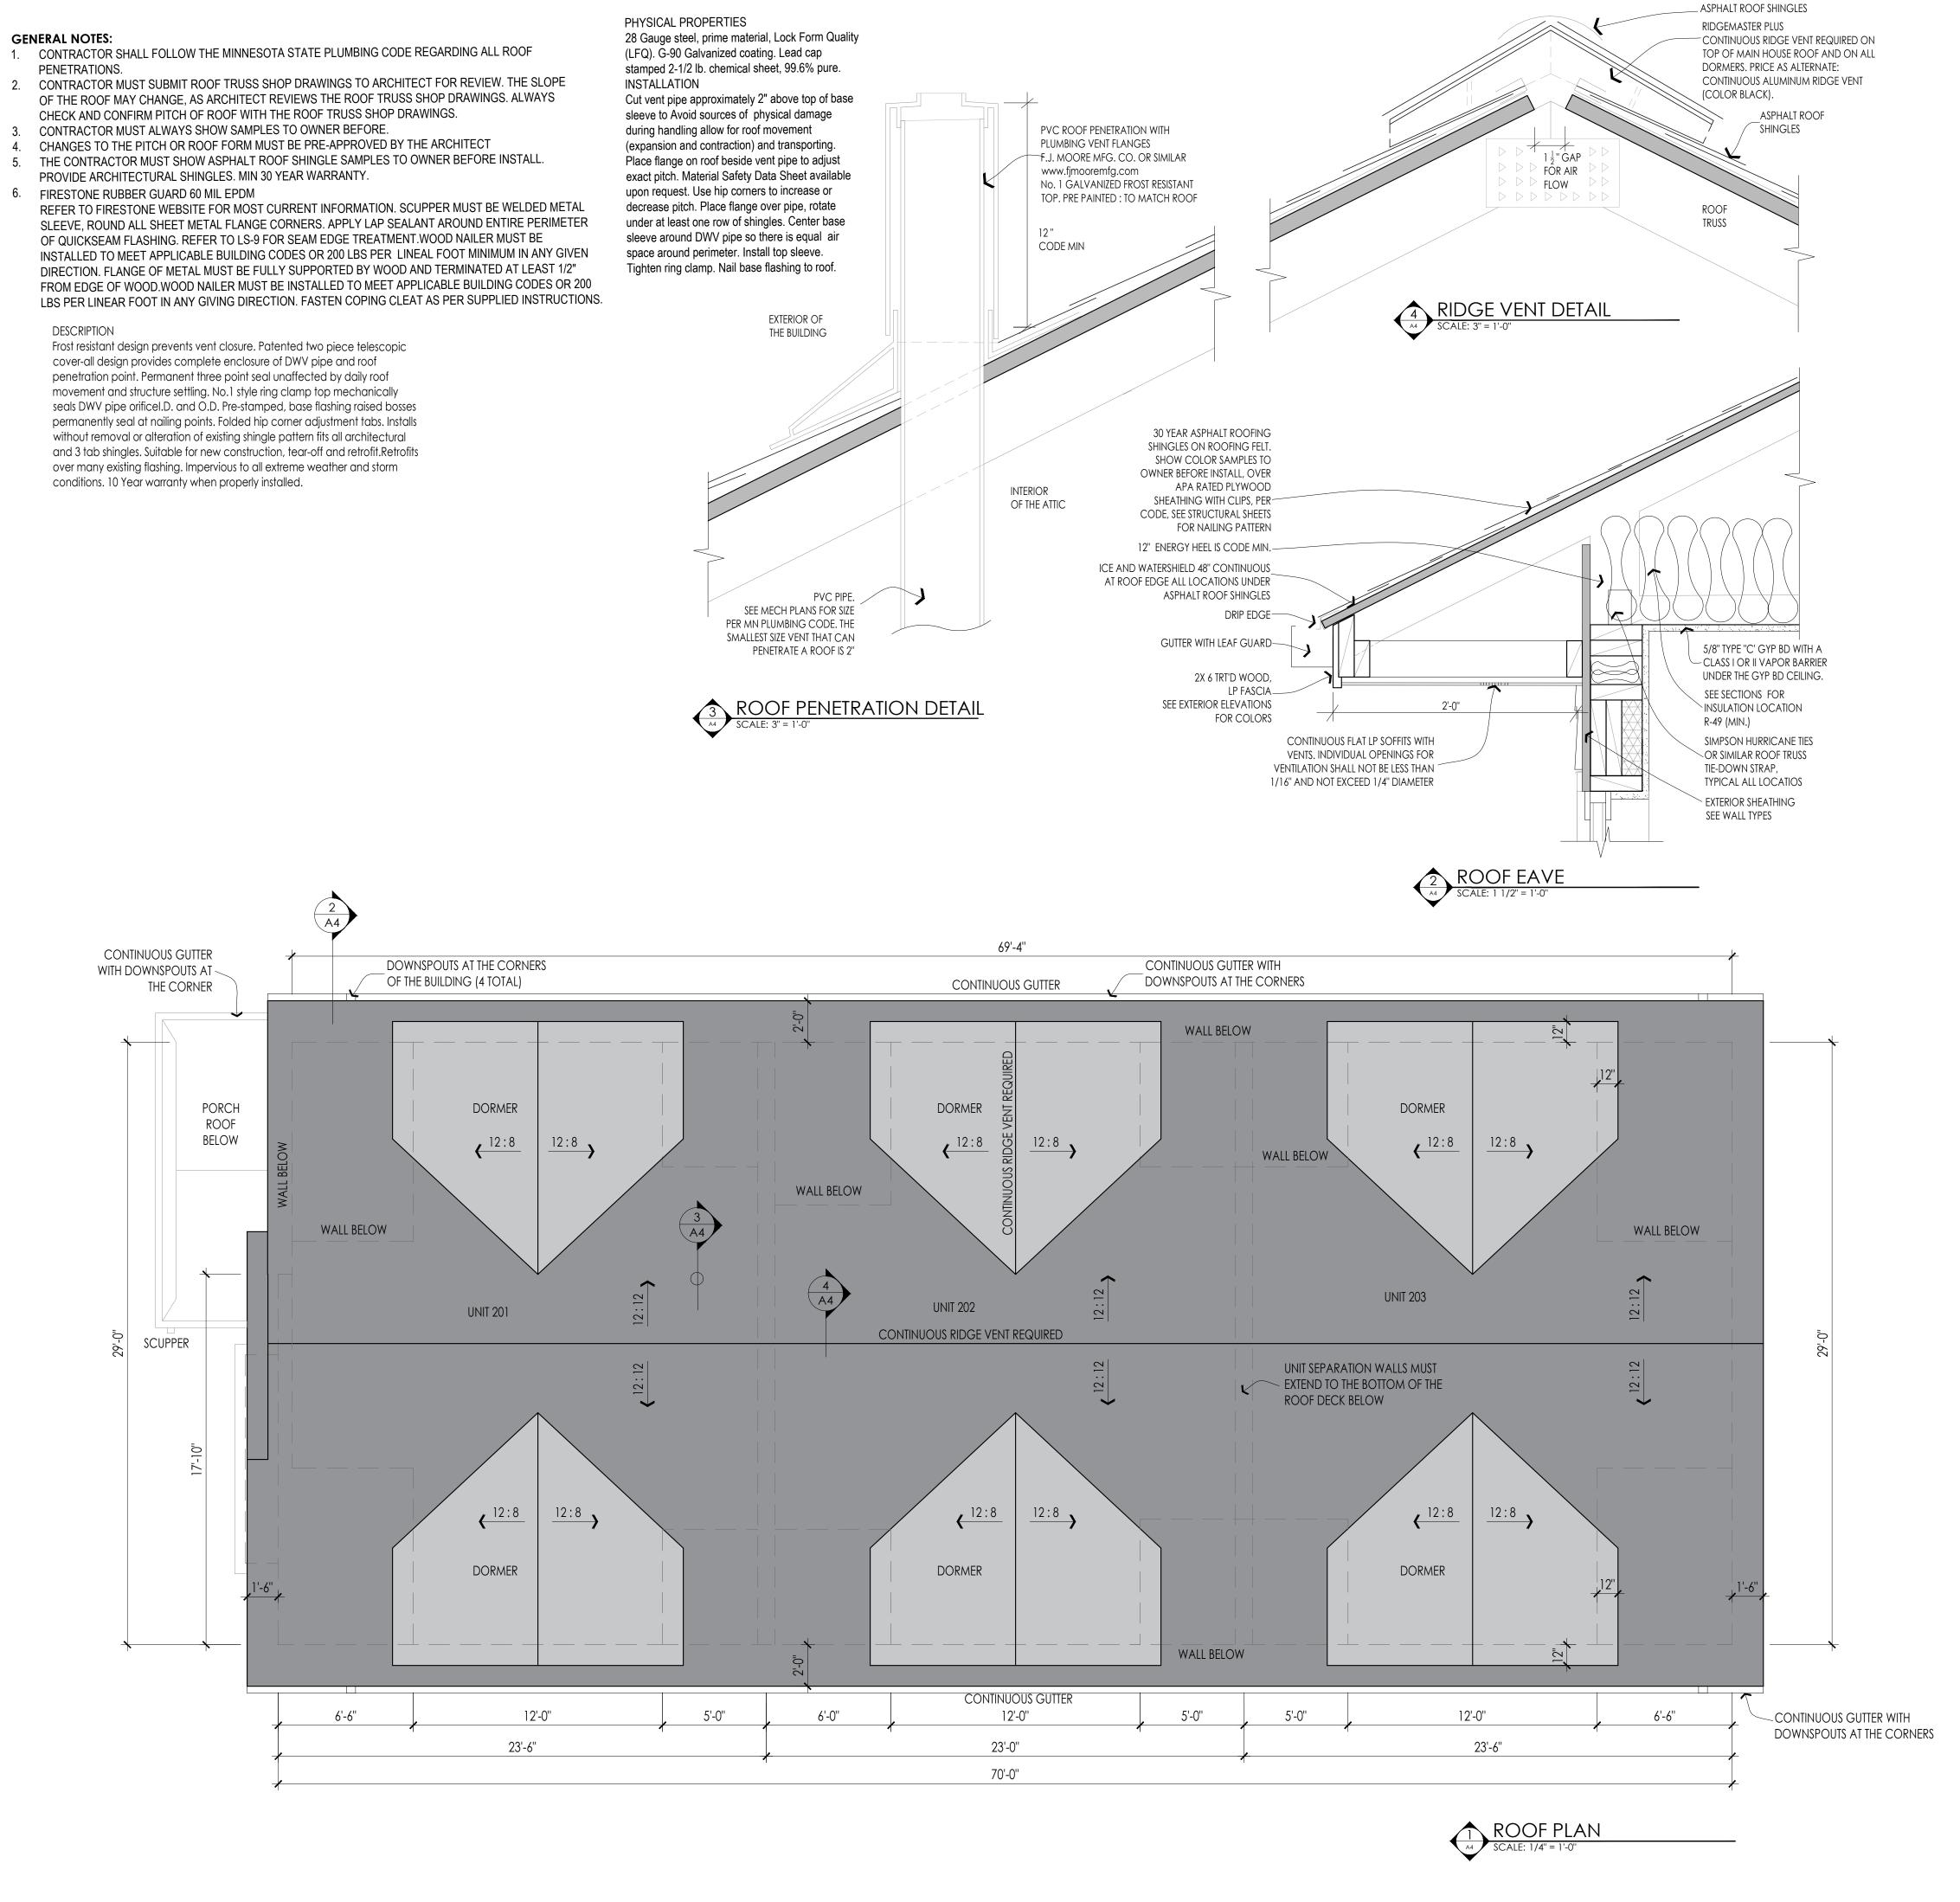
SHEET TITLE: THIRD FLOOR PLAN SCALE: 3/8" = 1'-0"

PROJECT #: DRAWN BY: CHECKED BY:

I hereby certify that this plan specification or report was prepared by me or under my direct supervision and that I am a duly registered architect under the law of

the state of: signed: WM Wells William M. Wells, Architect date: 5.22.2020 reg. no. 49615

SHEET NO:



CITY APPROVAL STAMP

WELLS & COMPANY
A R C H I T E C T S
612-669-2052
PO BOX 8589
Minneapolis, MN 55408
www.WellsandCompanyArchitects.com

A New 6 Unit
Apartment Building
2413 1st Ave S
Minneapolis, MN
55404

SHEET TITLE: ROOF PLAN AND ROOF DETAILS

PROJECT #: 02-2020

DRAWN BY: WELLS

CHECKED BY: WELLS

I hereby certify that this plan specification or report was prepared by me or under my direct supervision and that I am a duly registered architect under the law of the state of:

Minnesot

signed: William M. Wells, Architect date: 5.22.2020 reg. no. 49615

SHEET NO:

A4

I hereby certify that this plan specification or report was prepared

by me or under my direct supervision and that I am a duly registered architect under the law of

the state of:

Minnesoto

Signed:

William M. Wells, Architect

william M. Wells, Architect date: 5.22.2020 reg. no. 49615

SHEET NO:

A5

EXTERIOR MATERIALS, SPECIFICATIONS, AND GENERAL NOTES:

REF TAG SPECS

- CONTINUOUS RIDGE VENT REQUIRED ON PRIMARY ROOF AND ON ALL DORMERS. PROVIDE: RIDGEMASTER PLUS RIDGE VENT.
- COLOR: BLACK. OR SIMILAR SUPPLIER

 GAF TIMBERLINE NS ASPHALT ROOFING SHINGLE. COLOR: CHARCOAL. MUST BE INSTALLED OVER ROOF FELT PER CODE. SEE STRUCTURAL SHEETS FOR ROOF SHEATHING SPECIFICATIONS AND NAILING PATTERS.
- CONTINUOUS ALUMINUM GUTTER AND DOWNSPOUTS. PROVIDE CONCRETE SPLASH BLOCKS AT GRADE. THE DOWNSPOUTS MUST BE PAINTED TO MATCH THE SIDING COLOR, AND THE GUTTERS MUST BE PAINTED TO MATCH THE FASCIA TRIM BOARDS.
- PRE-FABRICATED ALUMINUM BALCONY. SUPPLIER: ENDURABLE BUILDING PRODUCTS. ALL RODS, KNIFE PLATE, BALCONY, FLASHING, AND HANRAILS TO BE CUSTOM PAINTED OFF-SITE AND PRE-FINISHED TO MATCH THE COLOR OF THE TRIM AROUND THE WINDOWS. CONTACT ARCHITECT FOR COLOR
- COVER FASCIA WITH LP STRAND COMPOSITE TREATED WOOD CEDAR TRIM. 440 SERIES CEDAR WOOD GRAIN TRIM. 7.21" WIDE X 0.625" THICK. SOFFITS SHALL BE LP SOFFIT STRAND PANEL SERIES. FULLY VENTED. 0.53" THICK. SEE SOFFIT AND FASCIA DETAIL ON SHEET A4
- LP CEDAR TRIM. COMPOSITE TREATED WOOD CEDAR TEXTURE TRIM. 540 SERIES CEDAR: 9.21" WIDE X 0.91" THICK, MUST BE INSTALLED OVER CONTINUOUS TYVEK WEATHER RESISTANCE BARRIER ,CONTACT ARCHITECT FOR COLOR, FOR PRICING ASSUME SITE PAINTED
- LP CEDAR TRIM. COMPOSITE TREATED WOOD CEDAR TEXTURE TRIM 540 SERIES CEDAR: 7.21" WIDE X 0.91" THICK, MUST BE INSTALLED OVER CONTINUOUS TYVEK WEATHER RESISTANCE BARRIER CONTACT ARCHITECT FOR COLOR, FOR PRICING ASSUME SITE PAINTED
- 8 LP CEDAR TRIM. COMPOSITE TREATED WOOD CEDAR TEXTURE TRIM 540 SERIES CEDAR: 3.5" WIDE X 0.91" THICK, MUST BE INSTALLED OVER CONTINUOUS TYVEK WEATHER RESISTANCE BARRIER CONTACT ARCHITECT FOR COLOR, FOR PRICING ASSUME SITE PAINTED
- P CEDAR TEXTURE LAP SIDING. MUST BE STRAND COMPOSITE TREATED WOOD SIDING, WITH SELF ALIGNING SMART LOCK OPTION. 76 SERIES. DIMENSION: 7.84" X .375" THICK INSTALLED IN 16'-0" LENGTHS STAGGERED JOINTS CAULKED. CONTACT ARCHITECT FOR COLOR, FOR PRICING ASSUME SITE PAINTED
 - STONE VENEER. CULTURED LIMESTONE. COLOR: SUEDE https://www.culturedstone.com/products/limestone#suede

EXTERIOR MATERIAL PERCENTAGES

EXTERIOR MATERIAL PERCENTAGES







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55404

I hereby certify that this plan specification or report was prepared by me or under my direct supervision and that I am a duly registered

architect under the law of

the state of:

Minnesoto

signed:

William M. Wells, Architect

date: 5.22.2020 reg. no. 49615

SHEET NO:

A6

EXTERIOR MATERIALS, SPECIFICATIONS, AND GENERAL NOTES:

REF TAG SPECS

- CONTINUOUS RIDGE VENT REQUIRED ON PRIMARY ROOF AND ON ALL DORMERS. PROVIDE: RIDGEMASTER PLUS RIDGE VENT. COLOR: BLACK. OR SIMILAR SUPPLIER
- GAF TIMBERLINE NS ASPHALT ROOFING SHINGLE. COLOR: CHARCOAL. MUST BE INSTALLED OVER ROOF FELT PER CODE. SEE STRUCTURAL SHEETS FOR ROOF SHEATHING SPECIFICATIONS AND NAILING PATTERS.
- CONTINUOUS ALUMINUM GUTTER AND DOWNSPOUTS. PROVIDE CONCRETE SPLASH BLOCKS AT GRADE. THE DOWNSPOUTS MUST BE PAINTED TO MATCH THE SIDING COLOR, AND THE GUTTERS MUST BE PAINTED TO MATCH THE FASCIA TRIM BOARDS.
- PRE-FABRICATED ALUMINUM BALCONY. SUPPLIER: ENDURABLE BUILDING PRODUCTS. ALL RODS, KNIFE PLATE, BALCONY, FLASHING, AND HANRAILS TO BE CUSTOM PAINTED OFF-SITE AND PRE-FINISHED TO MATCH THE COLOR OF THE TRIM AROUND THE WINDOWS. CONTACT ARCHITECT FOR COLOR
- COVER FASCIA WITH LP STRAND COMPOSITE TREATED WOOD CEDAR TRIM. 440 SERIES CEDAR WOOD GRAIN TRIM. 7.21" WIDE X 0.625" THICK. SOFFITS SHALL BE LP SOFFIT STRAND PANEL SERIES. FULLY VENTED. 0.53" THICK. SEE SOFFIT AND FASCIA DETAIL ON SHEET A4
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- B LP CEDAR TRIM. COMPOSITE TREATED WOOD CEDAR TEXTURE TRIM 540 SERIES CEDAR: 3.5" WIDE X 0.91" THICK, MUST BE INSTALLED OVER CONTINUOUS TYVEK WEATHER RESISTANCE BARRIER CONTACT ARCHITECT FOR COLOR, FOR PRICING ASSUME SITE PAINTED
- LP CEDAR TEXTURE LAP SIDING. MUST BE STRAND COMPOSITE TREATED WOOD SIDING, WITH SELF ALIGNING SMART LOCK OPTION. 76 SERIES.

 DIMENSION: 7.84" X .375" THICK INSTALLED IN 16'-0" LENGTHS STAGGERED JOINTS CAULKED. CONTACT ARCHITECT FOR COLOR, FOR PRICING ASSUME SITE PAINTED
- STONE VENEER. CULTURED LIMESTONE. COLOR: SUEDE https://www.culturedstone.com/products/limestone#suede



SIDE FACADE - NORTH FACING


SCALE: 1/4" = 1'-0"

CONC STOOP

FOOTINGS AND FOUNDATION BELOW GRADE

REAR FACADE - EAST FACING

SCALE: 1/4" = 1'-0"

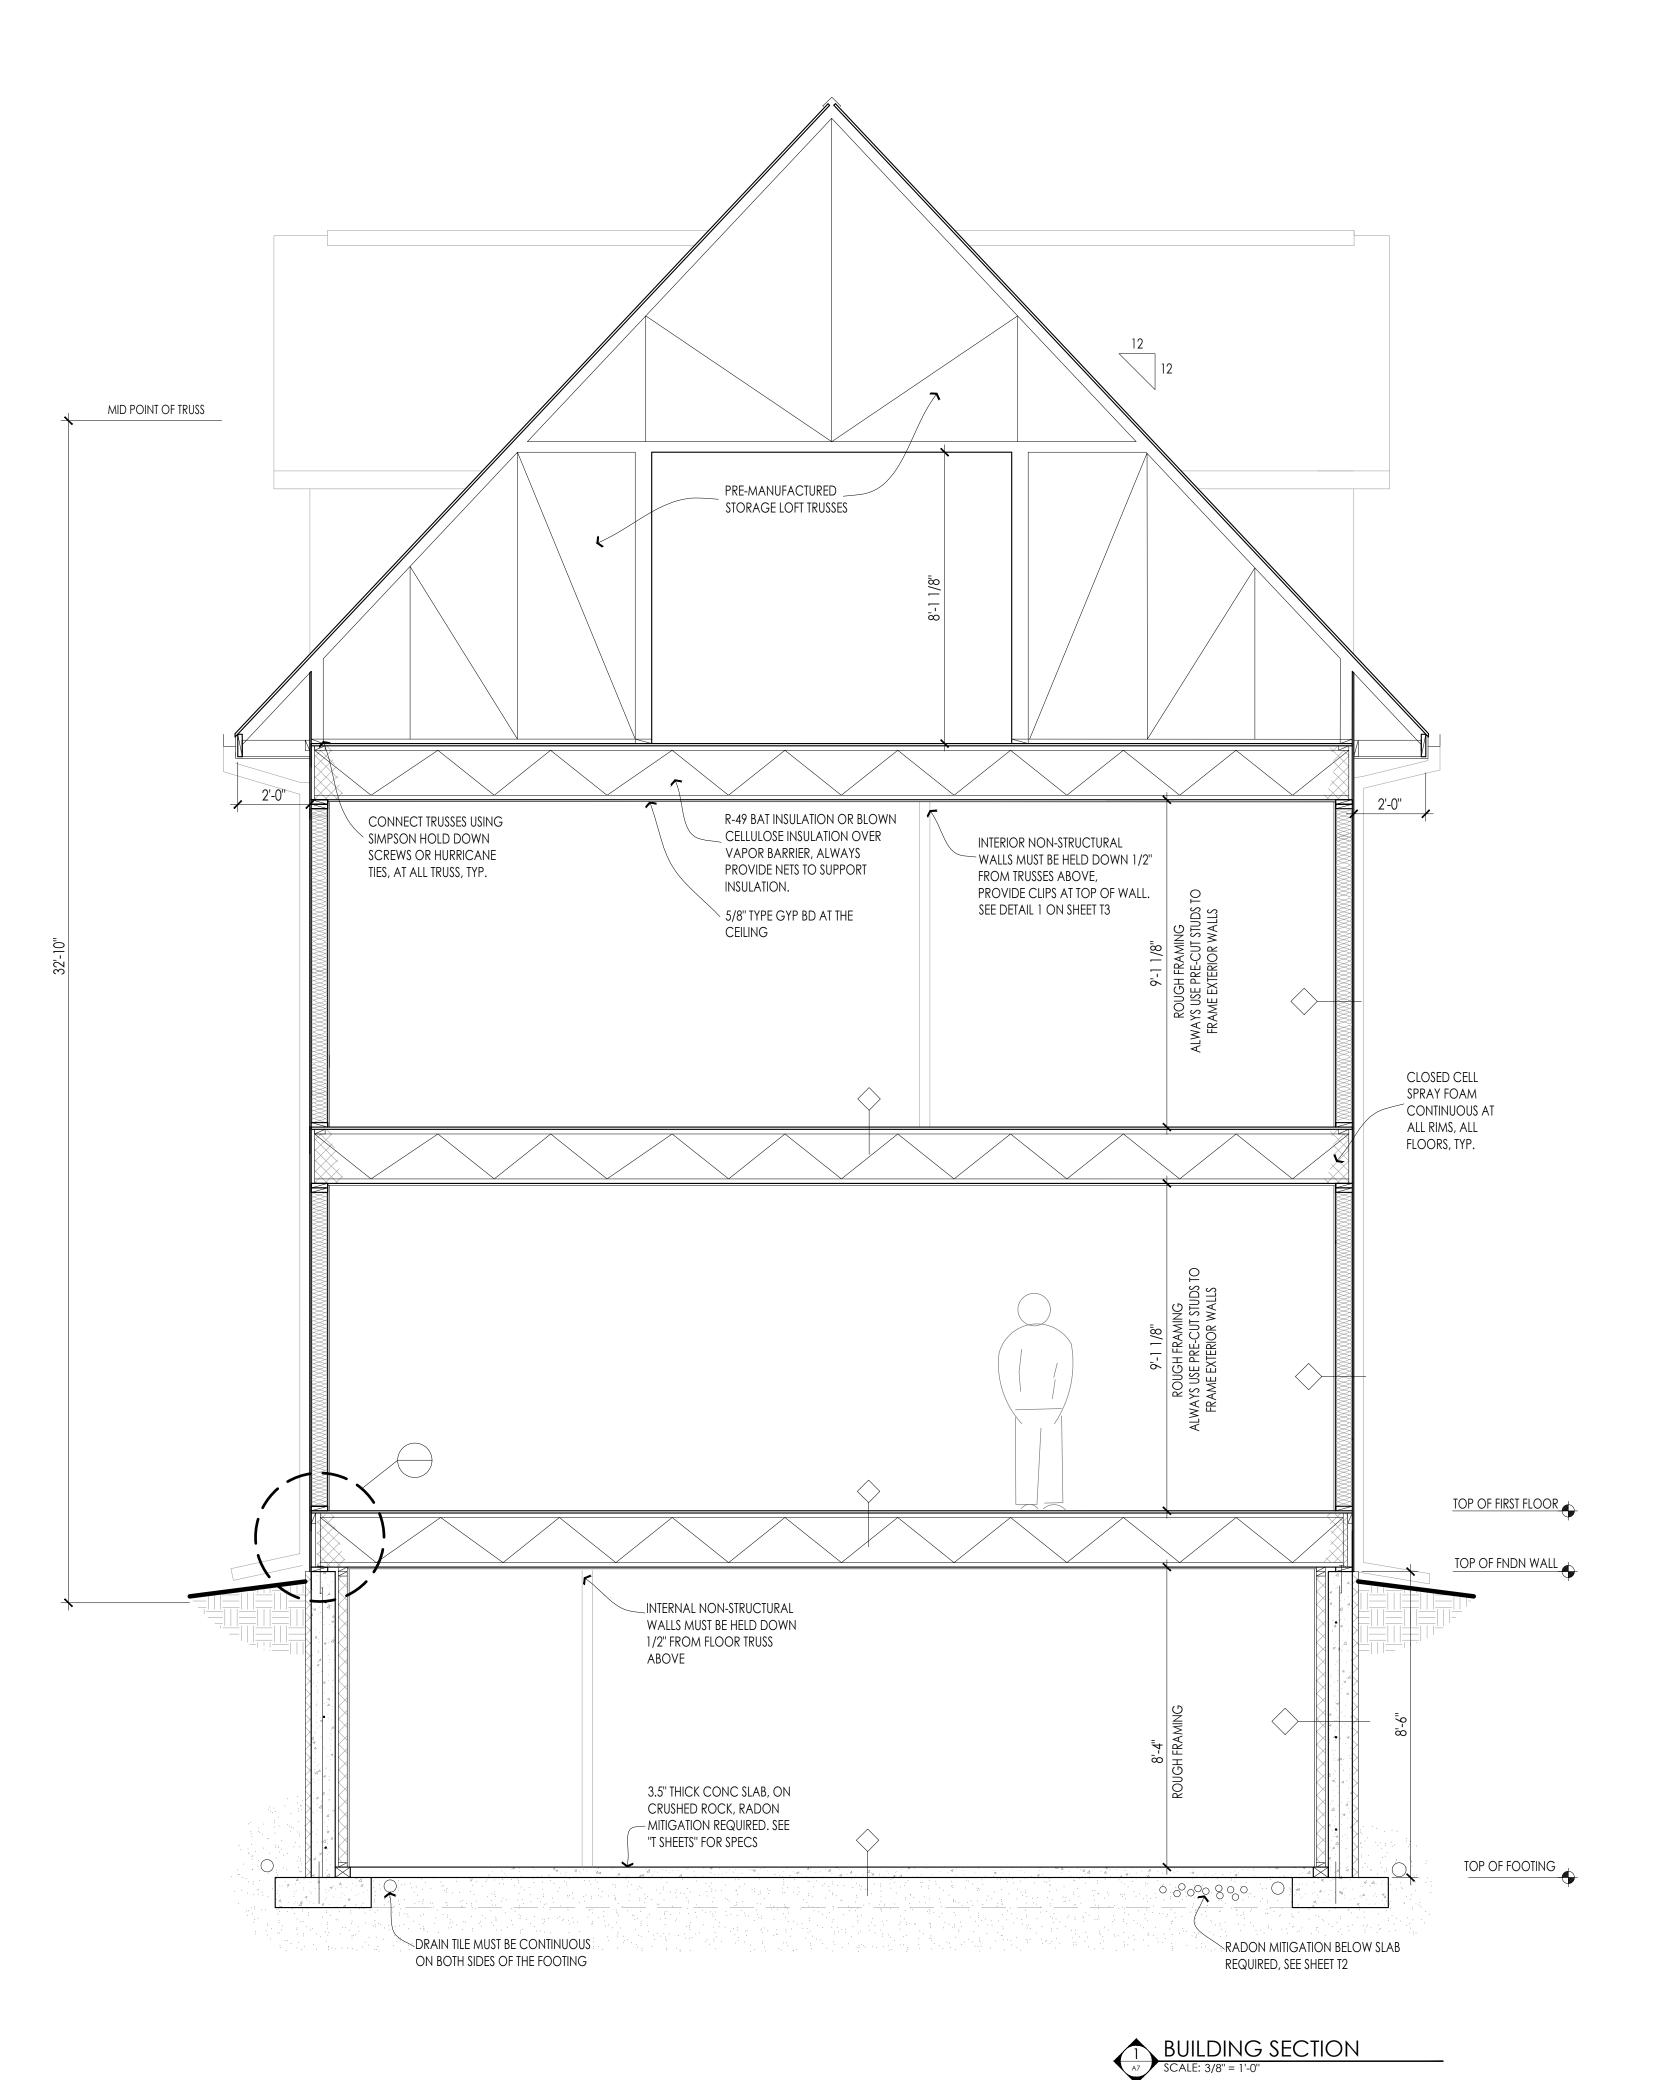

WELLS & COMPANY A R C H I T E C T S

PROJECT TITLE: A New 6 Unit Apartment Building 2413 1st Ave S Minneapolis, MN 55404

SHEET TITLE: BUILDING SECTION

PROJECT #: 02-2020 DRAWN BY: CHECKED BY:

I hereby certify that this plan specification or report was prepared by me or under my direct supervision and that I am a duly registered architect under the law of the state of: Minnesota signed: William M. Wells, Architect

date: 5.22.2020 reg. no. 49615

SHEET NO: