


# **RENDERING IMAGE**

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В

# LOCATION MAP



# **PROJECT TEAM**
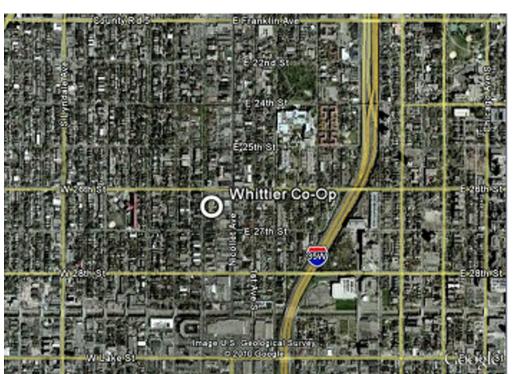
# CLIENT

COMMONBOND COMMUNITIES 1080 MONTREAL AVE ST. PAUL, MN 55116 651.291.1750

# CONTRACTOR

FRERICHS 3600 LABORE ROAD SUITE 8 VADNAIS HEIGHTS, MN 55110 PHONE: 651.787.0687

# CIVIL ENGINEER

LHB, INC. 701 WASHINGTON AVE N SUITE 200 MINNEAPOLIS, MN 55401 612.338.2029

# LANDSCAPE ARCHITECT

LHB, INC. 701 WASHINGTON AVE N SUITE 200 MINNEAPOLIS, MN 55401 612.338.2029

# ARCHITECT

LHB, INC. 701 WASHINGTON AVE N SUITE 200 MINNEAPOLIS, MN 55401 612.338.2029

1

STRUCTURAL ENGINEER

MATTSON MACDONALD YOUNG 901 NORTH 3RD ST SUITE 100 MINNEAPOLIS, MN 55401 612.827.7825

MECHANICAL ENGINEER

CAIN THOMAS ASSOCIATES 4215 WHITE BEAR PARKWAY SUITE 100 ST. PAUL, MN 55110 651.426.9549

CAIN THOMAS ASSOCIATES 4215 WHITE BEAR PARKWAY SUITE 100 ST. PAUL, MN 55110 651.426.9549

ELECTRICAL ENGINEER

# WHITTIER COMMUNITY HOUSING 26TH ST. W. AND BLAISDELL AVE. S. MINNEAPOLIS, MN

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STATE MAP	
	The
	PROJECT SITE CITY, STATE

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CITY OF MINNEAPOLIS STAMP



701 Washington Ave. N, Ste 200 | Minneapolis, MN 55401 | 612.338.2029


CLIENT: CommonBond Communities

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# **ALTA/NSPS LAND TITLE SURVEY FOR: CommonBond Communities**

# LEGAL DESCRIPTION:

Lots 16-26, inclusive, Rearrangement of Block 13, J.T. Blaisdell's Revised Addition to Minneapolis, Hennepin County, Minnesota (Abstract)

# **GENERAL SURVEY NOTES:**

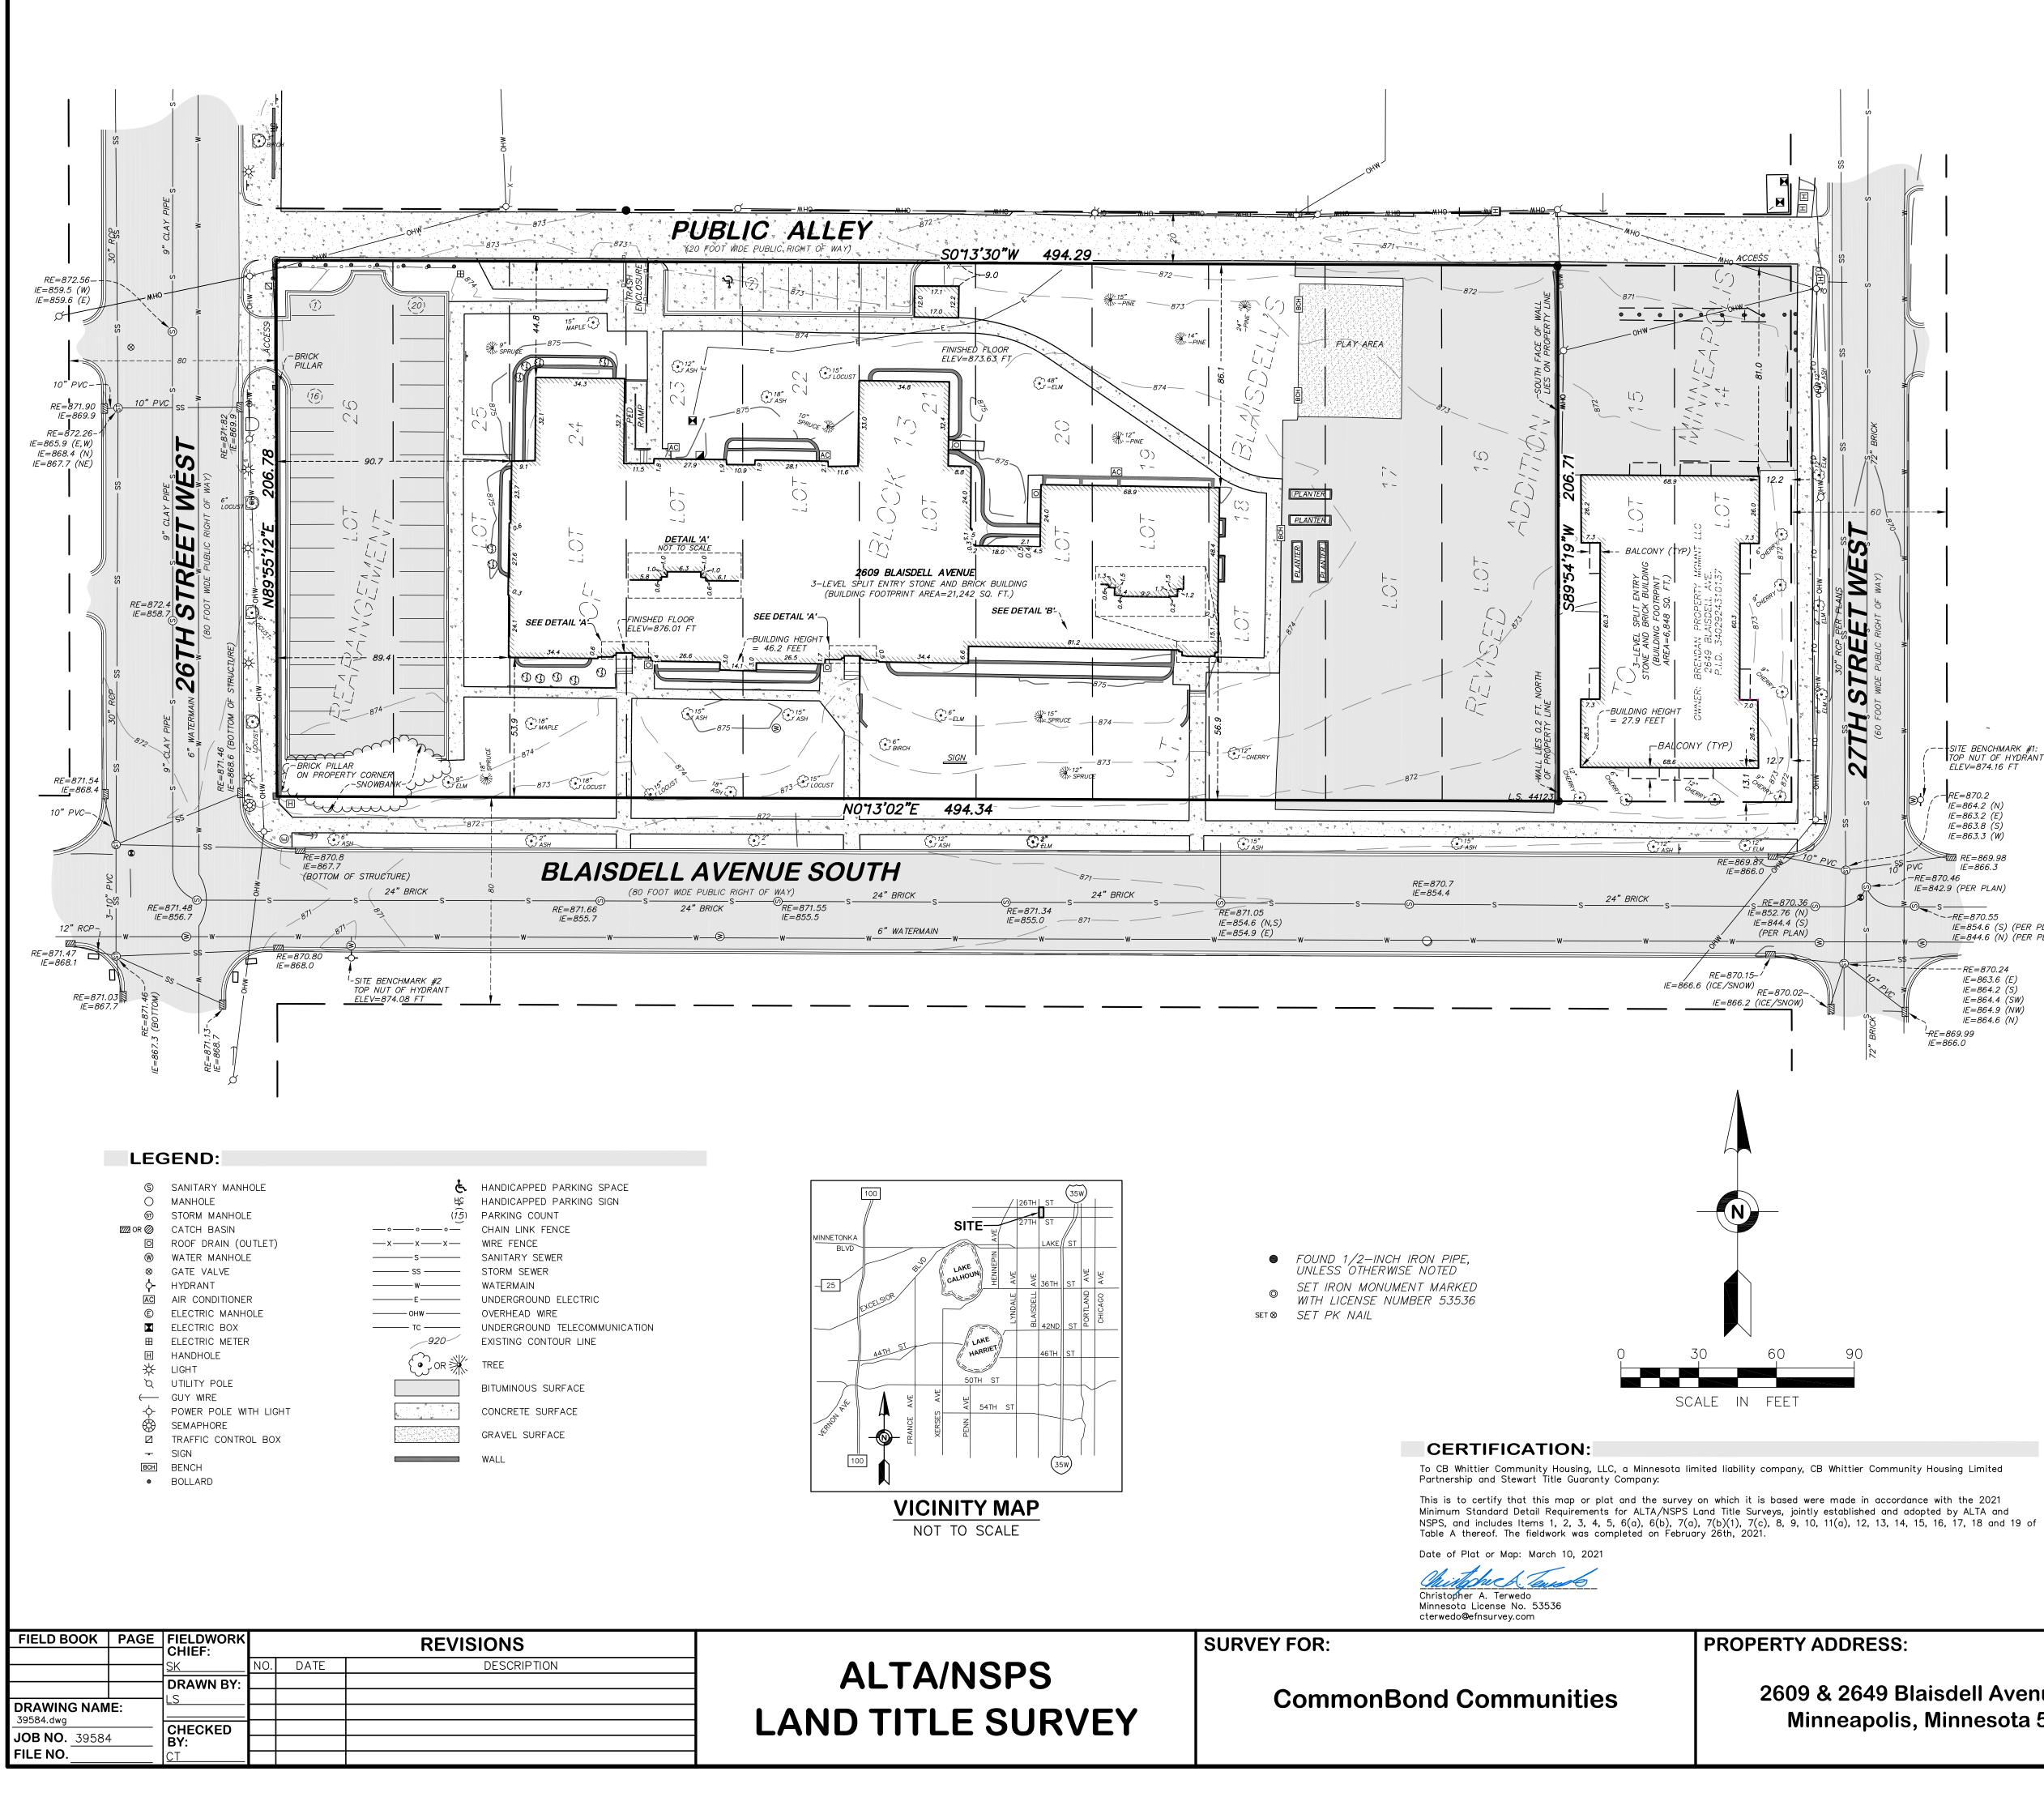- 1. The orientation of this bearing system is based on the Hennepin County coordinate grid (NAD 83-2011 Adj.).
- 2. The legal description and easement information used in the preparation of this survey is based on the Commitment for Title Insurance prepared by Stewart Title Guaranty Company, Commitment No. MSP154690-CO dated January 27, 2021.
- 3. The surveyed property has direct access to 26th Street West, a public right of way and the public alley.
- 4. This survey shows only those Improvements visible during the field survey, some structures and improvements covered by ice and snow, or underground may not be shown.

# **OPTIONAL TABLE A ITEMS:**

- 1. Monuments have been placed at all major corners of the surveyed property described hereon, unless already marked or referenced by existing monuments or witnesses in close proximity to the corner.
- 2. The address of the property described hereon is 2609 Blaisdell Avenue, Minneapolis, Minnesota 55408. 3. The property described hereon lies within AREA OF MINIMAL FLOOD HAZARD AREAS per Un-Printed Federal Insurance
- Rate Map No. 27053C0359F, dated November 4, 2016.
- 4. The total area of the property described hereon is 120,764 square feet or 2.7724 acres.
- 5. The contours depicted hereon are per elevation data collected while conducting the fieldwork. The contour interval is 1 Top nut of hydrant located in the southeast guadrant of 27th Street West and Blaisdell SITE BENCHMARK #1:
  - Avenue South. Elevation = 874.16 feet. (NGVD 29)
  - Top nut of hydrant located in the southwest quadrant of 26th Street West and Blaisdell SITE BENCHMARK #2: Avenue South. Elevation = 874.08 feet. (NGVD 29)
- 6a. No zoning report or letter was received from the insurer pursuant to Optional Table A Item 6(a), as set forth in the 2021 Minimum Standard Detail Requirements for ALTA/NSPS Land Title Surveys.
- 7a. Exterior building dimensions are depicted hereon.
- 7b1. The exterior building footprint areas at ground level is are depicted hereon.
- 7c. The measured building heights are depicted hereon.
- 8. Substantial features observed in the process of conducting the fieldwork are depicted hereon.
- 9. As of the date of this survey the property described hereon contains a total of 45 visibly striped parking spaces of which 44 are standard spaces, and 1 is a designated handicapped space.
- 11a. Existing utilities, services and underground structures shown hereon were located either physically, from existing records made available to us, by resident testimony, or by locations provided by Gopher State One Call, per Ticket No. 210370019 and 210370020. However, lacking excavation, the exact location of underground features cannot be accurately, completely and reliably depicted. Where additional or more detailed information is required, the client is advised that excavation may be necessary. Other utilities and services may be present and verification and location of all utilities and services should be obtained from the owners of the respective utilities prior to any design, planning or excavation.
- 12. As specified by the client, Governmental Agency survey-related requirements.
- 13. The names of adjoining owners according to current tax records are depicted hereon.
- 16. As of the date of this survey there is no observable evidence of current earth moving work, building construction or building additions on the property described hereon.
- 17. The surveyor is unaware of any completed or proposed changes in street right-of-way lines. As of the date of this survey there is no observable evidence of recent street or sidewalk construction or repairs that affect the property described hereon.
- 18. No plottable offsite easements or servitudes were disclosed in documents provided to the surveyor.
- 19. Professional Liability Insurance policy obtained by the surveyor to be in effect throughout the contract term.

# **GOPHER STATE ONE CALL NOTE:** List of utilities notified per Gopher State One Call Ticket Nos. 210370019 and 210370020

CITY OF MINNEAPOLIS WATER

CITY OF MINNEAPOLIS TRAFFIC

CITY OF MINNEAPOLIS SEWER

EXTENET SYSTEMS INC

COMCAST

CENTURYLINK

	- IE=870.24 IE=863.6 (E) IE=864.2 (S) IE=864.4 (SW) IE=864.9 (NW) IE=864.6 (N)
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866.0	ITEM 10:	Any and all me Rearrangement particulars.
		Said plat affec
	ITEM 11:	Grant of Easer Document No. Mississippi / T
		Said Easement hereon.
	ITEM 12:	Regulatory Agr Document No. liability compar of Minnesota.
		Said Agreemen
	ITEM 13:	Declaration of record Septem limited liability

1229 Tyler Street NE, Suite 100 Minneapolis, Minnesota 55413 PHONE: (612) 466-3300 FAX: (612) 466-3383 WWW.EFNSURVEY.COM COPYRIGHT © 2021 By EGAN, FIELD & NOWAK, INC

2609 & 2649 Blaisdell Avenue South Minneapolis, Minnesota 55408

Egan, Field & Nowak, Inc. land surveyors since 1872

METROPOLITAN COUNCIL US INTERNET CORP VERIZON WIRELESS XCEL ENERGY ZAYO BANDWIDTH

# EMS PER SCHEDULE B:

natters and interests which may affect the lands as more fully shown and recited on the t of Block 13, J.T. Blaisdells Révised Addition to Minneapolis. See instrument for full

- ects the surveyed property. No additional survey items to depict per plat. ement, dated October 7, 2010 and filed for record January 24, 2011 at 12:00 PM, recorded as 9617128, granted in favor of Comcast of Arkansas / Florida / Lousiana / Minnesota / Tennessee, Inc., its successors and assigns. See instrument for full particulars. affects the surveyed property. Said Easement is blanket in nature and is not depicted
- reement (Section 8), dated September 15, 2010, and filed for record September 16, 2010 as 9559740, executed by and between Whittier Community Housing, LLC, a Minnesota limited any, and Minnesota Housing Finance Agency, a public body corporate and politic of the State
- ent affects the surveyed property. No plottable items to depict.
- Covenants, Conditions, and Restrictions (Section 8), dated September 15, 2010, and filed for nber 16, 2010 as Document No. 9559742, by Whittier Community Housing, LLC, a Minnesota company.
- Said Declaration affects the surveyed property. No plottable items to depict. ITEM 14: Regulatory Agreement (ELHIF), dated September 15, 2010 and filed for record September 16, 2010 as Document No. 9559748, by and between Whittier Community Housing, LLC, a Minnesota limited liability company, and Minnesota Housing Finance Agency, a public body corporate and politic of the State of Minnesota.
- Said Agreement affects the surveyed property. No plottable items to depict. ITEM 15: Declaration of Covenants, Conditions, and Restrictions (ELHIF), dated September 15, 2010 and filed for record September 16, 2010 as Document No. 9559750, by Whittier Community Housing, LLC, a Minnesota limited liability company.
  - Said Declaration affects the surveyed property. No plottable items to depict.
- ITEM 16: Master Subordination Agreement, and Estoppel Certificate, dated September 15, 2010 and filed for record September 16, 2010 as Document No. 9559753, by and among Whittier Community Housing, LLC, a Minnesota limited liability company, the Minnesota Housing Finance Agency, a public body corporate and politic of the State of Minnesota, and the City of Minneapolis, a Minnesota municipal Corporation.
  - Said Agreement and Certificate affects the surveyed property. No plottable items to depict.

IE=866.3 -RE=870.46 IE=842.9 (PER PLAN) <u>≰</u>@\_\_\_s— ~-RE=870.55 IE=854.6 (S) (PER PLAN) IE=844.6 (N) (PER PLAN)

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IE=863.3 (W)

TOP NUT OF HYDRANT

# **GENERAL CONSTRUCTION NOTES**

- 1. ALL WORK SHALL BE DONE IN ACCORDANCE WITH THE PLANS AND REQUIREMENTS OF THE DETAILED SPECIFICATIONS.
- 2. OBTAIN ALL NECESSARY PERMITS PRIOR TO CONSTRUCTION. THE CONTRACTOR SHALL PAY ALL PERMIT AND OTHER ASSOCIATED FEES REQUIRED BY LOCAL, STATE AND FEDERAL AGENCIES.
- 3. ANY WORK LOCATED ON PUBLIC RIGHT-OF-WAY SHALL CONFORM TO ALL APPLICABLE REQUIREMENTS OF STANDARD SPECIFICATIONS FOR CONSTRUCTION OF THE CITY OF MINNEAPOLIS PUBLIC WORKS DEPARTMENT, ENGINEERING DIVISION, CURRENT EDITION.
- 4. MECHANICAL, ELECTRICAL, AND ARCHITECTURAL ELEMENTS SHOWN ON THE CIVIL PLANS ARE FOR INFORMATION ONLY. REFER TO THE APPROPRIATE DISCIPLINE DRAWINGS FOR DETAILS OF THESE ITEMS.
- 5. CONTRACTOR SHALL PROTECT FROM DAMAGE ALL EXISTING FEATURES DESIGNATED TO REMAIN. ANY FEATURES DAMAGED BY THE CONTRACTOR SHALL BE REPAIRED BY THE CONTRACTOR AT NO COST TO THE OWNER.
- 6. THE CONTRACTOR SHALL DETERMINE THE EXACT LOCATION OF ALL EXISTING UTILITIES PRIOR TO COMMENCING WORK, AND AGREES TO BE FULLY RESPONSIBLE FOR ANY AND ALL UNDERGROUND UTILITIES. UTILIZE THE ONE CALL EXCAVATION NOTICE SYSTEM OF "GOPHER ONE CALL" CALL 1-800-252-1166.
- 7. THE CONTRACTOR IS RESPONSIBLE FOR ALL CONSTRUCTION STAKING, SEE SPECIFICATIONS FOR REQUIREMENTS.
- 8. USE TEMPORARY CONSTRUCTION FENCING OR BARRIERS TO SECURE THE BUILDING SITE FOR PROTECTION OF PERSONS AND PROPERTY AS REQUIRED.
- 9. CONTRACTOR SHALL PROTECT FROM DAMAGE ALL EXISTING PAVEMENTS DESIGNATED TO REMAIN. ANY PAVEMENTS DAMAGED BY THE CONTRACTOR SHALL BE REPAIRED BY THE CONTRACTOR AT NO COST TO THE OWNER.
- 10. GRADES SHOWN ARE FINISH SURFACE ELEVATIONS. THE CONTRACTOR SHALL MAKE APPROPRIATE DEDUCTIONS FOR VARYING SURFACES TO DETERMINE SUBGRADE ELEVATIONS.
- 11. ALL EXISTING AND PROPOSED STRUCTURE ACCESS COVERS SHALL BE ADJUSTED TO FINISHED GRADE BY THE CONTRACTOR. 12. ALL AREAS DISTURBED SHALL BE RESTORED WITH TOPSOIL AND SEED UNLESS NOTED OTHERWISE. REFERENCE THE
- PLANTING PLAN AND SPECIFICATIONS FOR REQUIREMENTS.
- 13. ALL BITUMINOUS AND CONCRETE REMOVAL LIMITS SHALL BE SAW CUT TO A NEAT LINE PRIOR TO PLACEMENT OF ANY NEW MATERIAL AGAINST EXISTING EDGES.
- 14. ALL STREET SIGNAGE WITHIN THE RIGHT-OF-WAY REMOVED FOR CONSTRUCTION SHALL BE REPLACED AT THE END OF THE PROJECT CONSTRUCTION.
- 15. EXISTING SITE INFORMATION WAS TAKEN FROM A SURVEY PROVIDED BY EGAN, FIELD & NOWAK, INC., MINNEAPOLIS, MN, DATED MARCH 10, 2021. ACTUAL FIELD CONDITIONS MAY VARY. VERIFY ALL FIELD CONDITIONS INCLUDING LOCATION OF UNDERGROUND UTILITIES PRIOR TO CONSTRUCTION. NOTIFY THE OWNER AND ARCHITECT OF ANY DISCREPANCIES AFFECTING THE SCOPE OF THIS CONTRACT.
- 16. ALL HORIZONTAL AND VERTICAL INFORMATION IS BASED ON THE TOPOGRAPHIC SURVEY AND BOUNDARY SURVEY PREPARED BY EGAN, FIELD & NOWAK, INC. SEE SURVEY FOR BENCHMARK INFORMATION.
- 17. A GEOTECHNICAL REPORT WAS PREPARED BY INTERTEK-PSI, EAGAN, MN DATED MARCH 11, 2021.

# **CITY OF MINNEAPOLIS CONSTRUCTION NOTES**

- 1. THE CONTRACTOR, PROPERTY OWNER, OR RESPONSIBLE PARTY SHALL CONTACT MINNEAPOLIS PUBLIC WORKS SURFACE WATERS AND SEWERS 48 HOURS PRIOR TO ANY EXCAVATION OR CONSTRUCTION RELATED TO OR IN THE LOCATION OF THE PROPOSED STORMWATER MANAGEMENT BMP (CONTACT PAUL CHELLSEN AT 612.673.2406 OR paul.chellsen@minneapolismn.gov).
- 2. UPON THE PROJECT'S COMPLETION, THE PROPERTY OWNER IS RESPONSIBLE FOR PROVIDING THE DEPARTMENT OF PUBLIC WORKS A FINAL STORMWATER MANAGEMENT REPORT INCLUDING RECORD DRAWINGS. THIS REPORT WILL SERVE AS A MEANS OF VERIFICATION THAT THE INTENT OF THE APPROVED STORMWATER MANAGEMENT DESIGN HAS BEEN MET. THIS FINAL REPORT SHALL SUBSTANTIATE ALL ASPECTS OF THE ORIGINAL DESIGN HAVE BEEN ADEQUATELY PROVIDED FOR BY THE CONSTRUCTION OF THE PROJECT.
- 3. AN OBSTRUCTION PERMIT IS REQUIRED FOR ANY WORK IN THE PUBLIC RIGHT-OF-WAY (CONTACT SCOTT KRAMER AT 612.673.2383 REGARDING DETAILS OF SIDEWALK AND LANE CLOSURES). A PERMIT CAN BE OBTAINED AT www.minneapolis.mn.roway.net.
- 4. CONTACT ALLAN KLUGMAN AT 612.673.2743 PRIOR TO CONSTRUCTION FOR THE TEMPORARY REMOVAL/RELOCATION OF ANY CITY OF MINNEAPOLIS LIGHTING OR TRAFFIC SIGNAL SYSTEM THAT MAY BE IN THE WAY OF CONSTRUCTION.
- 5. PAVEMENT MARKINGS THAT EXIST PRIOR TO THE START OF PROJECT MUST BE REPLACED IN KIND UNLESS OTHERWISE DIRECTED BY THE CITY OF MINNEAPOLIS TRAFFIC DIVISION. ALL COSTS ASSOCIATED WITH PAVEMENT MARKING REPLACEMENT SHALL BE AT THE PROJECT EXPENSE.
- 6. ALL COSTS FOR RELOCATION AND/OR REPAIR OF CITY TRAFFIC FACILITIES INCLUDING TRAFFIC SIGNAL SYSTEMS, STREET LIGHTING, TRAFFIC SIGNS, PARKING METERS, AND PAVEMENT MARKINGS SHALL BE AT THE PROJECT EXPENSE.
- 7. STREET LIGHTING INSTALLED AS PART OF THE PROJECT SHALL BE INSPECTED BY THE CITY. CONTRACTOR SHALL ARRANGE FOR INSPECTIONS WITH THE TRAFFIC DEPARTMENT (CONTACT DAVE PREHALL AT 612.673.5759). ANY LIGHT INSTALLATIONS NOT MEETING CITY SPECIFICATIONS WILL BE REQUIRED TO BE REINSTALLED AT OWNER EXPENSE.
- 8. CONTACT SHANE MORTON AT 612.673.5517 PRIOR TO CONSTRUCTION FOR THE REMOVAL OF ANY CITY OF MINNEAPOLIS RIGHT-OF-WAY SIGNS OR PAVEMENT MARKINGS THAT MAY BE IN THE WAY OF CONSTRUCTION.
- ANY EXISTING CONCRETE INFRASTRUCTURE IN THE PUBLIC RIGHT-OF-WAY, INCLUDING BUT NOT LIMITED TO PUBLIC SIDEWALKS, CURB AND GUTTER, AND ADA PEDESTRIAN RAMPS, THAT IS EITHER CURRENTLY DEFECTIVE OR THAT IS DAMAGED DURING THE TIME OF SITE REDEVELOPMENT, MUST BE REMOVED AND REPLACED AT THE TIME OF REDEVELOPMENT.
- 10. IF CONTAMINATED SOILS ARE ENCOUNTERED DURING SITE ACTIVITIES, STOP WORK IMMEDIATELY AND NOTIFY THE MN STATE DUTY OFFICER AT 651 649 5451
- 11. PERMITS AND APPROVALS ARE REQUIRED FROM ENVIRONMENTAL SERVICES FOR THE FOLLOWING ACTIVITIES: TEMPORARY STORAGE OF IMPACTED SOILS ON SITE PRIOR TO DISPOSAL OR REUSE; REUSE OF IMPACTED SOILS ON SITE; DEWATERING OR DISCHARGE OF ACCUMULATED STORMWATER OR GROUNDWATER, UNDERGROUND OR ABOVEGROUND TANK INSTALLATION OR REMOVAL; WELL CONSTRUCTION OR SEALING. CONTACT TOM FRAME AT 612.673.5807 FOR PERMIT APPLICATIONS AND APPROVALS.
- 12. NO CONSTRUCTION, DEMOLITION, OR COMMERCIAL POWER MAINTENANCE EQUIPMENT SHALL BE OPERATED WITHIN THE CITY BETWEEN THE HOURS OF 6:00PM AND 7:00AM ON WEEKDAYS OR DURING ANY HOURS ON SATURDAYS, SUNDAYS, AND STATE AND FEDERAL HOLIDAYS, EXCEPT UNDER PERMIT. CONTACT ENVIRONMENTAL SERVICES AT 612.673.3867 FOR PERMIT INFORMATION.

# **TRAFFIC CONTROL**

- DEVICES" (MUTCD).

# CITY OF MINNEAPOLIS EROSION CONTROL NOTES

- THE ROCK FROM BELOW.

- DEVICES.
- DEWATERING ACTIVITIES.

1. THE CONTRACTOR SHALL FURNISH AND MAINTAIN ALL NECESSARY BARRICADES, WARNING SIGNS, LIGHTS AND FLAGGERS AS PER THE CITY OF MINNEAPOLIS PUBLIC WORKS REQUIREMENTS. COST SHALL BE CONSIDERED INCIDENTAL TO THE PROJECT. BARRICADES SHALL CONFORM TO THE "MANUAL ON UNIFORM TRAFFIC CONTROL

2. THE CONTRACTOR SHALL OBTAIN ALL PERMITS FOR ALL WORK IN THE RIGHT OF WAY. THE CONTRACTOR IS RESPONSIBLE FOR TRAFFIC CONTROL WHILE WORKING WITHIN THE RIGHT OF WAY.

1. CONTRACTOR MUST CALL A CONSTRUCTION START 48 HOURS PRIOR TO ANY LAND DISTURBANCES 612-673-3867. FAILURE TO DO SO MAY RESULT IN FINES, THE REVOCATION OF PERMIT AND A STOP WORK ORDER BEING ISSUED.

2. INSTALL PERIMETER EROSION CONTROL AT THE LOCATIONS SHOWN ON THE PLANS PRIOR TO THE COMMENCEMENT OF ANY LAND DISTURBANCE OR CONSTRUCTION ACTIVITIES.

3. BEFORE BEGINNING CONSTRUCTION, INSTALL A TEMPORARY ROCK CONSTRUCTION ENTRANCE AT EACH POINT WHERE VEHICLES EXIT THE CONSTRUCTION SITE. USE 2 INCH OR GREATER DIAMETER ROCK IN A LAYER AT LEAST 6 INCHES THICK ACROSS THE ENTIRE WIDTH OF THE ENTRANCE. EXTEND THE ROCK ENTRANCE AT LEAST 50 FEET INTO THE CONSTRUCTION ZONE USING A GEO-TEXTILE FABRIC BENEATH THE AGGREGATE TO PREVENT MIGRATION OF SOIL INTO

4. REMOVE ALL SOILS AND SEDIMENTS TRACKED OR OTHERWISE DEPOSITED ONTO PUBLIC AND PRIVATE PAVEMENT AREAS. REMOVAL SHALL BE ON A DAILY BASIS WHEN TRACKING OCCURS AND MAY BE ORDERED BY MINNEAPOLIS INSPECTORS AT ANY TIME IF CONDITIONS WARRANT. SWEEPING SHALL BE MAINTAINED THROUGHOUT THE DURATION OF THE CONSTRUCTION AND DONE IN A MANNER TO PREVENT DUST BEING BLOWN TO ADJACENT PROPERTIES.

5. INSTALL INLET PROTECTION AT ALL PUBLIC AND PRIVATE CATCH BASIN INLETS, WHICH RECEIVE RUNOFF FROM THE DISTURBED AREAS. CONTRACTOR SHALL CLEAN, REMOVE SEDIMENT OR REPLACE STORM DRAIN INLET PROTECTION DEVICES ON A ROUTINE BASIS SUCH THAT THE DEVICES ARE FULLY FUNCTIONAL FOR THE NEXT RAIN EVENT. SEDIMENT DEPOSITED IN AND/OR PLUGGING DRAINAGE SYSTEMS IS THE RESPONSIBILITY OF THE CONTRACTOR. HAY BALES OR FILTER FABRIC WRAPPED GRATES ARE NOT ALLOWED FOR INLET PROTECTION.

6. LOCATE SOIL OR DIRT STOCKPILES NO LESS THAN 25 FEET FROM ANY PUBLIC OR PRIVATE ROADWAY OR DRAINAGE CHANNEL. IF REMAINING FOR MORE THAN SEVEN DAYS, STABILIZE THE STOCKPILES BY MULCHING, VEGETATIVE COVER, TARPS, OR OTHER MEANS. CONTROL EROSION FROM ALL STOCKPILES BY PLACING SILT BARRIERS AROUND THE PILES. TEMPORARY STOCKPILES LOCATED ON PAVED SURFACES MUST BE NO LESS THAN TWO FEET FROM THE DRAINAGE/GUTTER LINE AND SHALL BE COVERED IF LEFT MORE THAN 24 HOURS.

7. MAINTAIN ALL TEMPORARY EROSION AND SEDIMENT CONTROL DEVICES IN PLACE UNTIL THE CONTRIBUTING DRAINAGE AREA HAS BEEN STABILIZED. INSPECT TEMPORARY EROSION AND SEDIMENT CONTROL DEVICES ON A DAILY BASIS AND REPLACE DETERIORATED, DAMAGED, OR ROTTED EROSION CONTROL DEVICES IMMEDIATELY.

8. TEMPORARILY OR PERMANENTLY STABILIZE ALL CONSTRUCTION AREAS WHICH HAVE UNDERGONE FINAL GRADING, AND ALL AREAS IN WHICH GRADING OR SITE BUILDING CONSTRUCTION OPERATIONS ARE NOT ACTIVELY UNDERWAY AGAINST EROSION DUE TO RAIN, WIND AND RUNNING WATER WITHIN 7-14 DAYS. USE SEED AND MULCH, EROSION CONTROL MATTING, AND/OR SODDING AND STAKING IN GREEN SPACE AREAS. REMOVE ALL TEMPORARY SYNTHETIC, STRUCTURAL, NON-BIODEGRADABLE EROSION AND SEDIMENT CONTROL DEVICES AFTER THE SITE HAS UNDERGONE FINAL STABILIZATION WITH PERMANENT VEGETATION ESTABLISHMENT. FINAL STABILIZATION FOR PURPOSES OF THIS REMOVAL IS 70% ESTABLISHED COVER OVER DENUDED AREA.

READY MIXED CONCRETE AND CONCRETE BATCH/MIX PLANTS ARE PROHIBITED WITHIN THE PUBLIC RIGHT OF WAY. ALL CONCRETE RELATED PRODUCTION, CLEANING AND MIXING ACTIVITIES SHALL BE DONE IN THE DESIGNATED CONCRETE MIXING/WASHOUT LOCATIONS AS SHOWN IN THE EROSION CONTROL PLAN. UNDER NO CIRCUMSTANCE MAY WASHOUT WATER DRAIN ONTO THE PUBLIC RIGHT OF WAY OR INTO ANY PUBLIC OR PRIVATE STORM DRAIN CONVEYANCE.

10. CHANGES TO APPROVED EROSION CONTROL PLAN MUST BE APPROVED BY THE EROSION CONTROL INSPECTOR PRIOR TO IMPLEMENTATION, CONTRACTOR TO PROVIDE INSTALLATION AND DETAILS FOR ALL PROPOSED ALTERNATE TYPE

11. IF DEWATERING OR PUMPING OF WATER IS NECESSARY, THE CONTRACTOR IS RESPONSIBLE FOR OBTAINING ANY NECESSARY PERMITS AND/OR APPROVALS PRIOR TO DISCHARGE OF ANY WATER FROM THE SITE. IF THE DISCHARGE FROM THE DEWATERING OR PUMPING PROCESS IS TURBID OR CONTAINS SEDIMENT LADEN WATER. IT MUST BE TREATED THROUGH THE USE OF SEDIMENT TRAPS, VEGETATIVE FILTER STRIPS, OR OTHER SEDIMENT REDUCING MEASURES SUCH THAT THE DISCHARGE IS NOT VISIBLY DIFFERENT FROM THE RECEIVING ADDITIONAL EROSION CONTROL MEASURES MAY BE REQUIRED AT THE DISCHARGE POINT TO PREVENT SCOUR EROSION. THE CONTRACTOR SHALL PROVIDE A DEWATERING/PUMPING PLAN TO THE EROSION CONTROL INSPECTOR PRIOR TO INITIATING

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# **GOVERNING SPECIFICATIONS**

THE STANDARD SUPPLEMENTAL SPECIFICATIONS FOR THE CONSTRUCTION OF PUBLIC INFRASTRUCTURE IN THE CITY OF MINNEAPOLIS, 2021 EDITION.

THE 2020 EDITION OF THE MINNESOTA DEPARTMENT OF TRANSPORTATION "STANDARD SPECIFICATIONS FOR CONSTRUCTION SHALL GOVERN, EXCEPT AS MODIFIED BY THE PROJECT SPECIFICATIONS. (AVAILABLE AT: http://www.dot.state.mn.us/tecsup)

ALL TRAFFIC CONTROL DEVICES AND SIGNING SHALL CONFORM TO THE MN MUTCD, INCLUDING THE MOST CURRENT FIELD MANUAL. (AVAILABLE AT: http://www.dot.state.mn.us/trafficeng)

	AGENCY STANDARDS
	MNDOT STANDARD PLATES REFERENCED IN SET
PLATE NO.	DESCRIPTION
S-297.250	PEDESTRIAN CURB RAMP DETAILS
	CITY OF MINNEAPOLIS STANDARD PLANS REFERENCED IN SET
ROAD-1000	B612 CURB AND GUTTER
ROAD-1001	B612 CURB AND GUTTER TIPOUT
ROAD-1003	B624 CURB AND GUTTER
ROAD-1009	REINFORCING AT CURB OUTLET
ROAD-1010	SAW CUT AT CURB AND GUTTER REMOVAL
ROAD-2000-R1	DRIVEWAY REFERENCE
ROAD-2001-R1	TYPICAL DRIVEWAY CONSTRUCTION
ROAD-2002	TYPICAL DRIVEWAY
ROAD-2003-R1	TYPICAL SIDEWALK AND DRIVEWAY CONSTRUCTION
ROAD-2004	GATES, MANHOLES, MONUMENTS, ETC. IN CONCRETE PAVEMENT
ROAD-3000	TYPICAL ALLEY SECTION
ROAD-3001-R1	TYPICAL CONCRETE PANEL LAYOUT FOR RESIDENTIAL ALLEY CORNERS
SEWR-1000-R1	TYPICAL MANHOLE CONSTRUCTION
SEWR-1009	CATCH BASIN INSTALLATION
SEWR-1011-R1	CONCRETE ADJUSTING RINGS (INSTALLATION DETAIL)
SEWR-1017	STANDARD CATCH BASIN CONSTRUCTION
SEWR-2000	MANHOLE COVER CITY LOGO
SEWR-2004	STANDARD PROFILE MANHOLE RING CASTING
SEWR-2006	CATCH BASIN CASTING
SEWR-2007	CURB BOX CASTING
SEWR-2008	CATCH BASIN GRATE TYPE "V"
SEWR-8001	SEDIMENT CONTROL-SILT FENCE
SEWR-8002	SEDIMENT CONTROL-ROCK ENTRANCE
SEWR-8003	INLET PROTECTION TYPE A & C
SEWR-8006	DEWATERING-TRASH PUMP
SEWR-8007	EROSION CONTROL NOTES
WATER-1000	HYDRANT BRANCH AND VALVE BOX
WATER-2004	PIPE BEDDING
WATER-2007	VALVE BOX
WATER-3000	STANDARD MANHOLE


CITY OF MINNEAPOLIS APPROVAL STAMP:



701 Washington Ave. N, Ste 200 | Minneapolis, MN 55401 | 612.338.2029

CommonBond Communities

# 1080 MONTREAL AVENUE ST PAUL, MN 55116

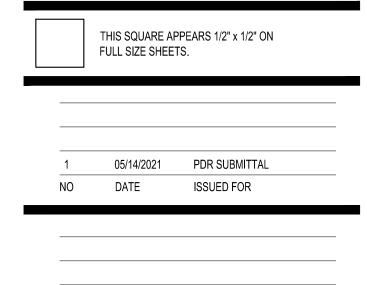

DATE REVISION



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PROJECT NAME: WHITTIER COMMUNITY HOUSING

2609 BLAISDELL AVE S MINNEAPOLIS, MN 55408


# DRAWING TITLE: **CIVIL STANDARD NOTES**


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# WARNING


LOCATION OF UNDERGROUND UTILITIES TO **BE VERIFIED BY CONTRACTOR. CALL** BEFORE DIGGING. GOPHER STATE ONE CALL 1-800-252-1166 REQUIRED BY LAW



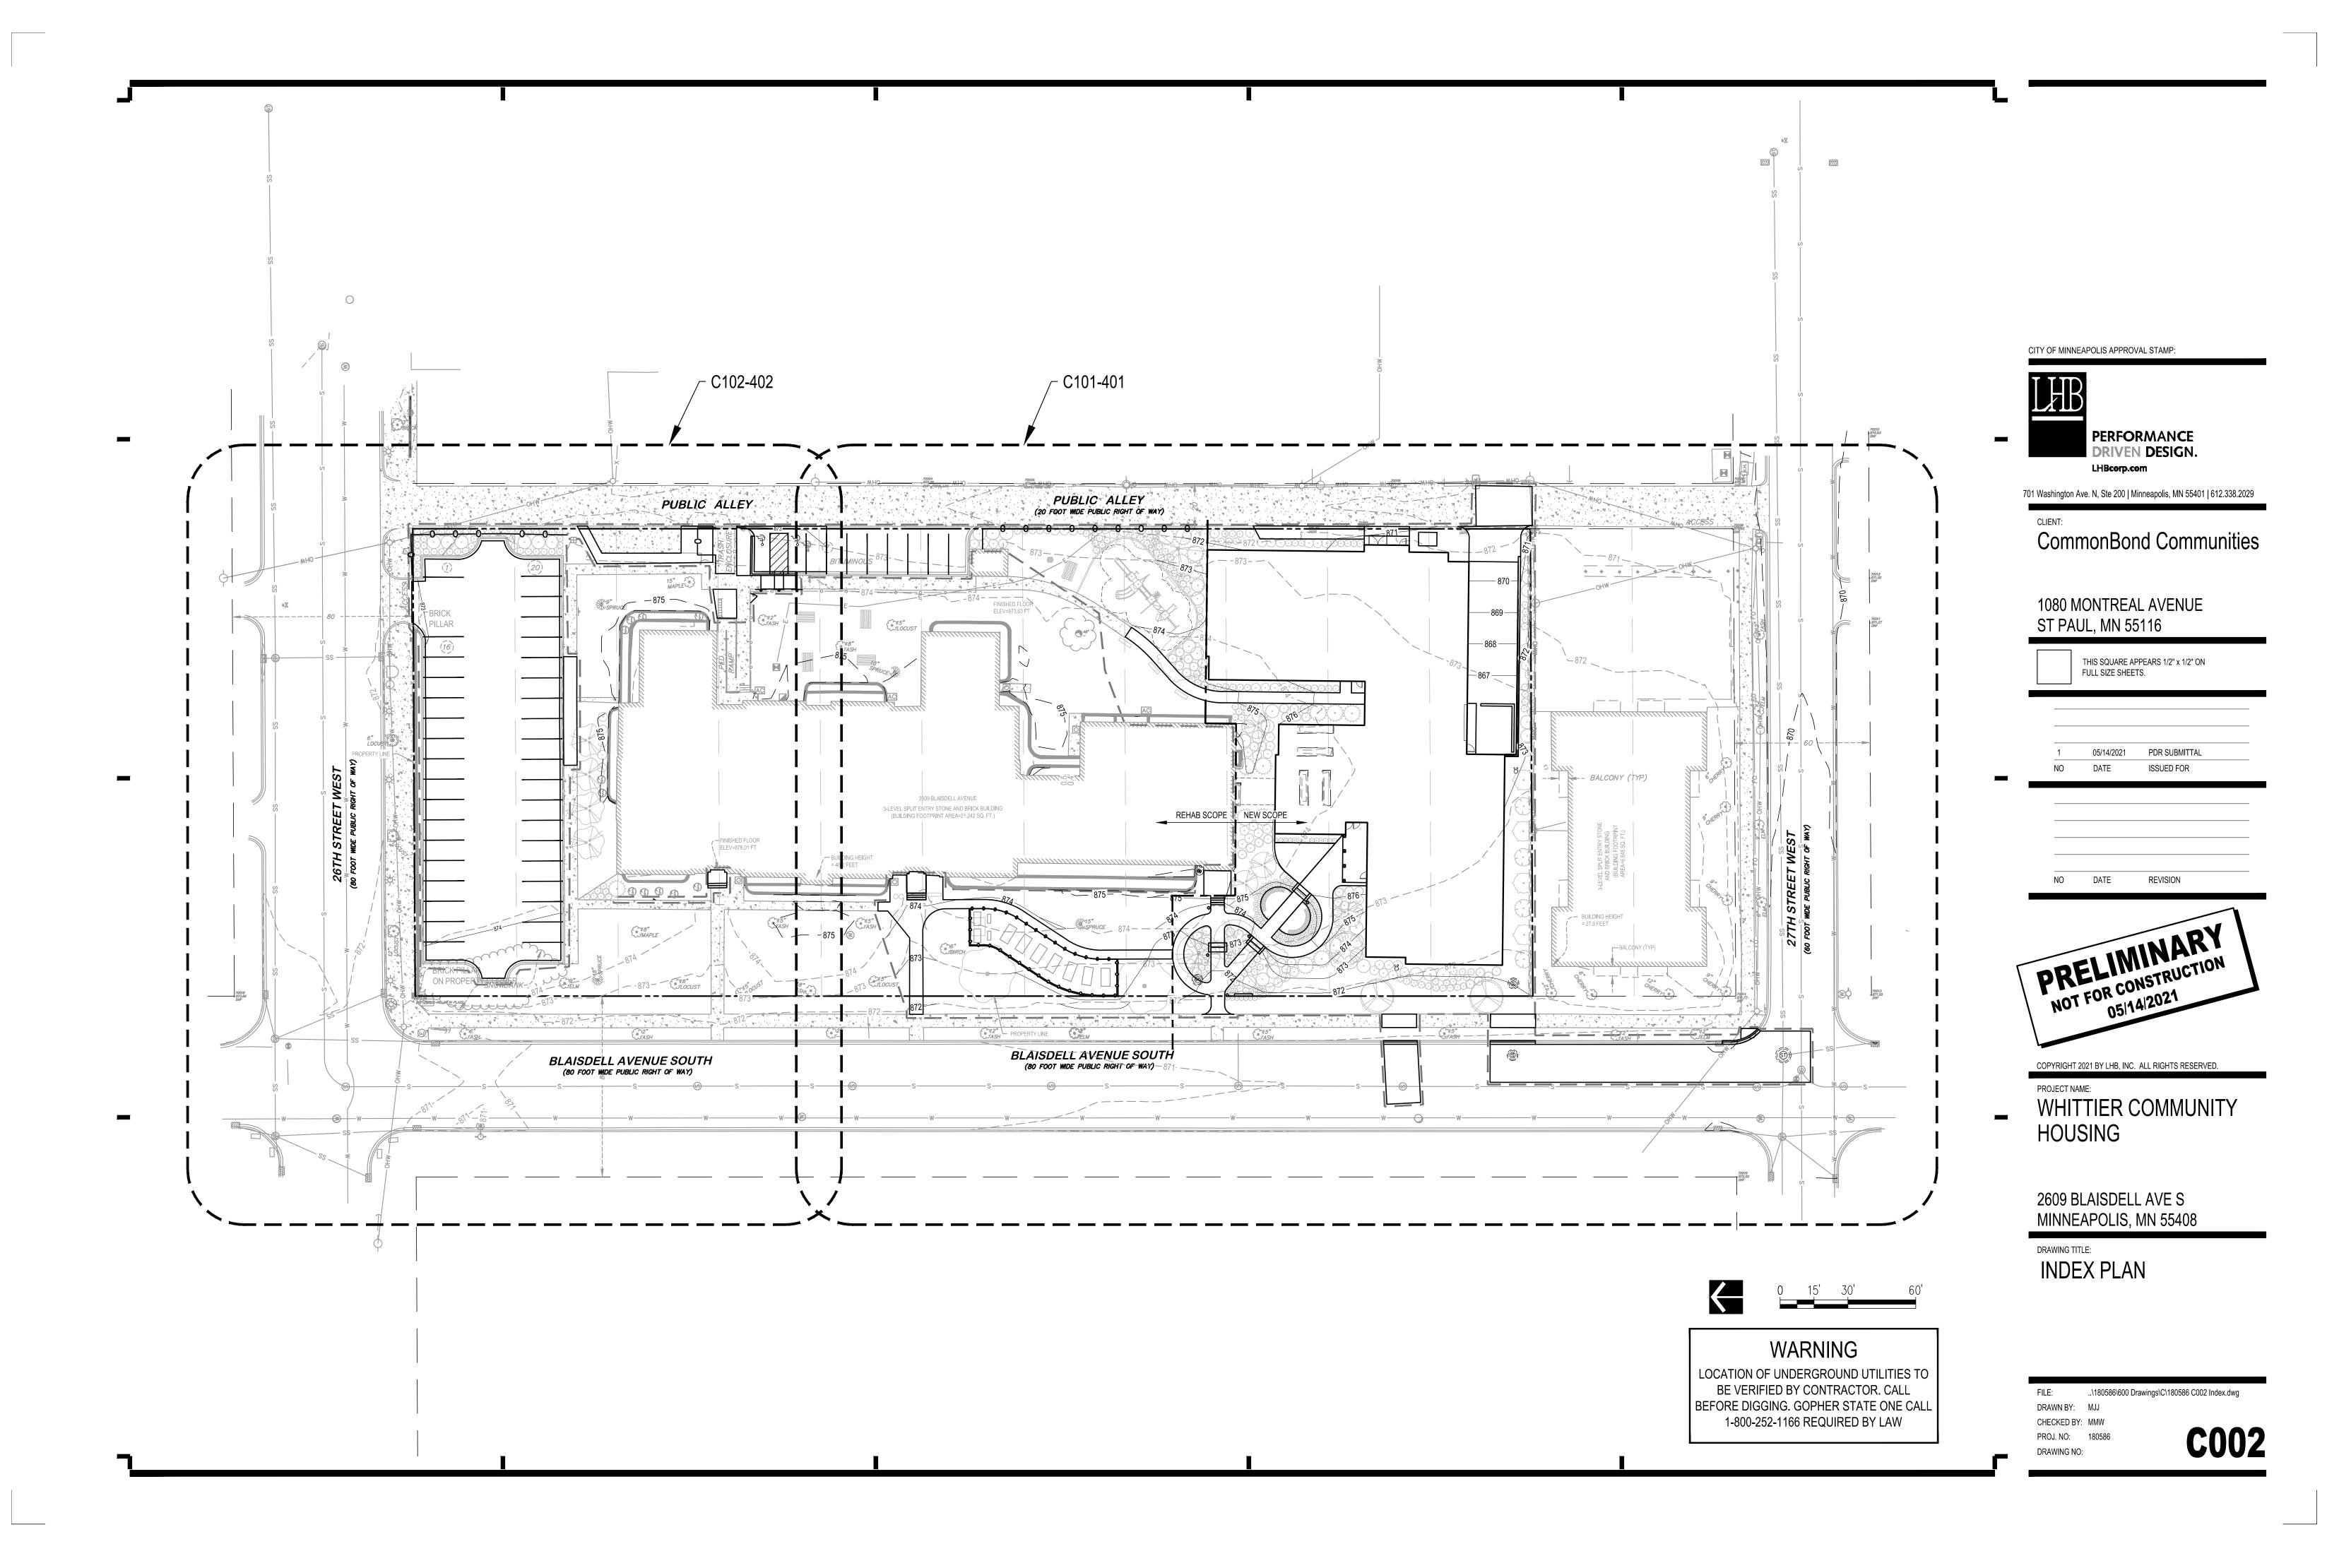

					(80 FOOT WIDE P	UBLIC RIGHT	$Or^{-}WAT_{7} = 0$	8/1—
			24" BRICK				24" BRICK	
	— s — — — — — — — — — — — — — — — — — —	S	S	S	@ RE=871.34 IE=855.0	s	S	
-			6" WATERMAIN					
	W	W	W		W	W		

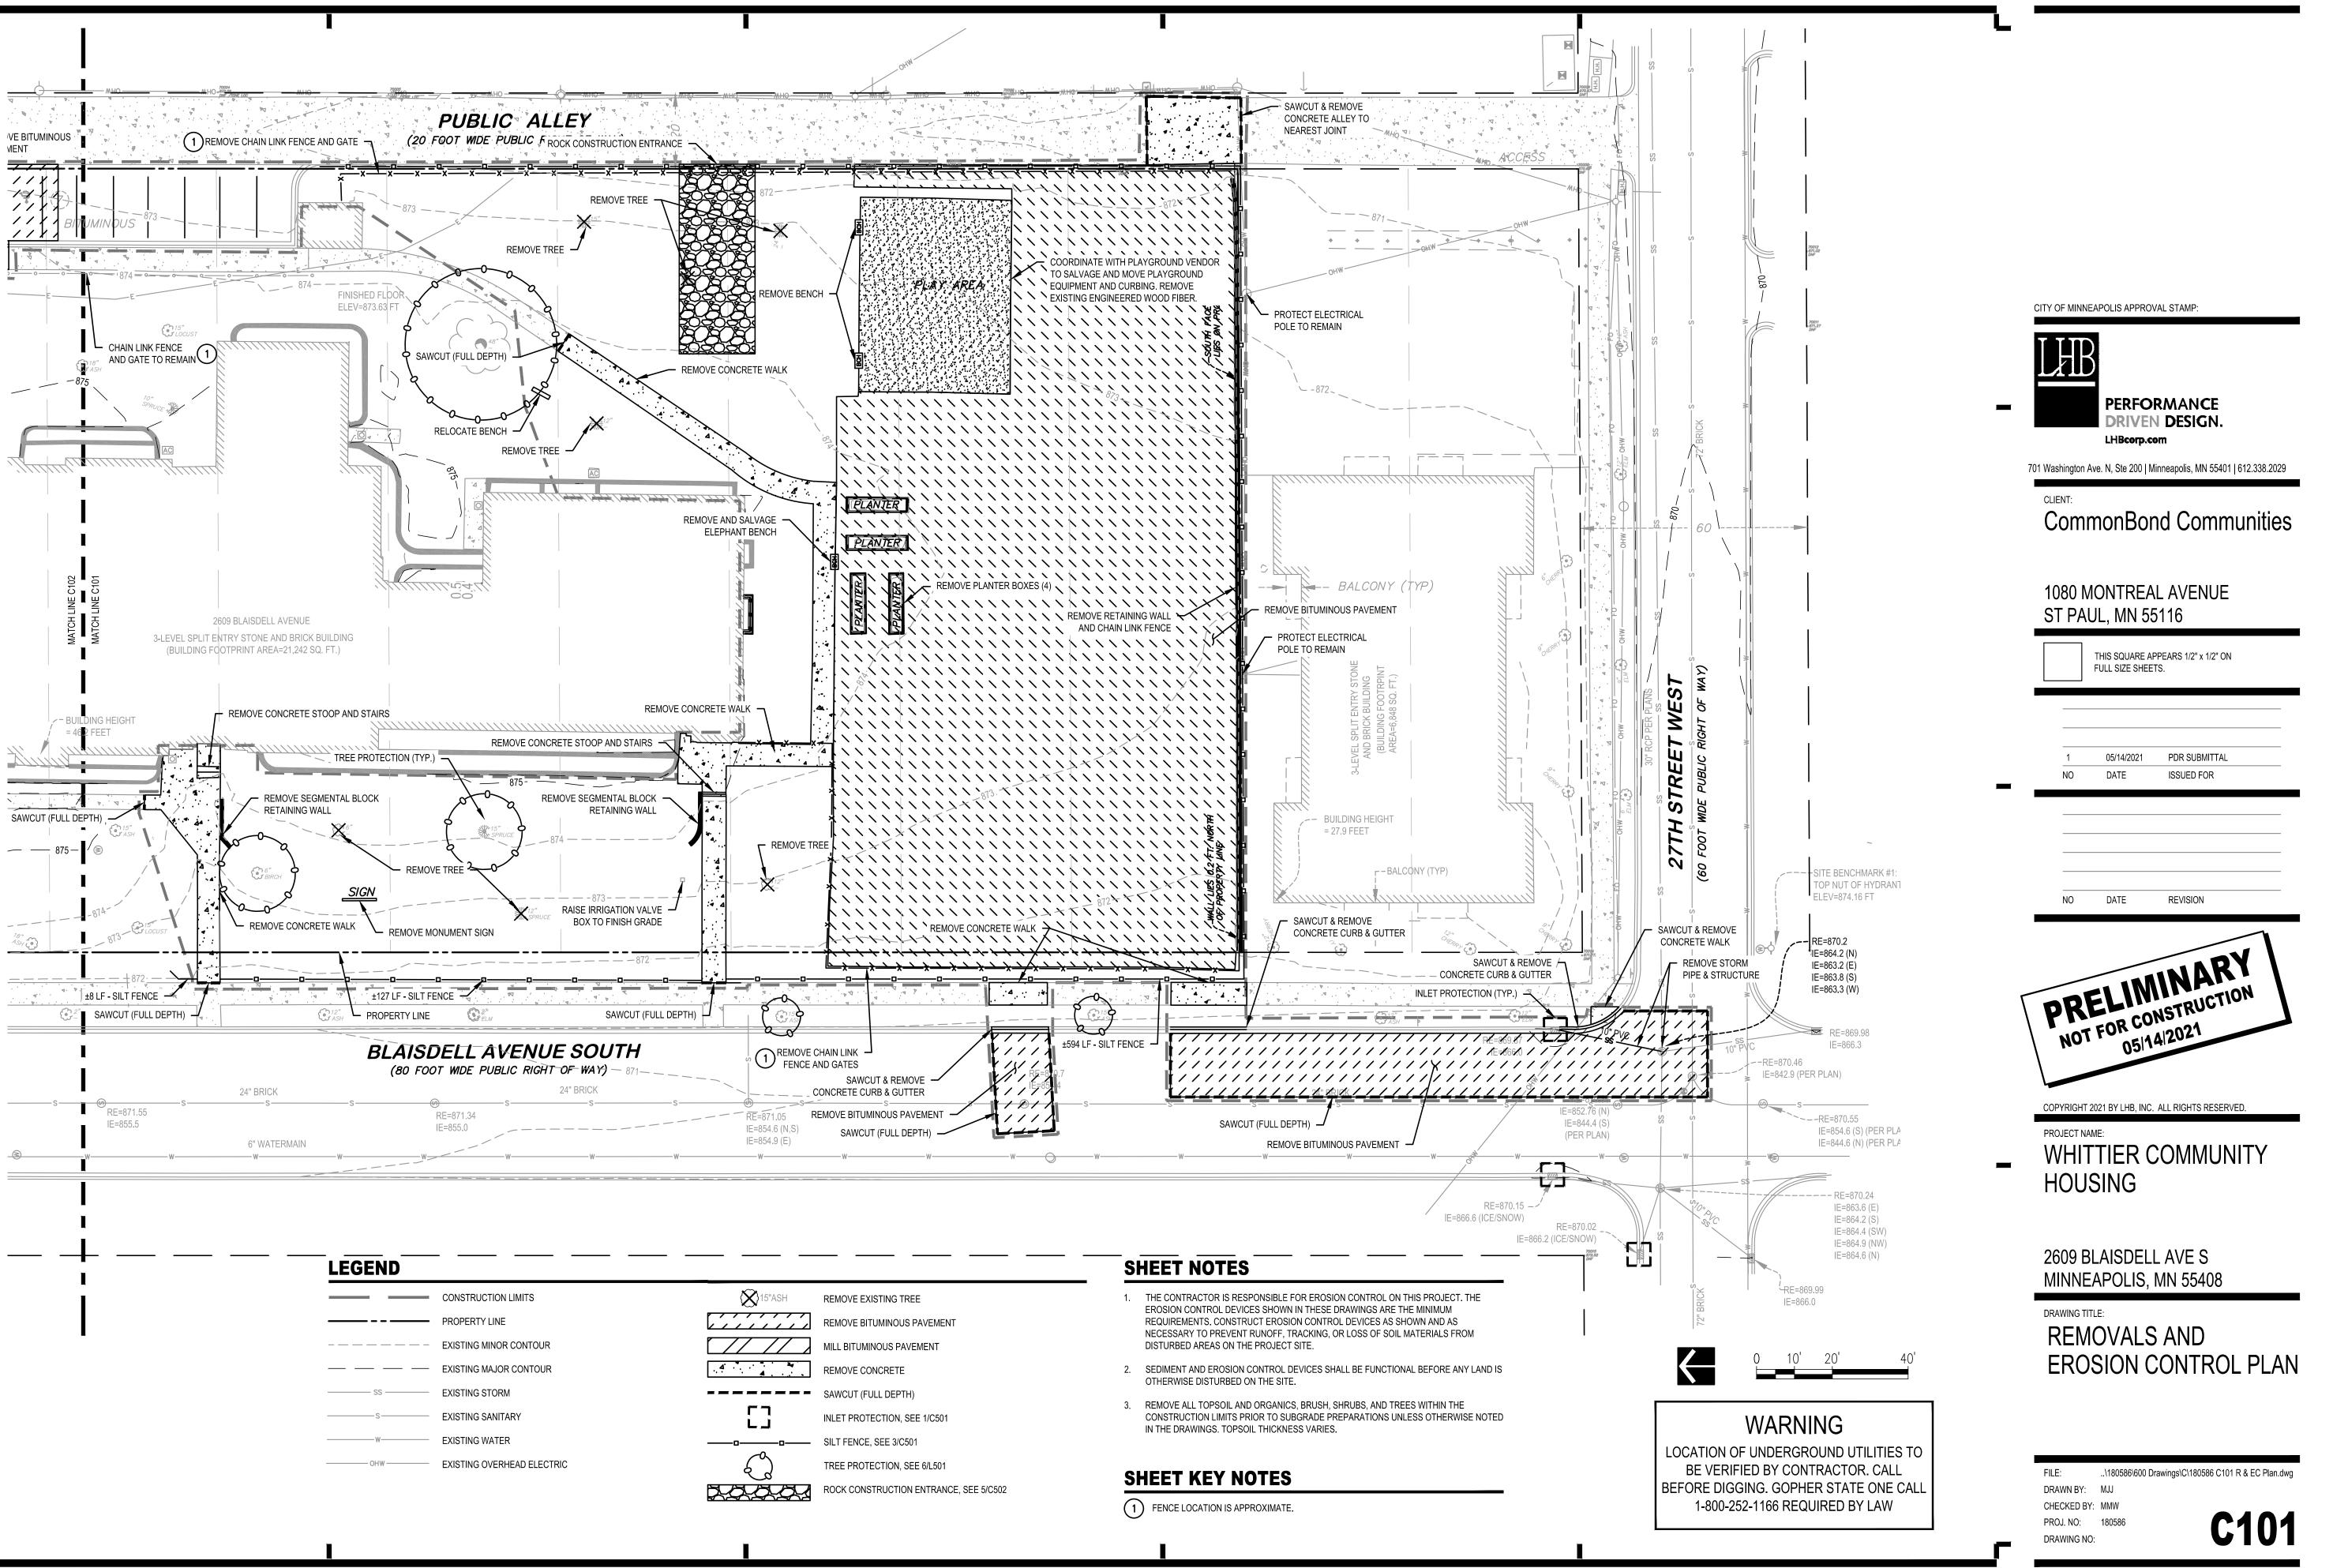LEGEND	
	CONSTRUCTION LIMITS
	PROPERTY LINE
	EXISTING MINOR CONTOUR
	EXISTING MAJOR CONTOUR
SS	EXISTING STORM
S	EXISTING SANITARY
	EXISTING WATER
OHW	EXISTING OVERHEAD ELECTRIC

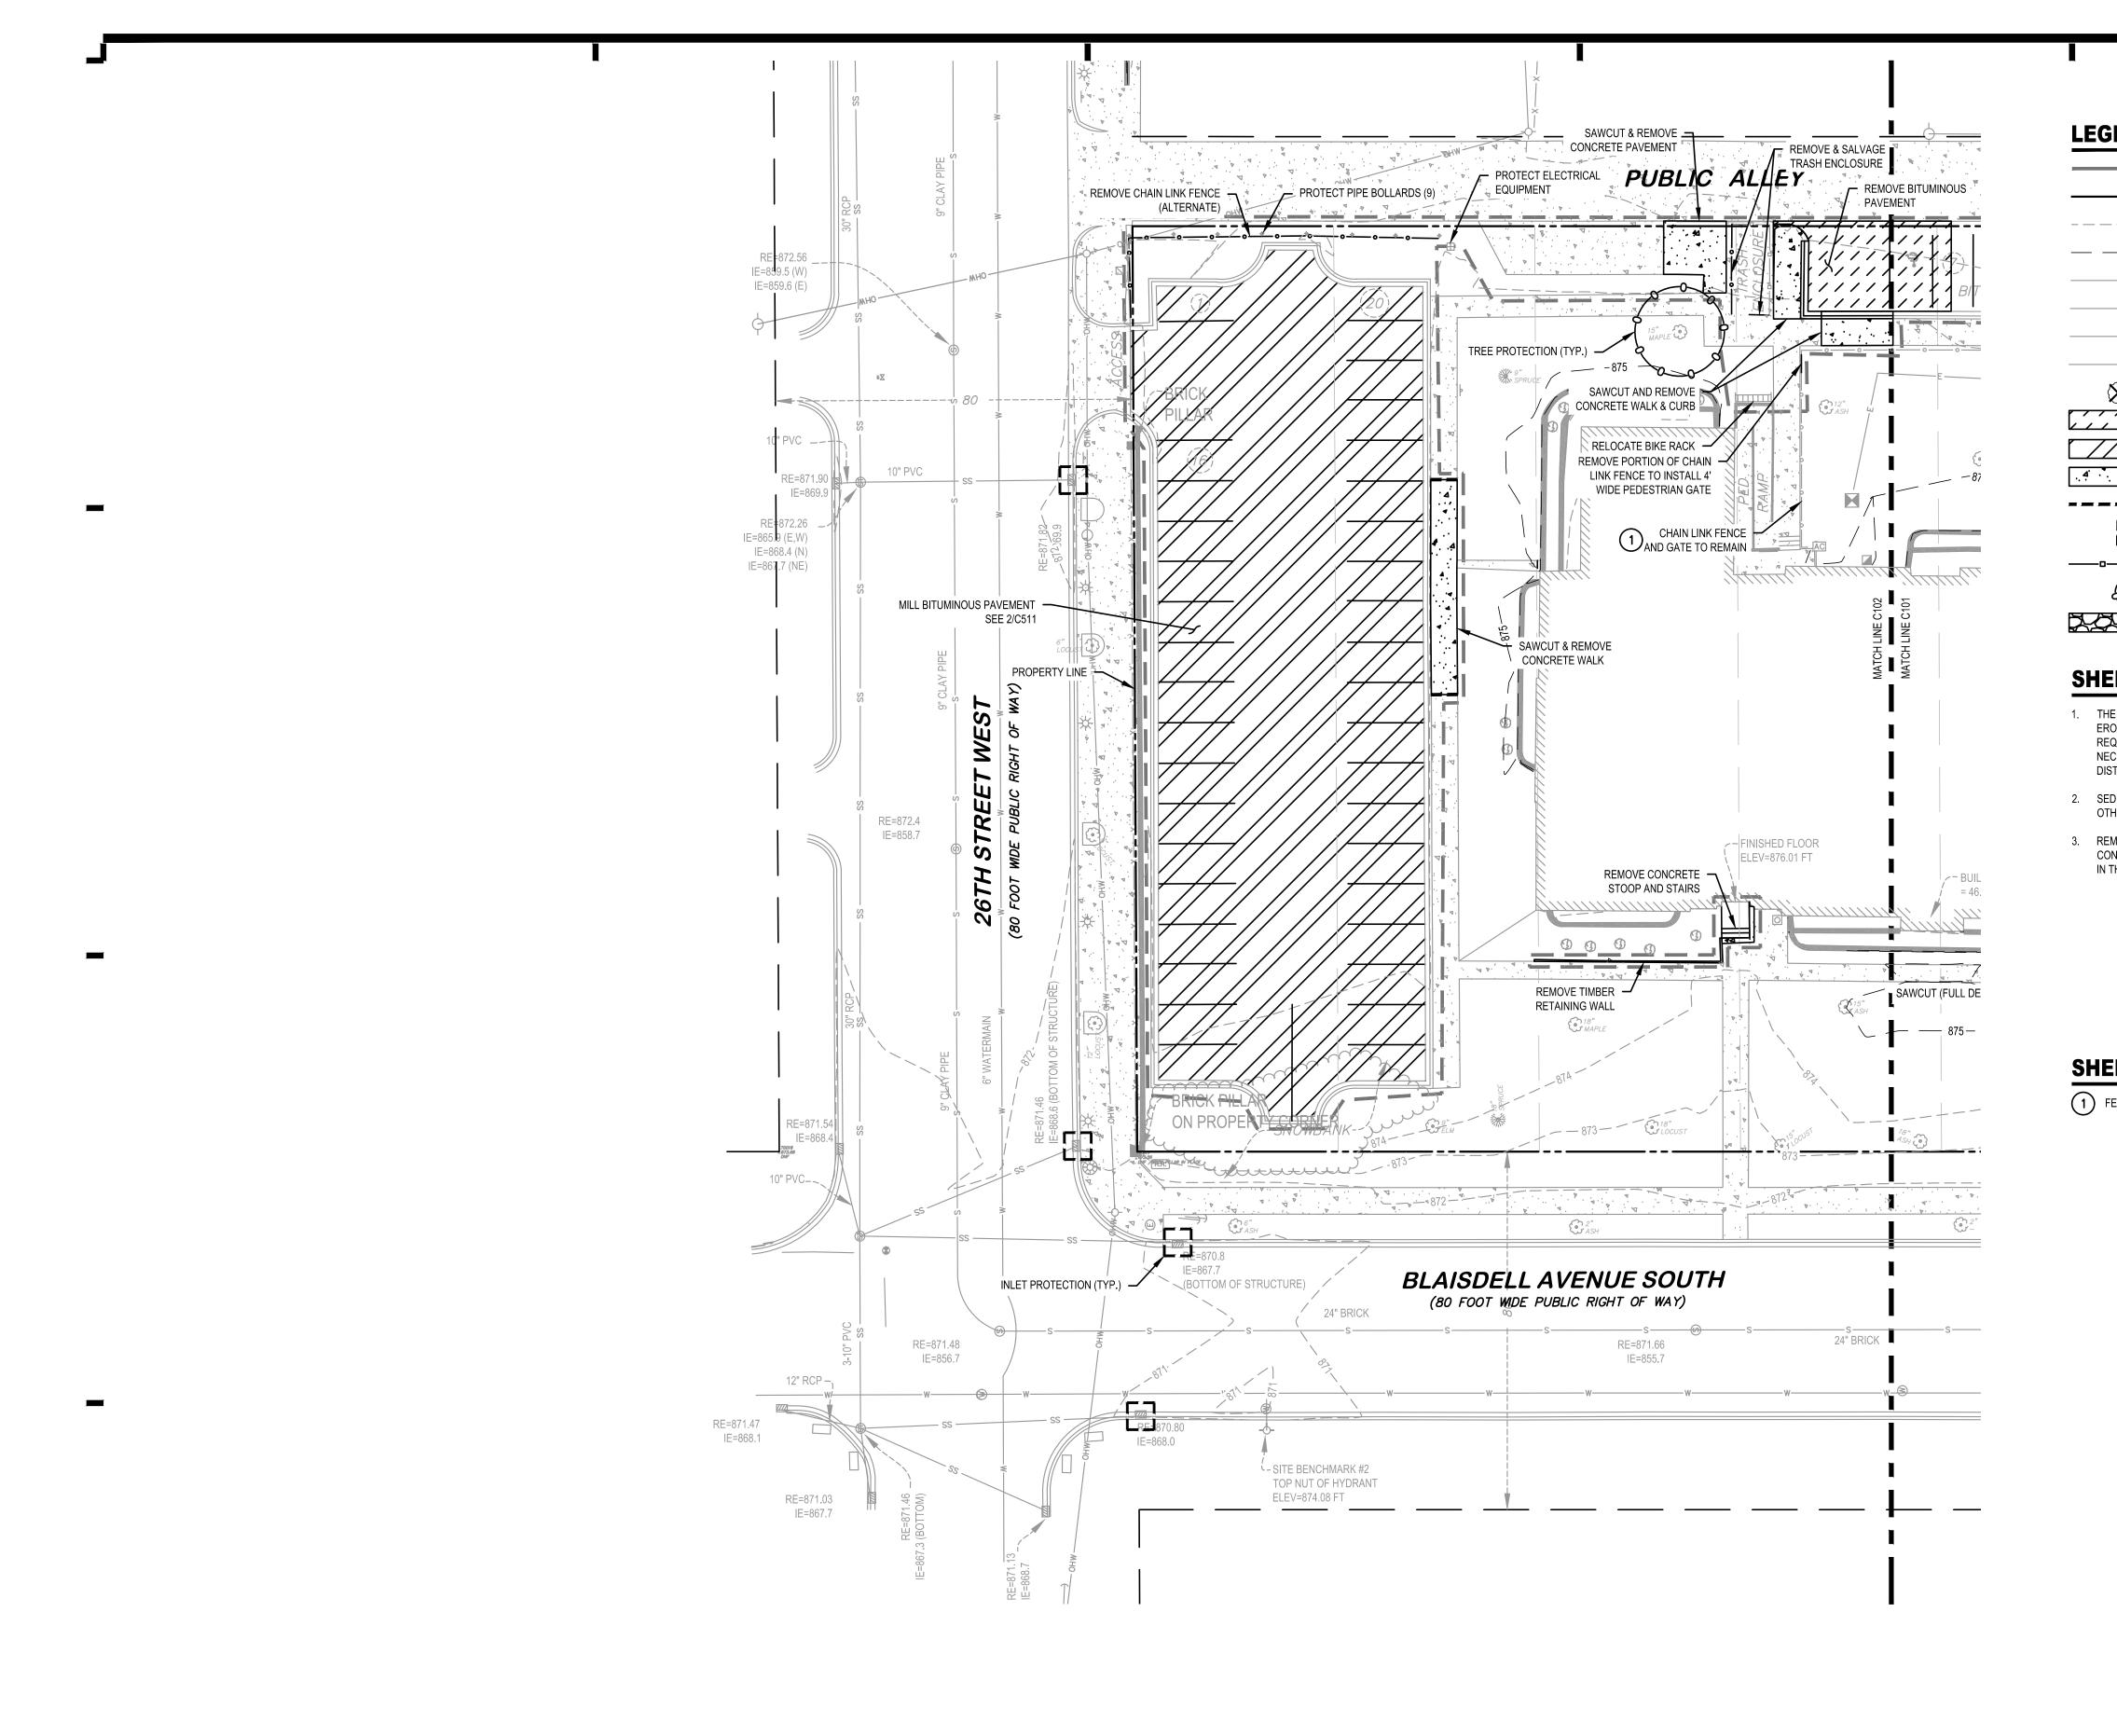

# LEGEND

	CONSTRUCTION LIMITS
	PROPERTY LINE
	EXISTING MINOR CONTOUR
	EXISTING MAJOR CONTOUR
SS	EXISTING STORM
S	EXISTING SANITARY
W	EXISTING WATER
OHW	EXISTING OVERHEAD ELECTRIC
15"ASH	REMOVE EXISTING TREE
	REMOVE BITUMINOUS PAVEMENT
	MILL BITUMINOUS PAVEMENT
4	REMOVE CONCRETE
	SAWCUT (FULL DEPTH)
	INLET PROTECTION, SEE 1/C501
o	SILT FENCE, SEE 3/C501
$\langle \rangle$	TREE PROTECTION, SEE 6/L501
1001	ROCK CONSTRUCTION ENTRANCE, SEE 5/C502

# SHEET NOTES

1. THE CONTRACTOR IS RESPONSIBLE FOR EROSION CONTROL ON THIS PROJECT. THE EROSION CONTROL DEVICES SHOWN IN THESE DRAWINGS ARE THE MINIMUM REQUIREMENTS. CONSTRUCT EROSION CONTROL DEVICES AS SHOWN AND AS NECESSARY TO PREVENT RUNOFF, TRACKING, OR LOSS OF SOIL MATERIALS FROM DISTURBED AREAS ON THE PROJECT SITE.

2. SEDIMENT AND EROSION CONTROL DEVICES SHALL BE FUNCTIONAL BEFORE ANY LAND IS OTHERWISE DISTURBED ON THE SITE.

3. REMOVE ALL TOPSOIL AND ORGANICS, BRUSH, SHRUBS, AND TREES WITHIN THE CONSTRUCTION LIMITS PRIOR TO SUBGRADE PREPARATIONS UNLESS OTHERWISE NOTED IN THE DRAWINGS. TOPSOIL THICKNESS VARIES.






PERFORMANCE **DRIVEN DESIGN.** LHBcorp.com

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# SHEET KEY NOTES

1 FENCE LOCATION IS APPROXIMATE.

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PROJECT NAME: WHITTIER COMMUNITY HOUSING

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REMOVALS AND

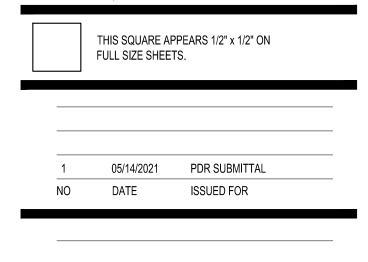**EROSION CONTROL PLAN** 

 $\leftarrow$ 

0 10' 20'


# WARNING

LOCATION OF UNDERGROUND UTILITIES TO BE VERIFIED BY CONTRACTOR. CALL BEFORE DIGGING. GOPHER STATE ONE CALL 1-800-252-1166 REQUIRED BY LAW


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DRAWING TITLE:





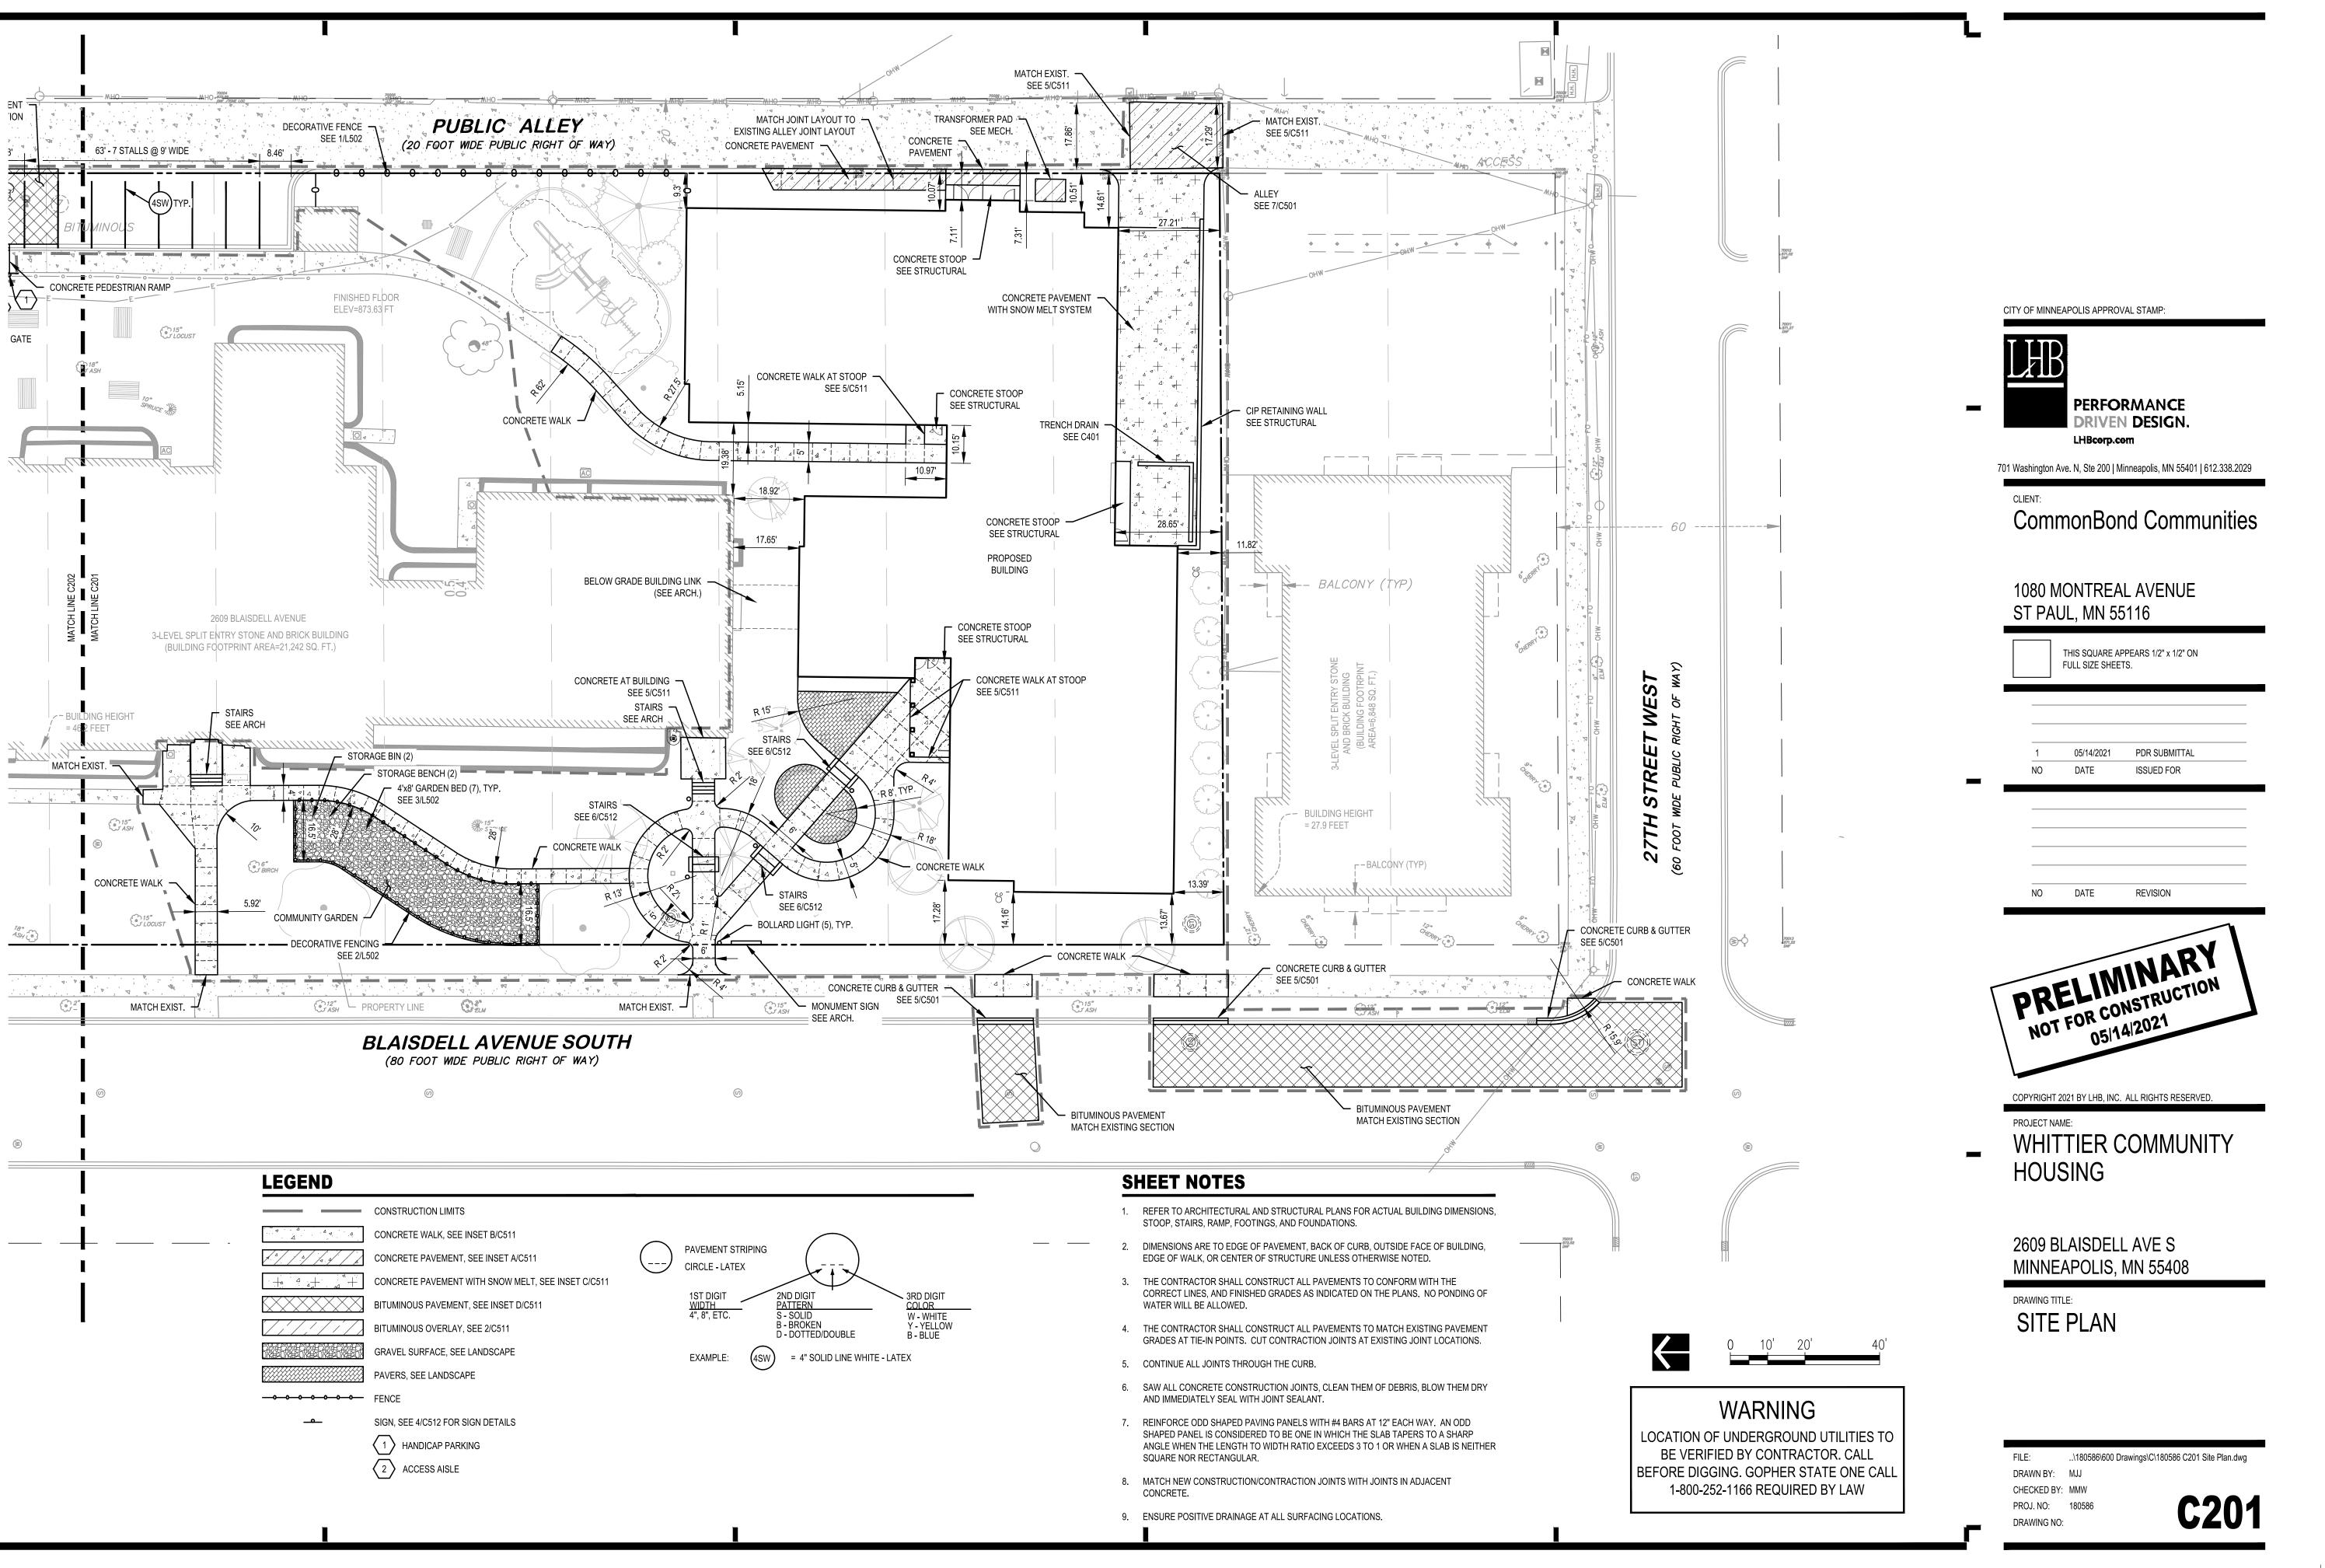

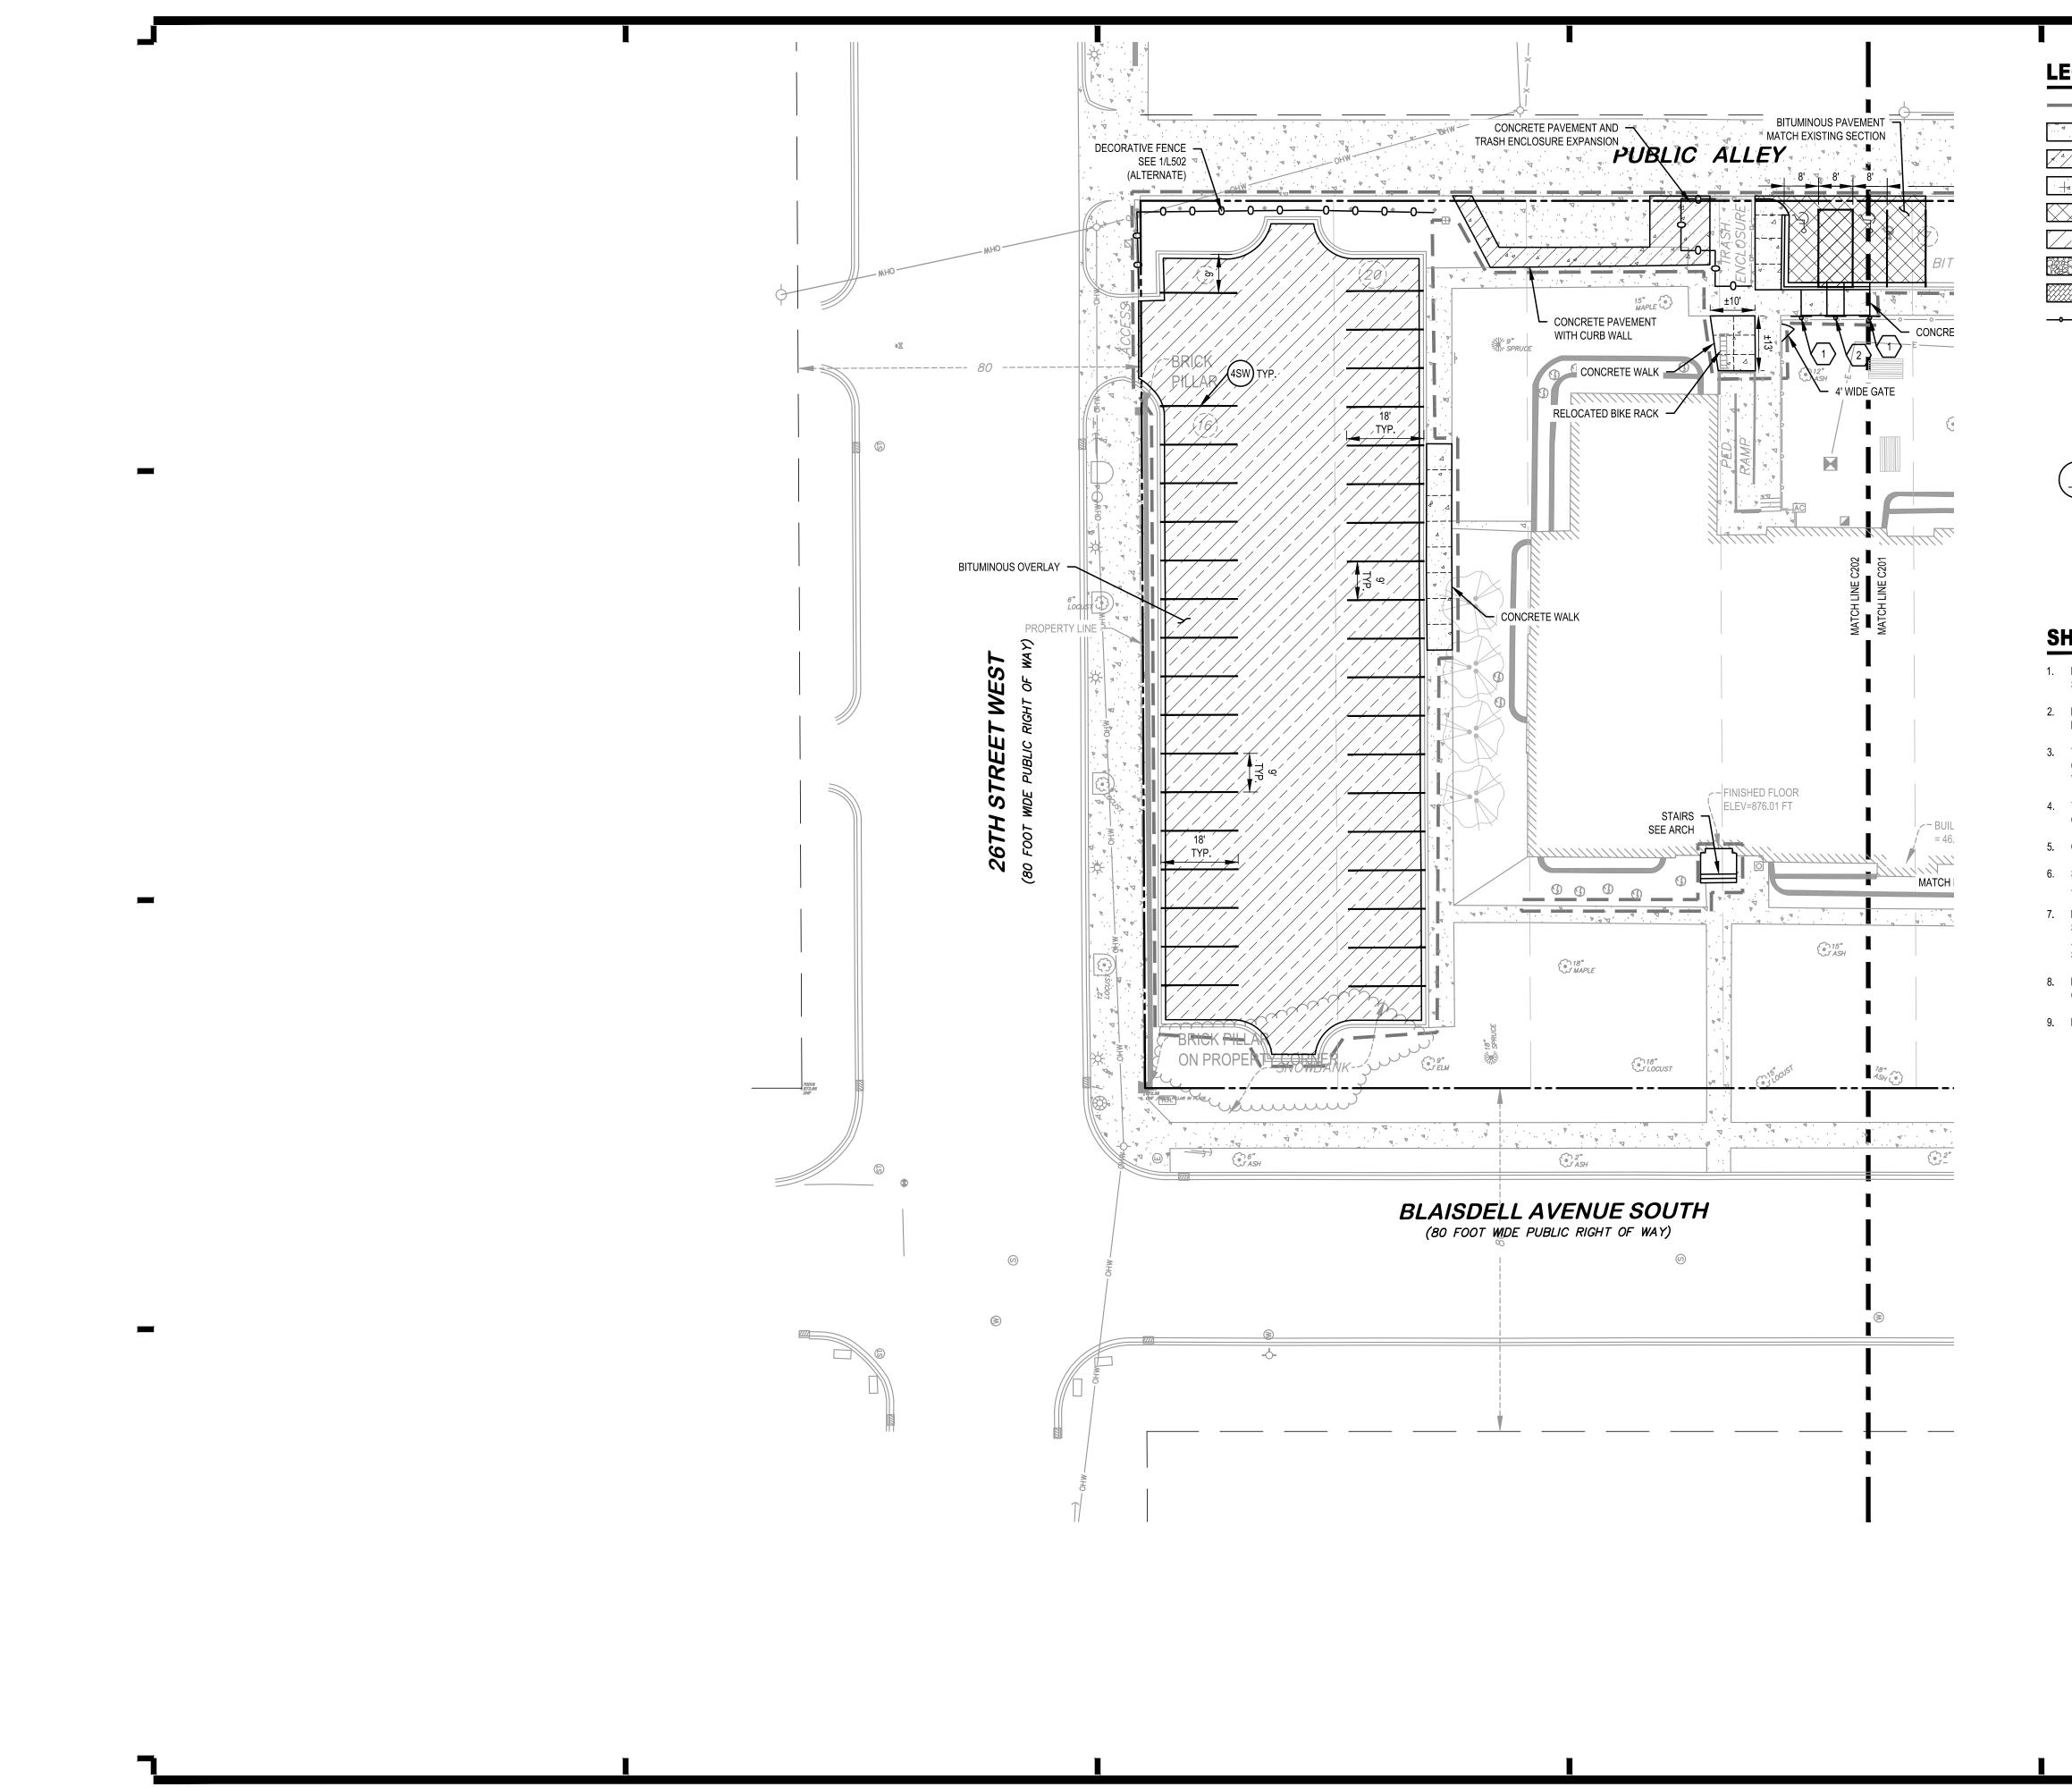

# LEGEND

	CONSTRUCTION LIMITS
а	CONCRETE WALK, SEE INSET B/C511
	CONCRETE PAVEMENT, SEE INSET A/C511
	CONCRETE PAVEMENT WITH SNOW MELT, SEE INSET C/C511
	BITUMINOUS PAVEMENT, SEE INSET D/C511
///////	BITUMINOUS OVERLAY, SEE 2/C511
	GRAVEL SURFACE, SEE LANDSCAPE
	PAVERS, SEE LANDSCAPE
	FENCE
	SIGN, SEE 4/C512 FOR SIGN DETAILS
	1 HANDICAP PARKING
	2 ACCESS AISLE
PAVEMENT S CIRCLE - LATI	
4", 8", ETC.	2ND DIGIT PATTERN S - SOLID B - BROKEN D - DOTTED/DOUBLE 3RD DIGIT COLOR W - WHITE B - BLLOW B - BLUE
EXAMPLE:	4SW) = 4" SOLID LINE WHITE - LATEX

# SHEET NOTES

- 1. REFER TO ARCHITECTURAL AND STRUCTURAL PLANS FOR ACTUAL BUILDING DIMENSIONS, STOOP, STAIRS, RAMP, FOOTINGS, AND FOUNDATIONS.
- 2. DIMENSIONS ARE TO EDGE OF PAVEMENT, BACK OF CURB, OUTSIDE FACE OF BUILDING, EDGE OF WALK, OR CENTER OF STRUCTURE UNLESS OTHERWISE NOTED.
- 3. THE CONTRACTOR SHALL CONSTRUCT ALL PAVEMENTS TO CONFORM WITH THE CORRECT LINES, AND FINISHED GRADES AS INDICATED ON THE PLANS. NO PONDING OF WATER WILL BE ALLOWED.
- 4. THE CONTRACTOR SHALL CONSTRUCT ALL PAVEMENTS TO MATCH EXISTING PAVEMENT GRADES AT TIE-IN POINTS. CUT CONTRACTION JOINTS AT EXISTING JOINT LOCATIONS. 5. CONTINUE ALL JOINTS THROUGH THE CURB.
- 6. SAW ALL CONCRETE CONSTRUCTION JOINTS, CLEAN THEM OF DEBRIS, BLOW THEM DRY AND IMMEDIATELY SEAL WITH JOINT SEALANT.
- 7. REINFORCE ODD SHAPED PAVING PANELS WITH #4 BARS AT 12" EACH WAY. AN ODD SHAPED PANEL IS CONSIDERED TO BE ONE IN WHICH THE SLAB TAPERS TO A SHARP ANGLE WHEN THE LENGTH TO WIDTH RATIO EXCEEDS 3 TO 1 OR WHEN A SLAB IS NEITHER SQUARE NOR RECTANGULAR.
- 8. MATCH NEW CONSTRUCTION/CONTRACTION JOINTS WITH JOINTS IN ADJACENT CONCRETE.
- 9. ENSURE POSITIVE DRAINAGE AT ALL SURFACING LOCATIONS.

CITY OF MINNEAPOLIS APPROVAL STAMP:




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DATE



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# DRAWING TITLE: SITE PLAN

FILE: ...\180586\600 Drawings\C\180586 C201 Site Plan.dwg DRAWN BY: MJJ CHECKED BY: MMW PROJ. NO: 180586 DRAWING NO:




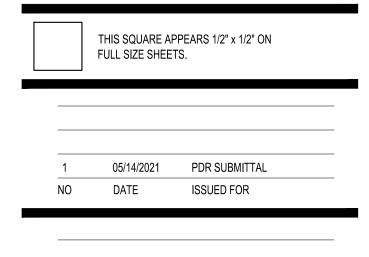

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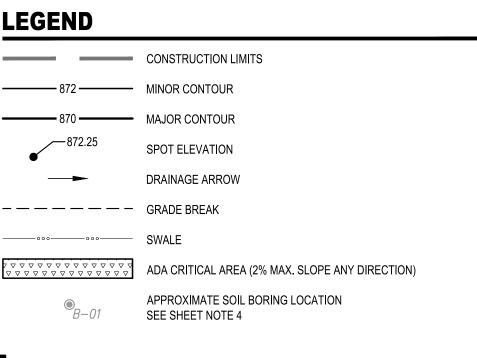
# WARNING


LOCATION OF UNDERGROUND UTILITIES TO BE VERIFIED BY CONTRACTOR. CALL BEFORE DIGGING. GOPHER STATE ONE CALL 1-800-252-1166 REQUIRED BY LAW

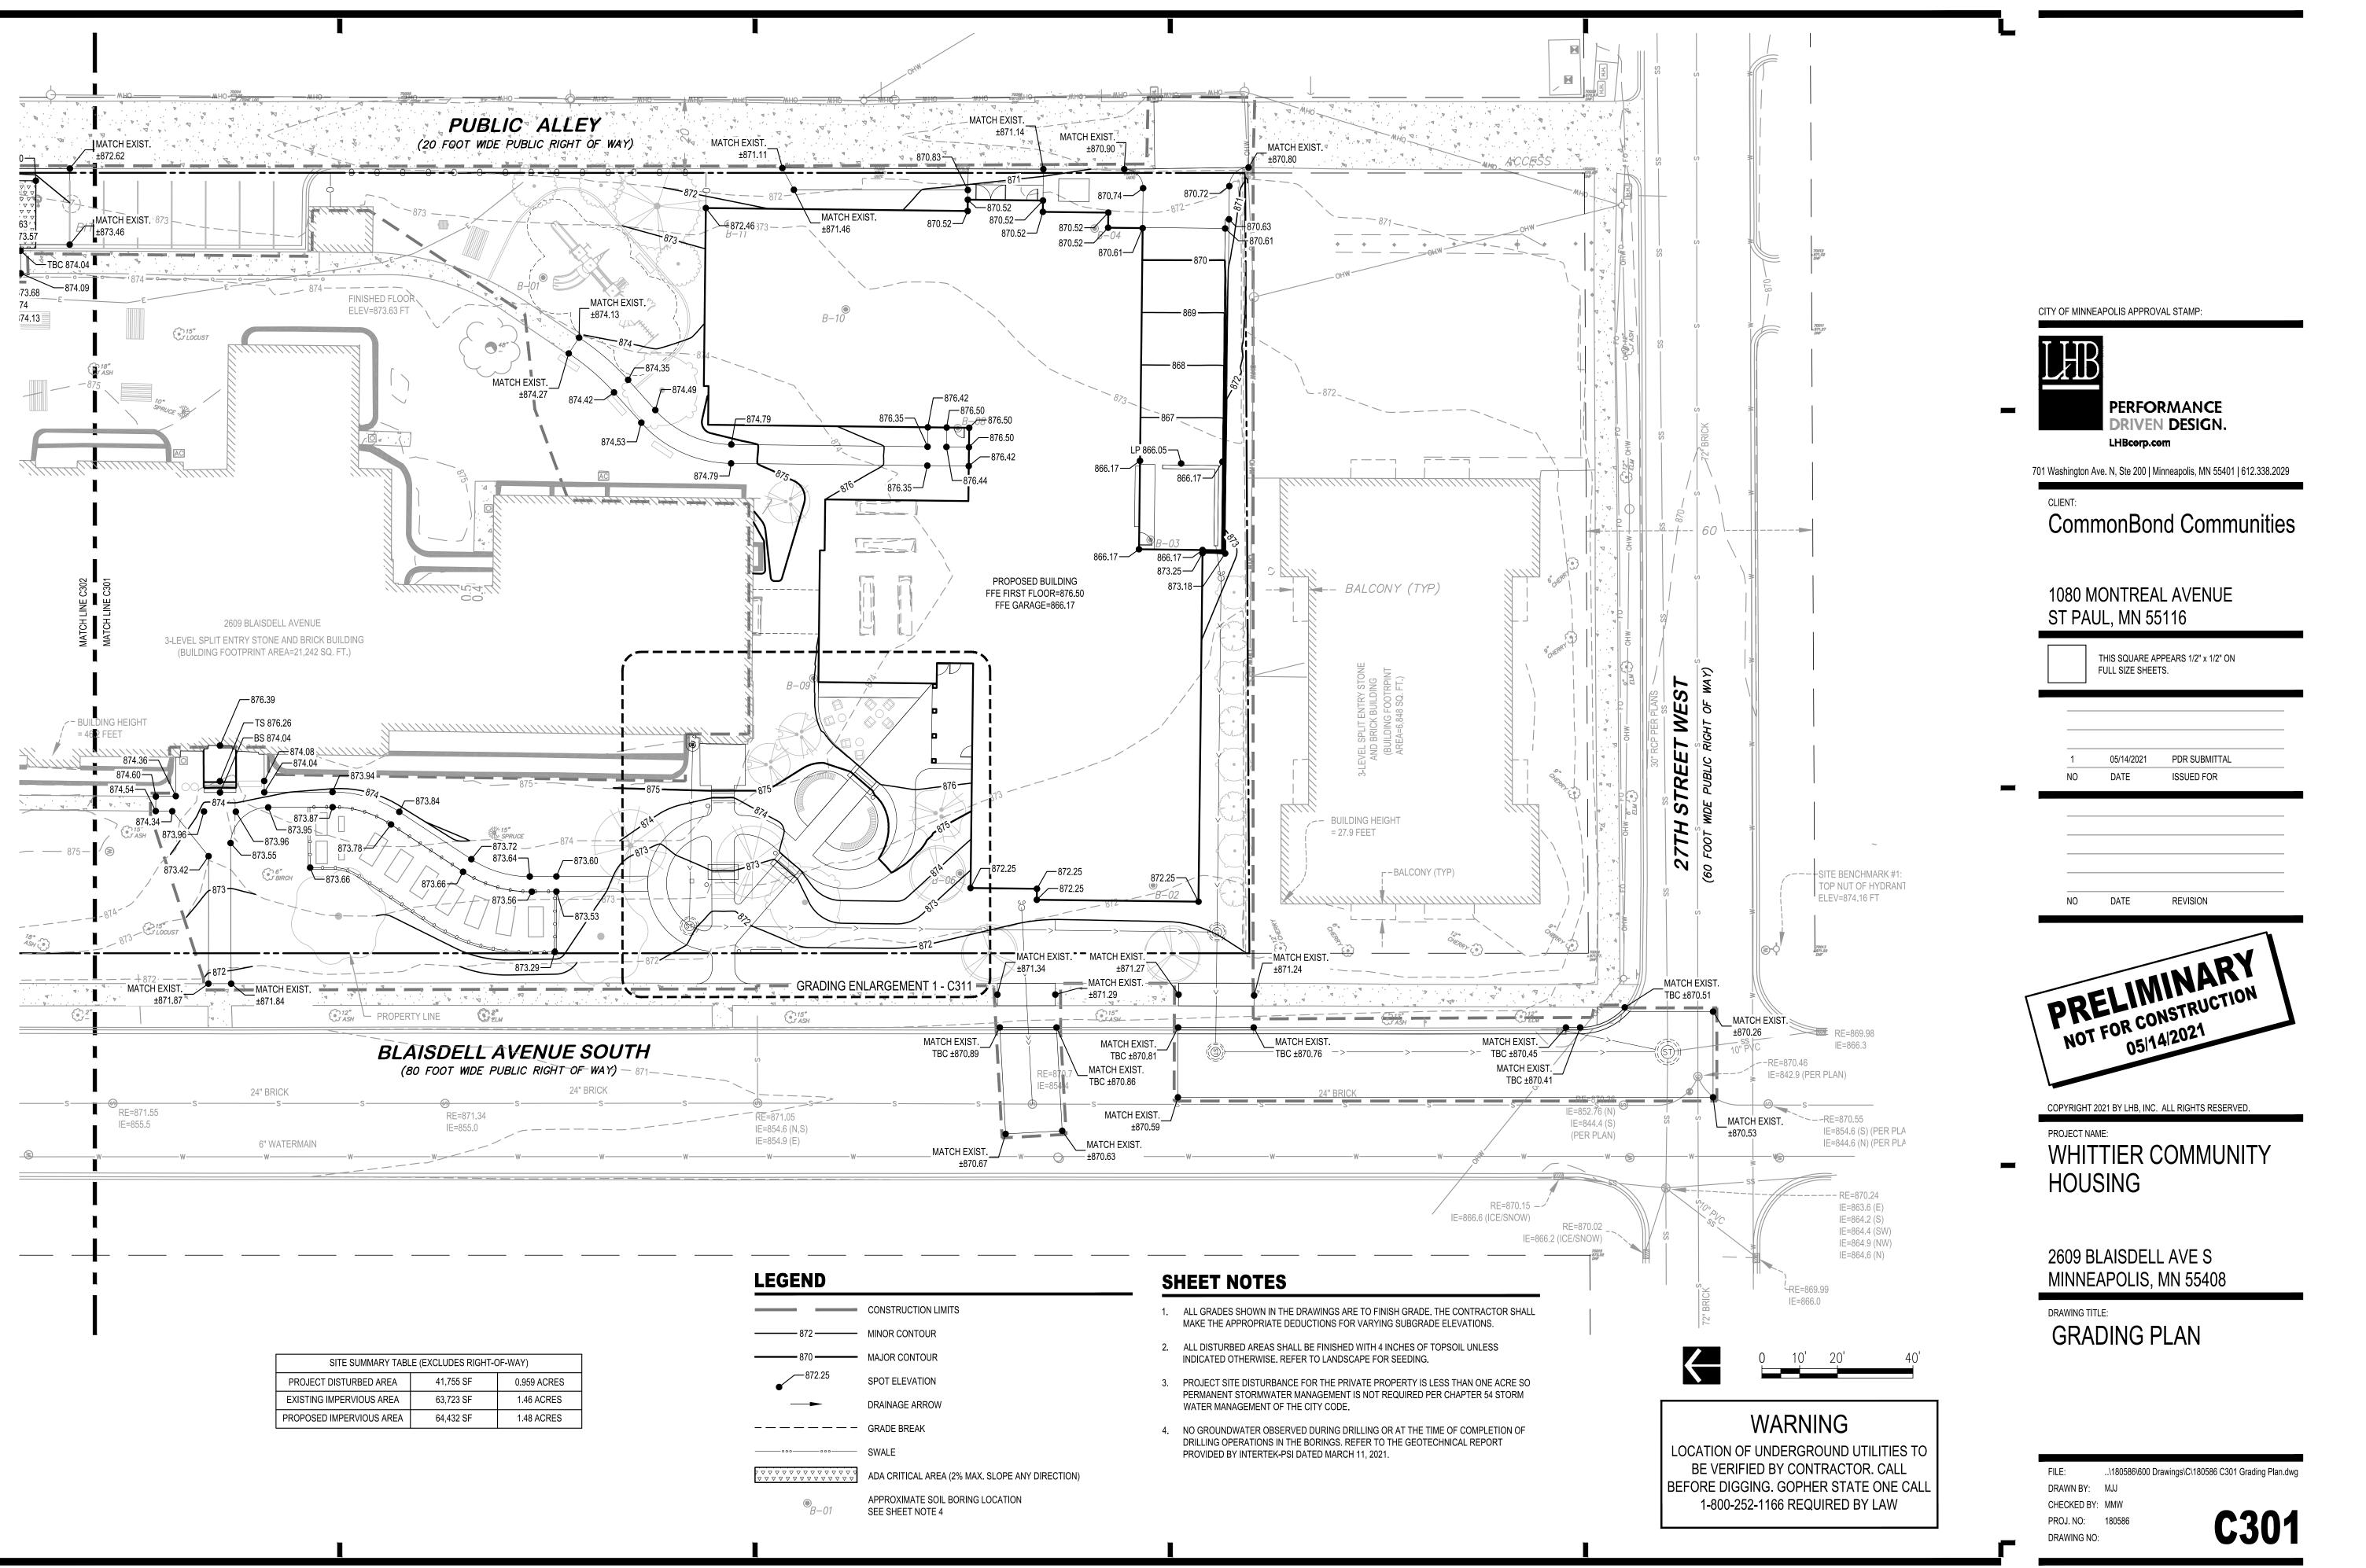

			24" BRICK				24" BRICK	
	 RE=871.55 IE=855.5	S	S	S	@ RE=871.34 IE=855.0	s	S	
8	A/	147	6" WATERMAIN	W	W	W	W	
	14	VV	W			44	44	

SITE SUMMARY TABLE (EXCLUDES RIGHT-OF-WAY)					
PROJECT DISTURBED AREA	41,755 SF	0.959 ACRES			
EXISTING IMPERVIOUS AREA	63,723 SF	1.46 ACRES			
PROPOSED IMPERVIOUS AREA	64,432 SF	1.48 ACRES			



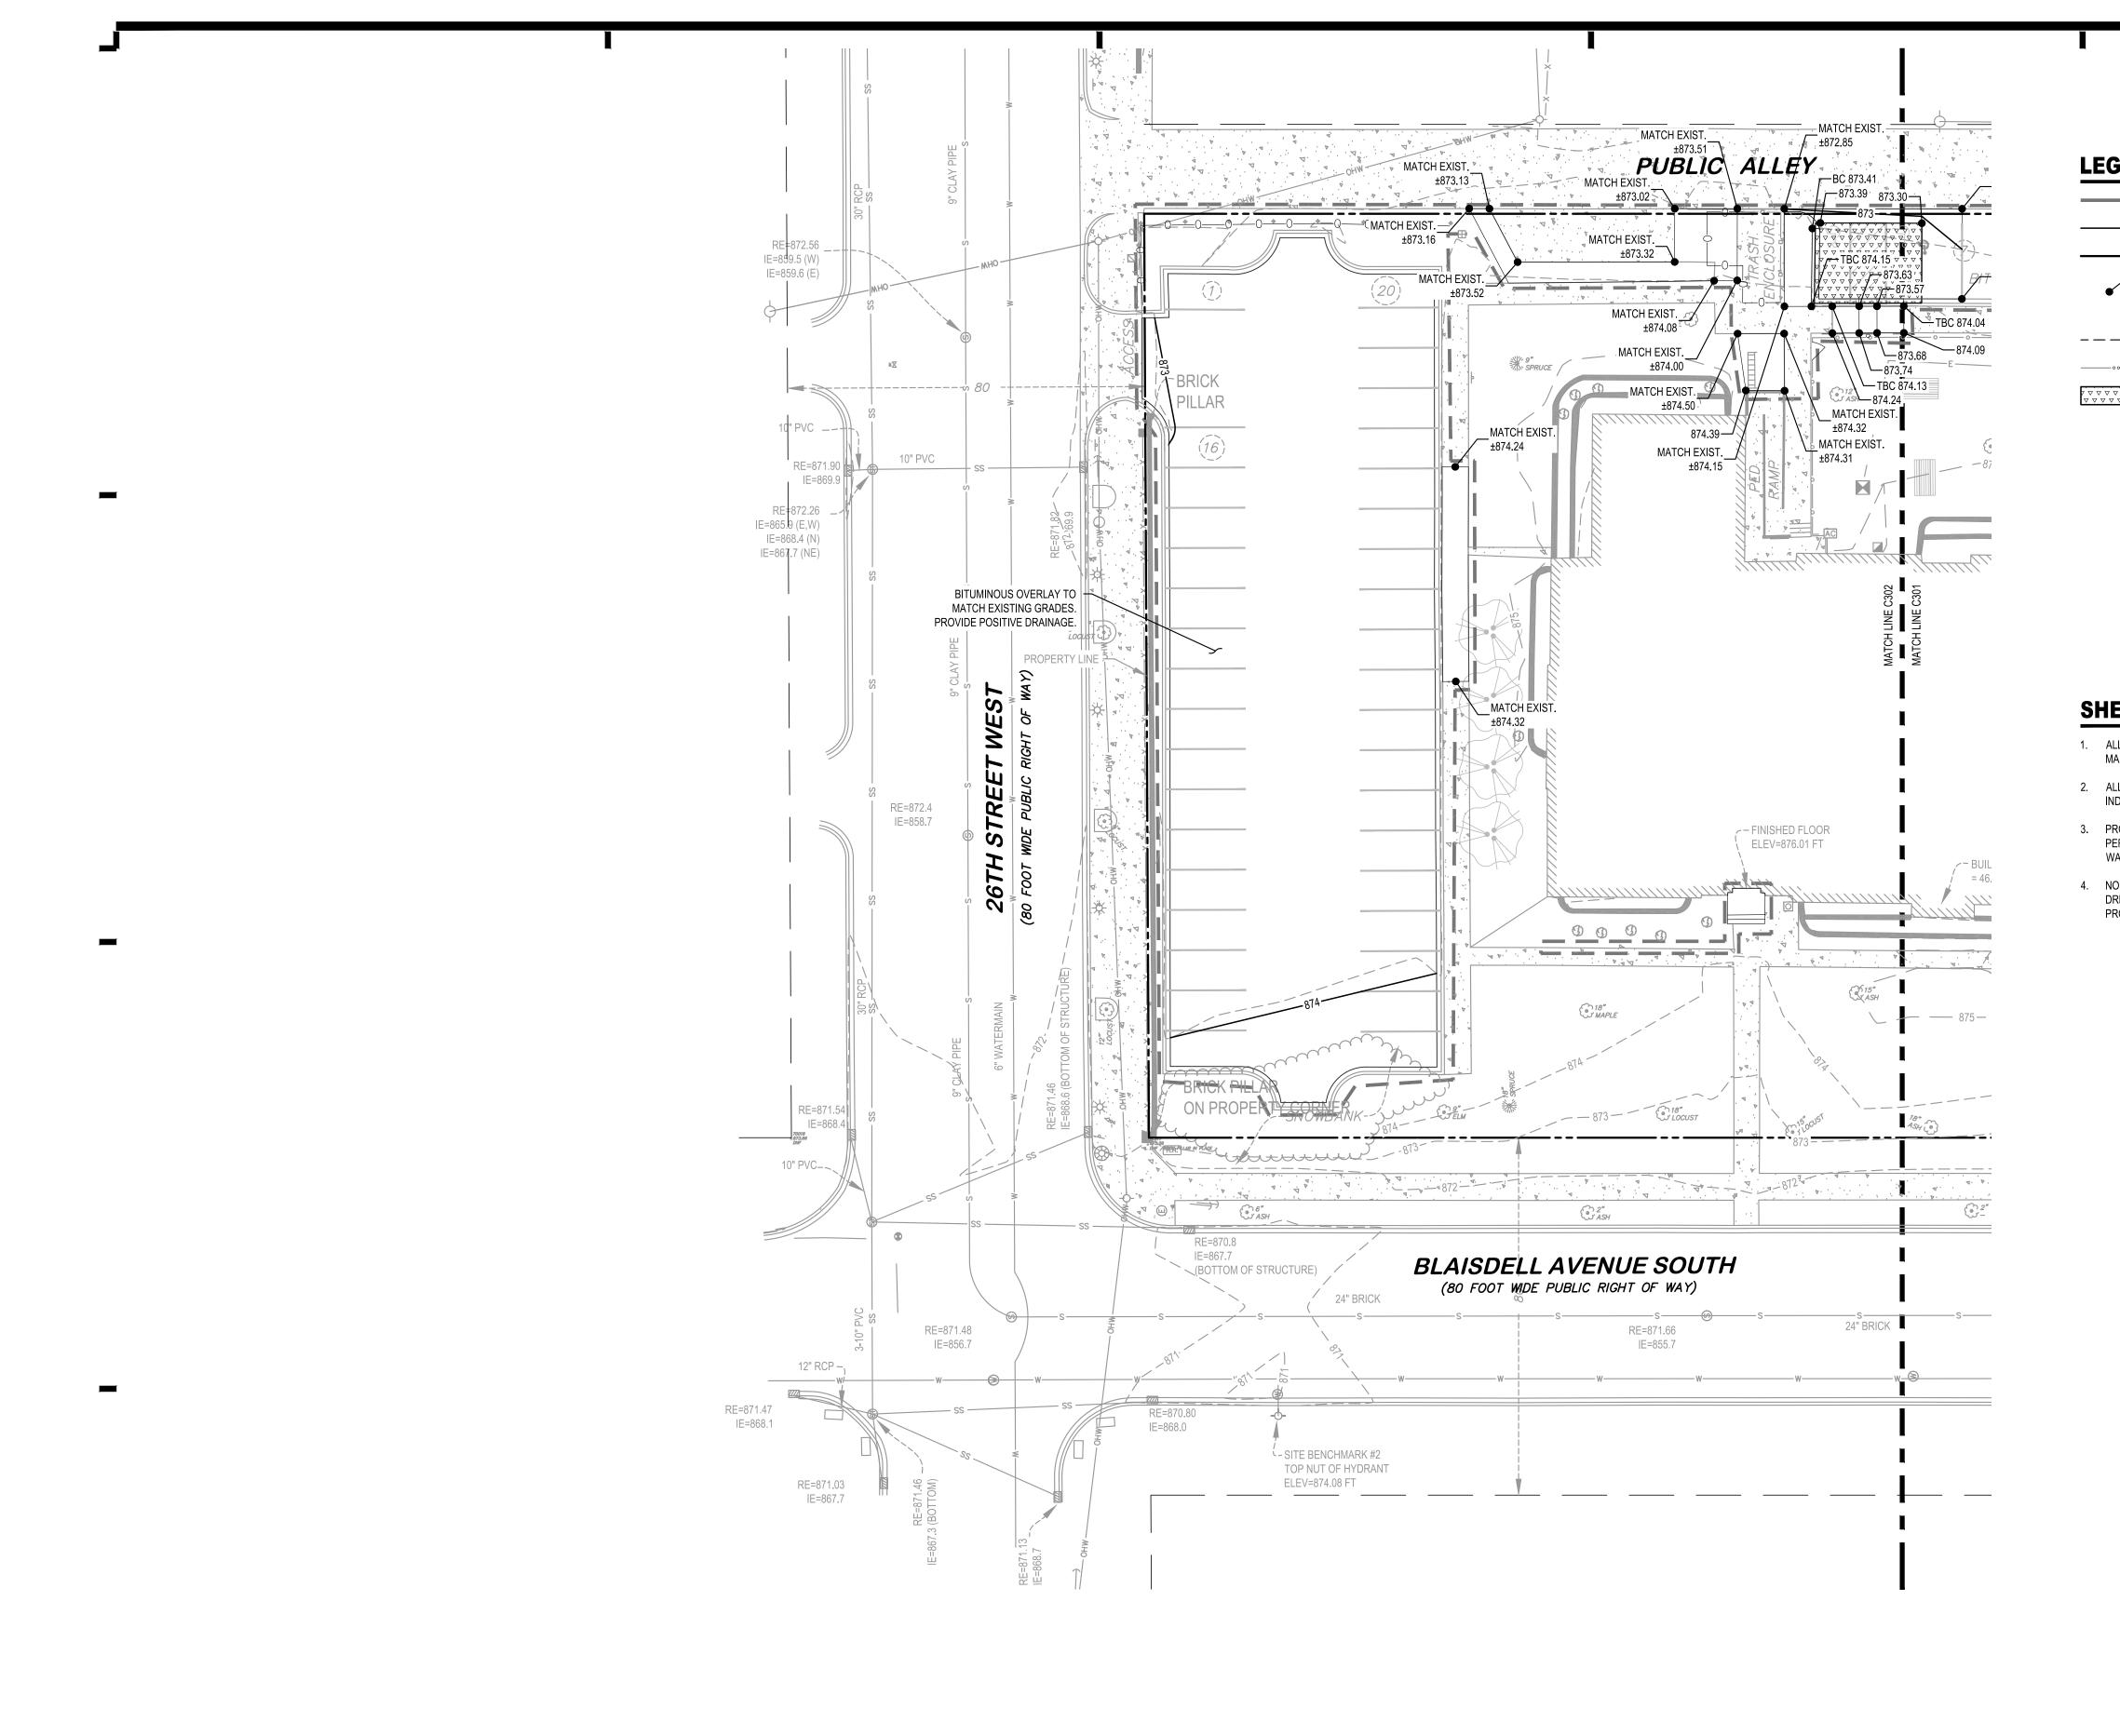

# LEGEND

	CONSTRUCTION LIMITS
	MINOR CONTOUR
870	MAJOR CONTOUR
872.25	SPOT ELEVATION
<b>—</b> ►	DRAINAGE ARROW
	GRADE BREAK
000	SWALE
~ ~ ~ ~ ~ ~ ~ ~ ~ ~ ~ ~ ~ ~ ~ ~ ~ ~ ~	ADA CRITICAL AREA (2% MAX. SLOPE ANY DIRECTION)
®1	APPROXIMATE SOIL BORING LOCATION SEE SHEET NOTE 4

CITY OF MINNEAPOLIS APPROVAL STAMP:



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# **SHEET NOTES**


1. ALL GRADES SHOWN IN THE DRAWINGS ARE TO FINISH GRADE. THE CONTRACTOR SHALL MAKE THE APPROPRIATE DEDUCTIONS FOR VARYING SUBGRADE ELEVATIONS.

2. ALL DISTURBED AREAS SHALL BE FINISHED WITH 4 INCHES OF TOPSOIL UNLESS INDICATED OTHERWISE. REFER TO LANDSCAPE FOR SEEDING.

3. PROJECT SITE DISTURBANCE FOR THE PRIVATE PROPERTY IS LESS THAN ONE ACRE SO PERMANENT STORMWATER MANAGEMENT IS NOT REQUIRED PER CHAPTER 54 STORM WATER MANAGEMENT OF THE CITY CODE.

4. NO GROUNDWATER OBSERVED DURING DRILLING OR AT THE TIME OF COMPLETION OF DRILLING OPERATIONS IN THE BORINGS. REFER TO THE GEOTECHNICAL REPORT PROVIDED BY INTERTEK-PSI DATED MARCH 11, 2021.

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**GRADING PLAN** 

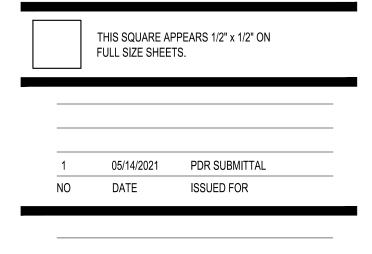 $\leftarrow$ 

0 10' 20'


# WARNING

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FILE: ...\180586\600 Drawings\C\180586 C301 Grading Plan.dwg DRAWN BY: MJJ CHECKED BY: MMW PROJ. NO: 180586 DRAWING NO:

DRAWING TITLE:



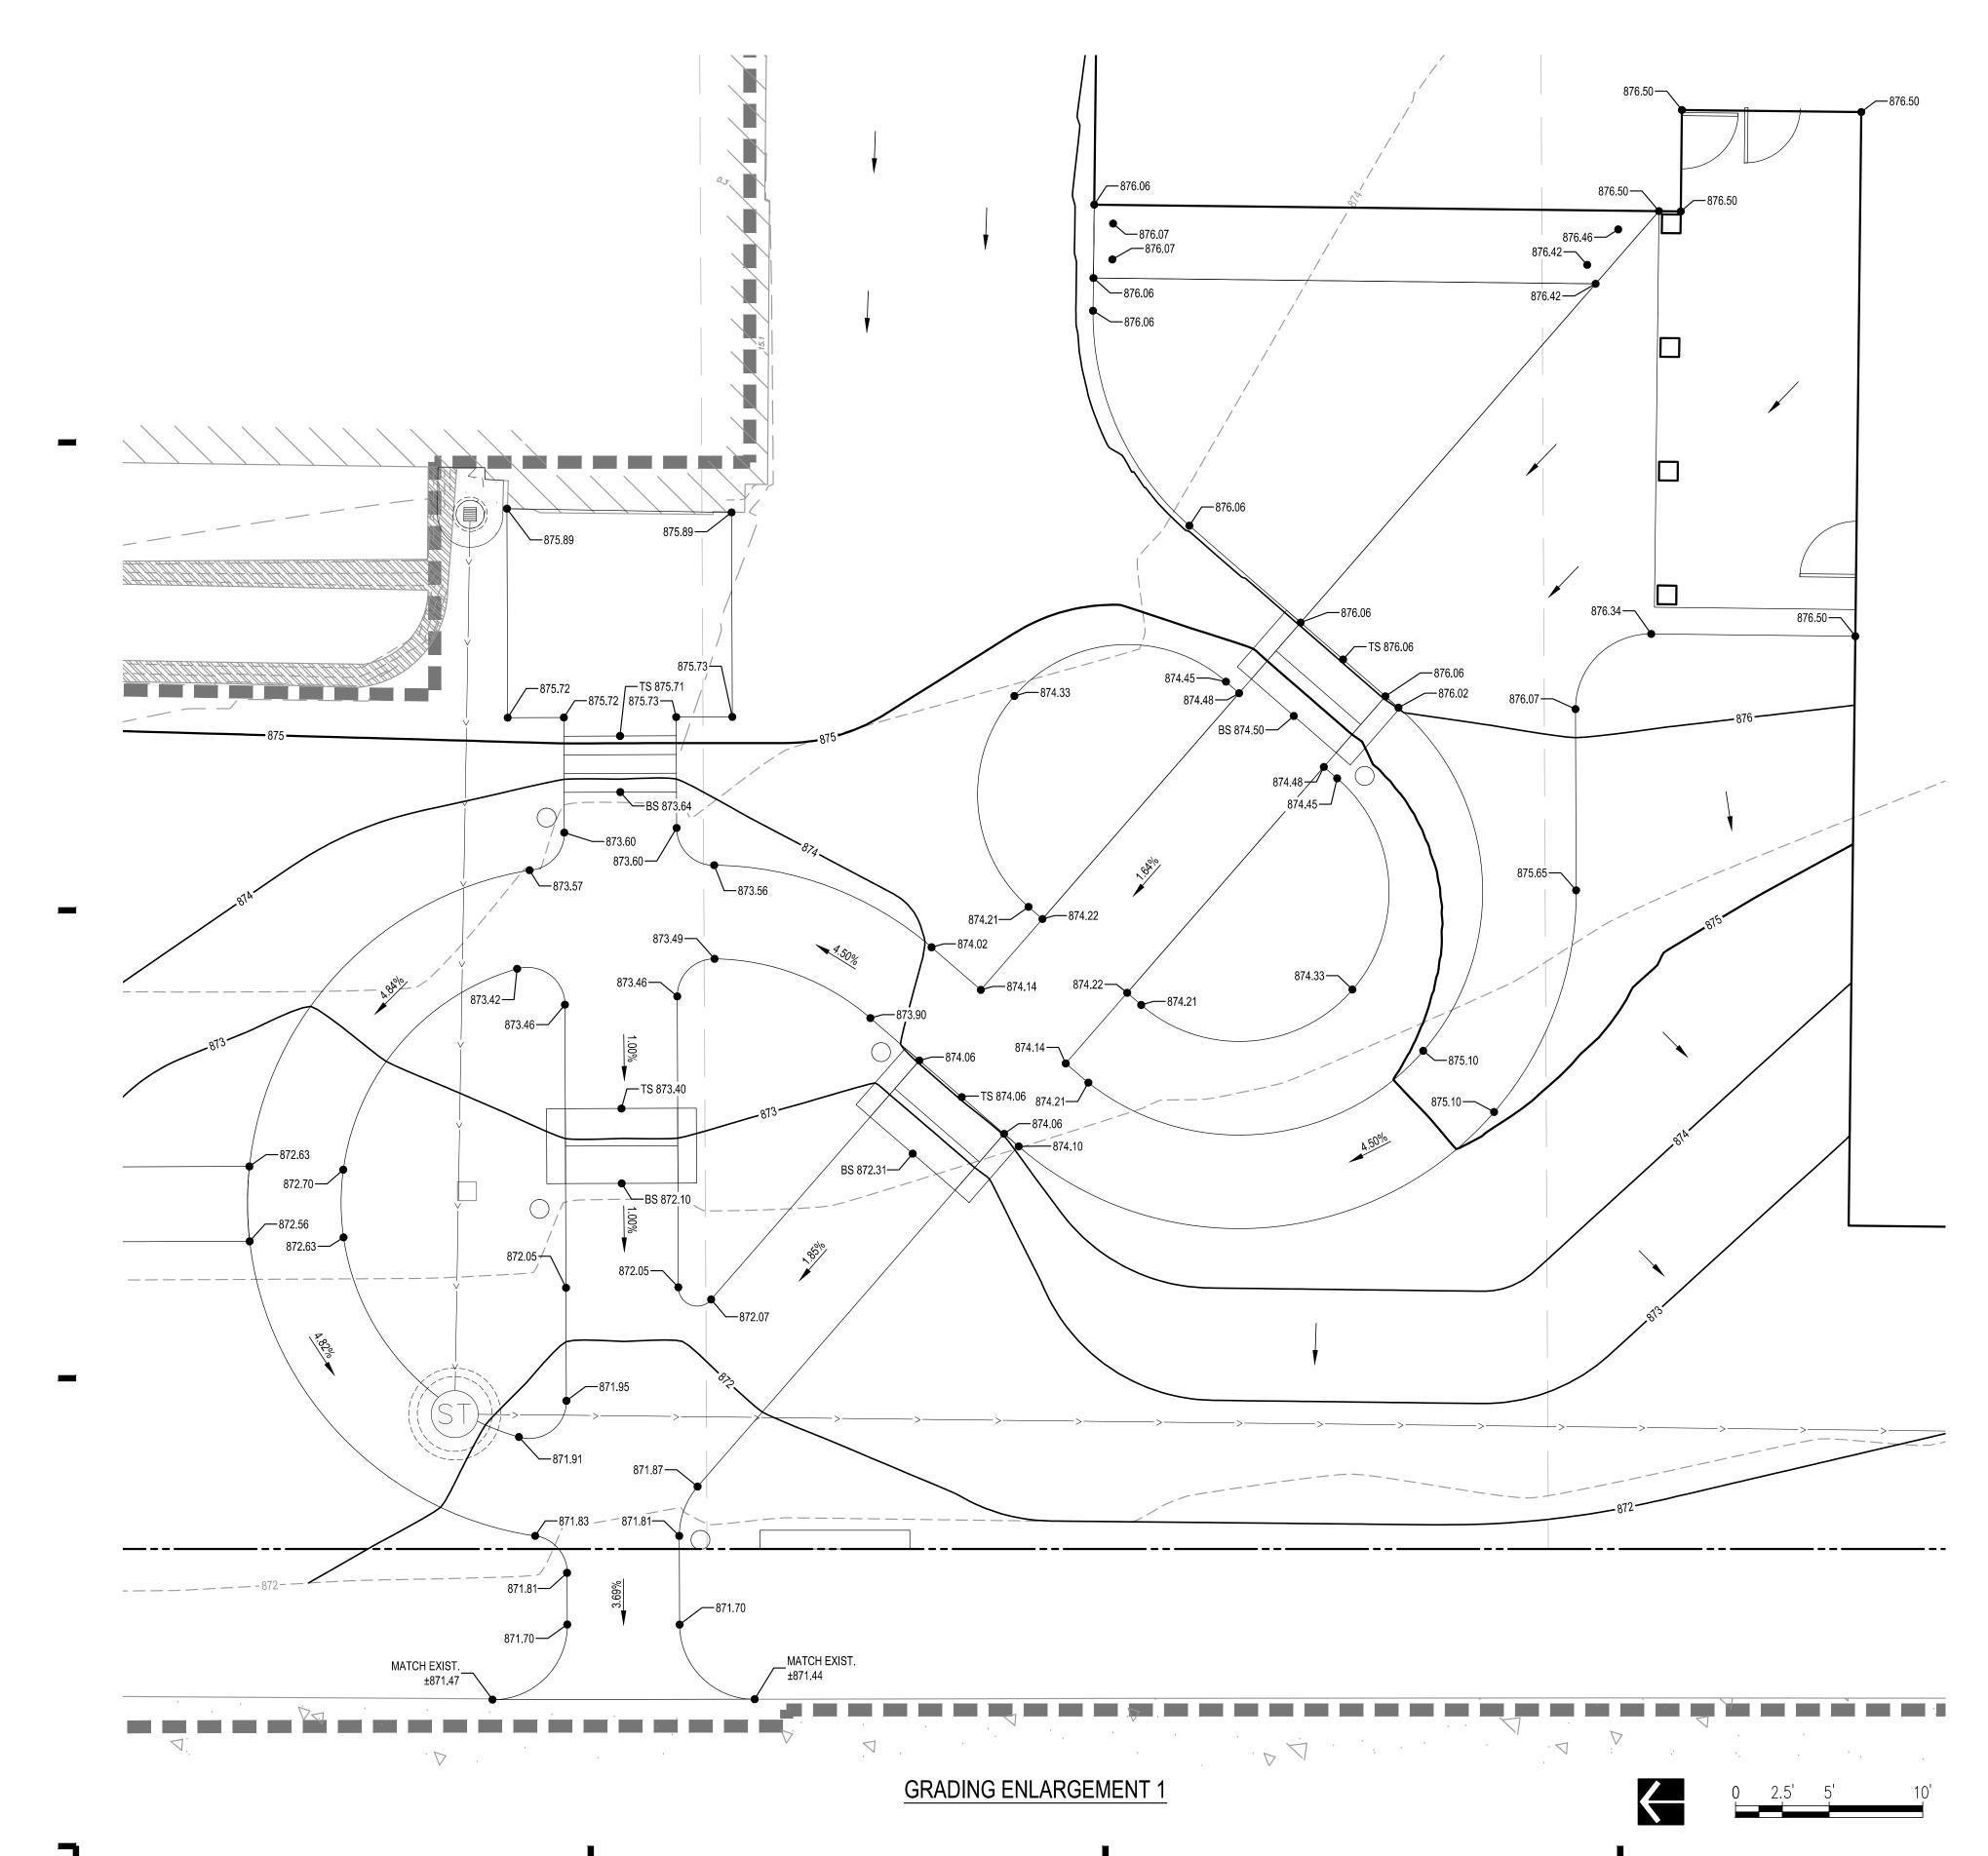

CITY OF MINNEAPOLIS APPROVAL STAMP:




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WARNING

LOCATION OF UNDERGROUND UTILITIES TO

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1-800-252-1166 REQUIRED BY LAW

ENLARGEMENT

GRADING

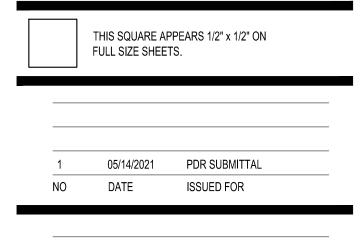DRAWN BY: MJJ

CHECKED BY: MMW

PROJ. NO: 180586


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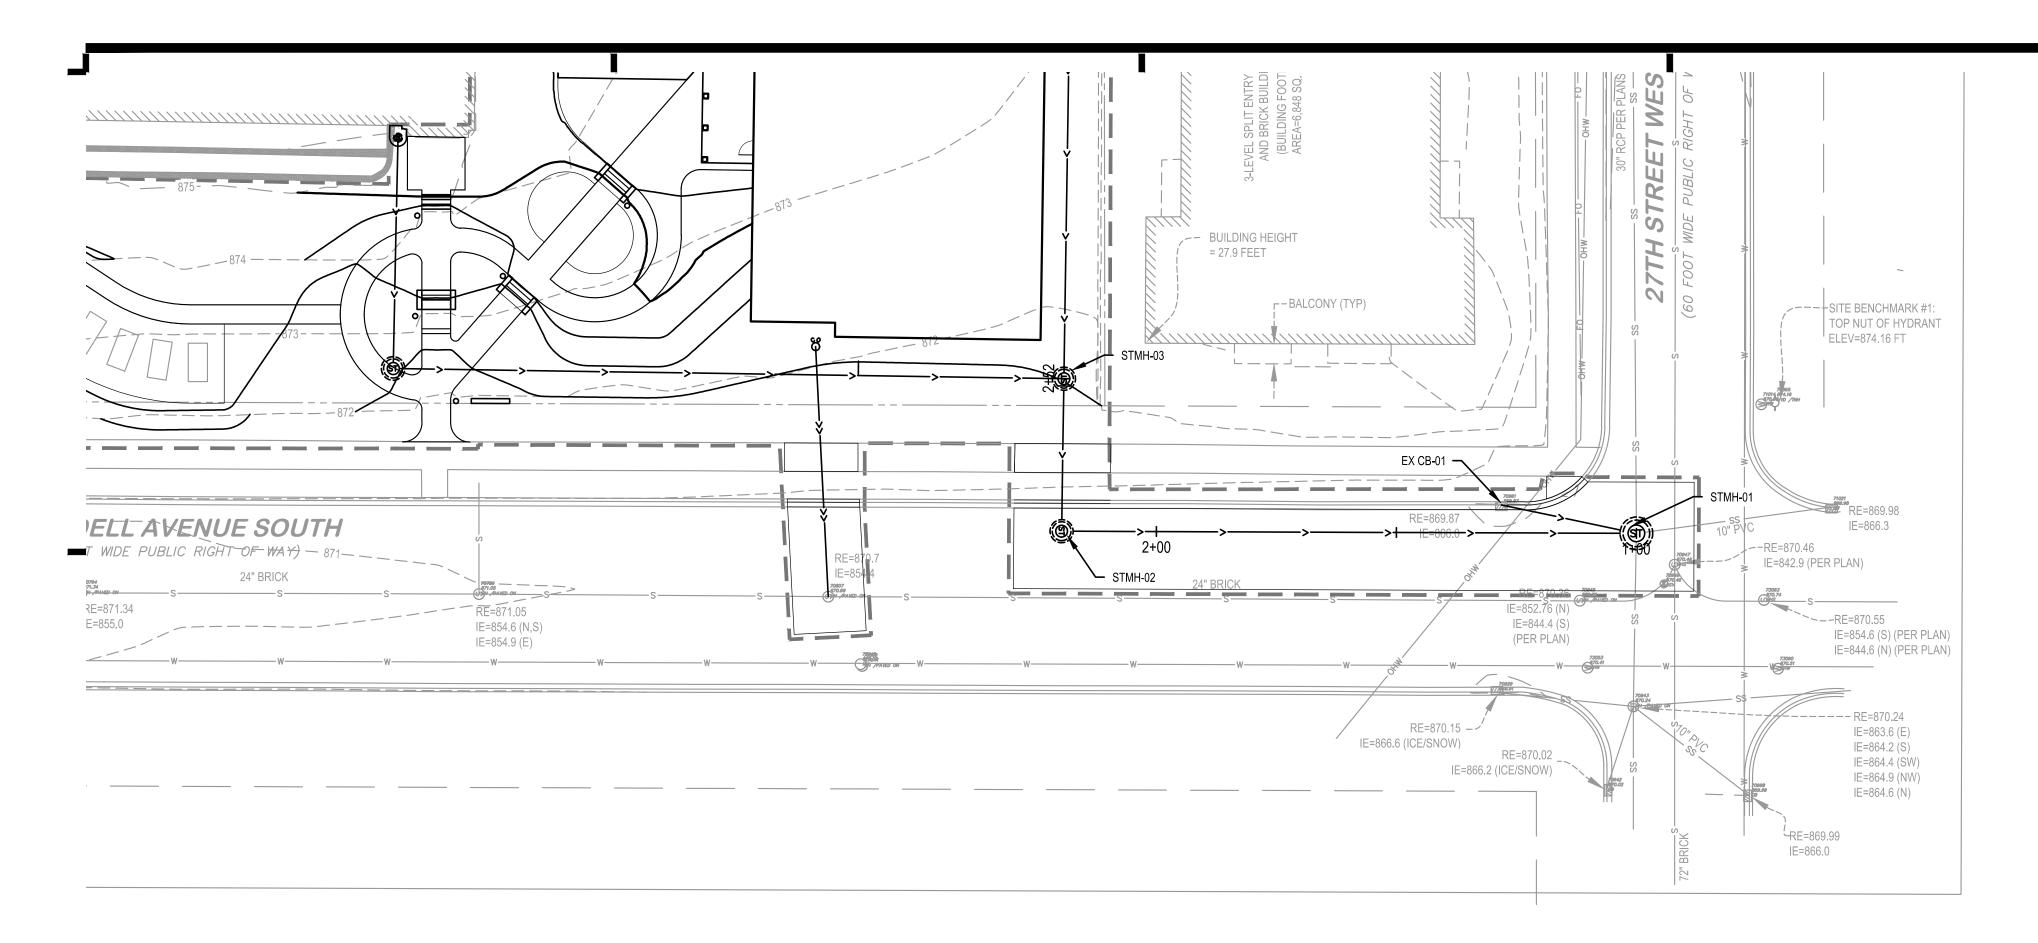
MINNEAPOLIS, MN 55408


FILE: ...\180586\600 Drawings\C\180586 C311 Grading Enlargements.dwg

**C**311

DRAWING TITLE:



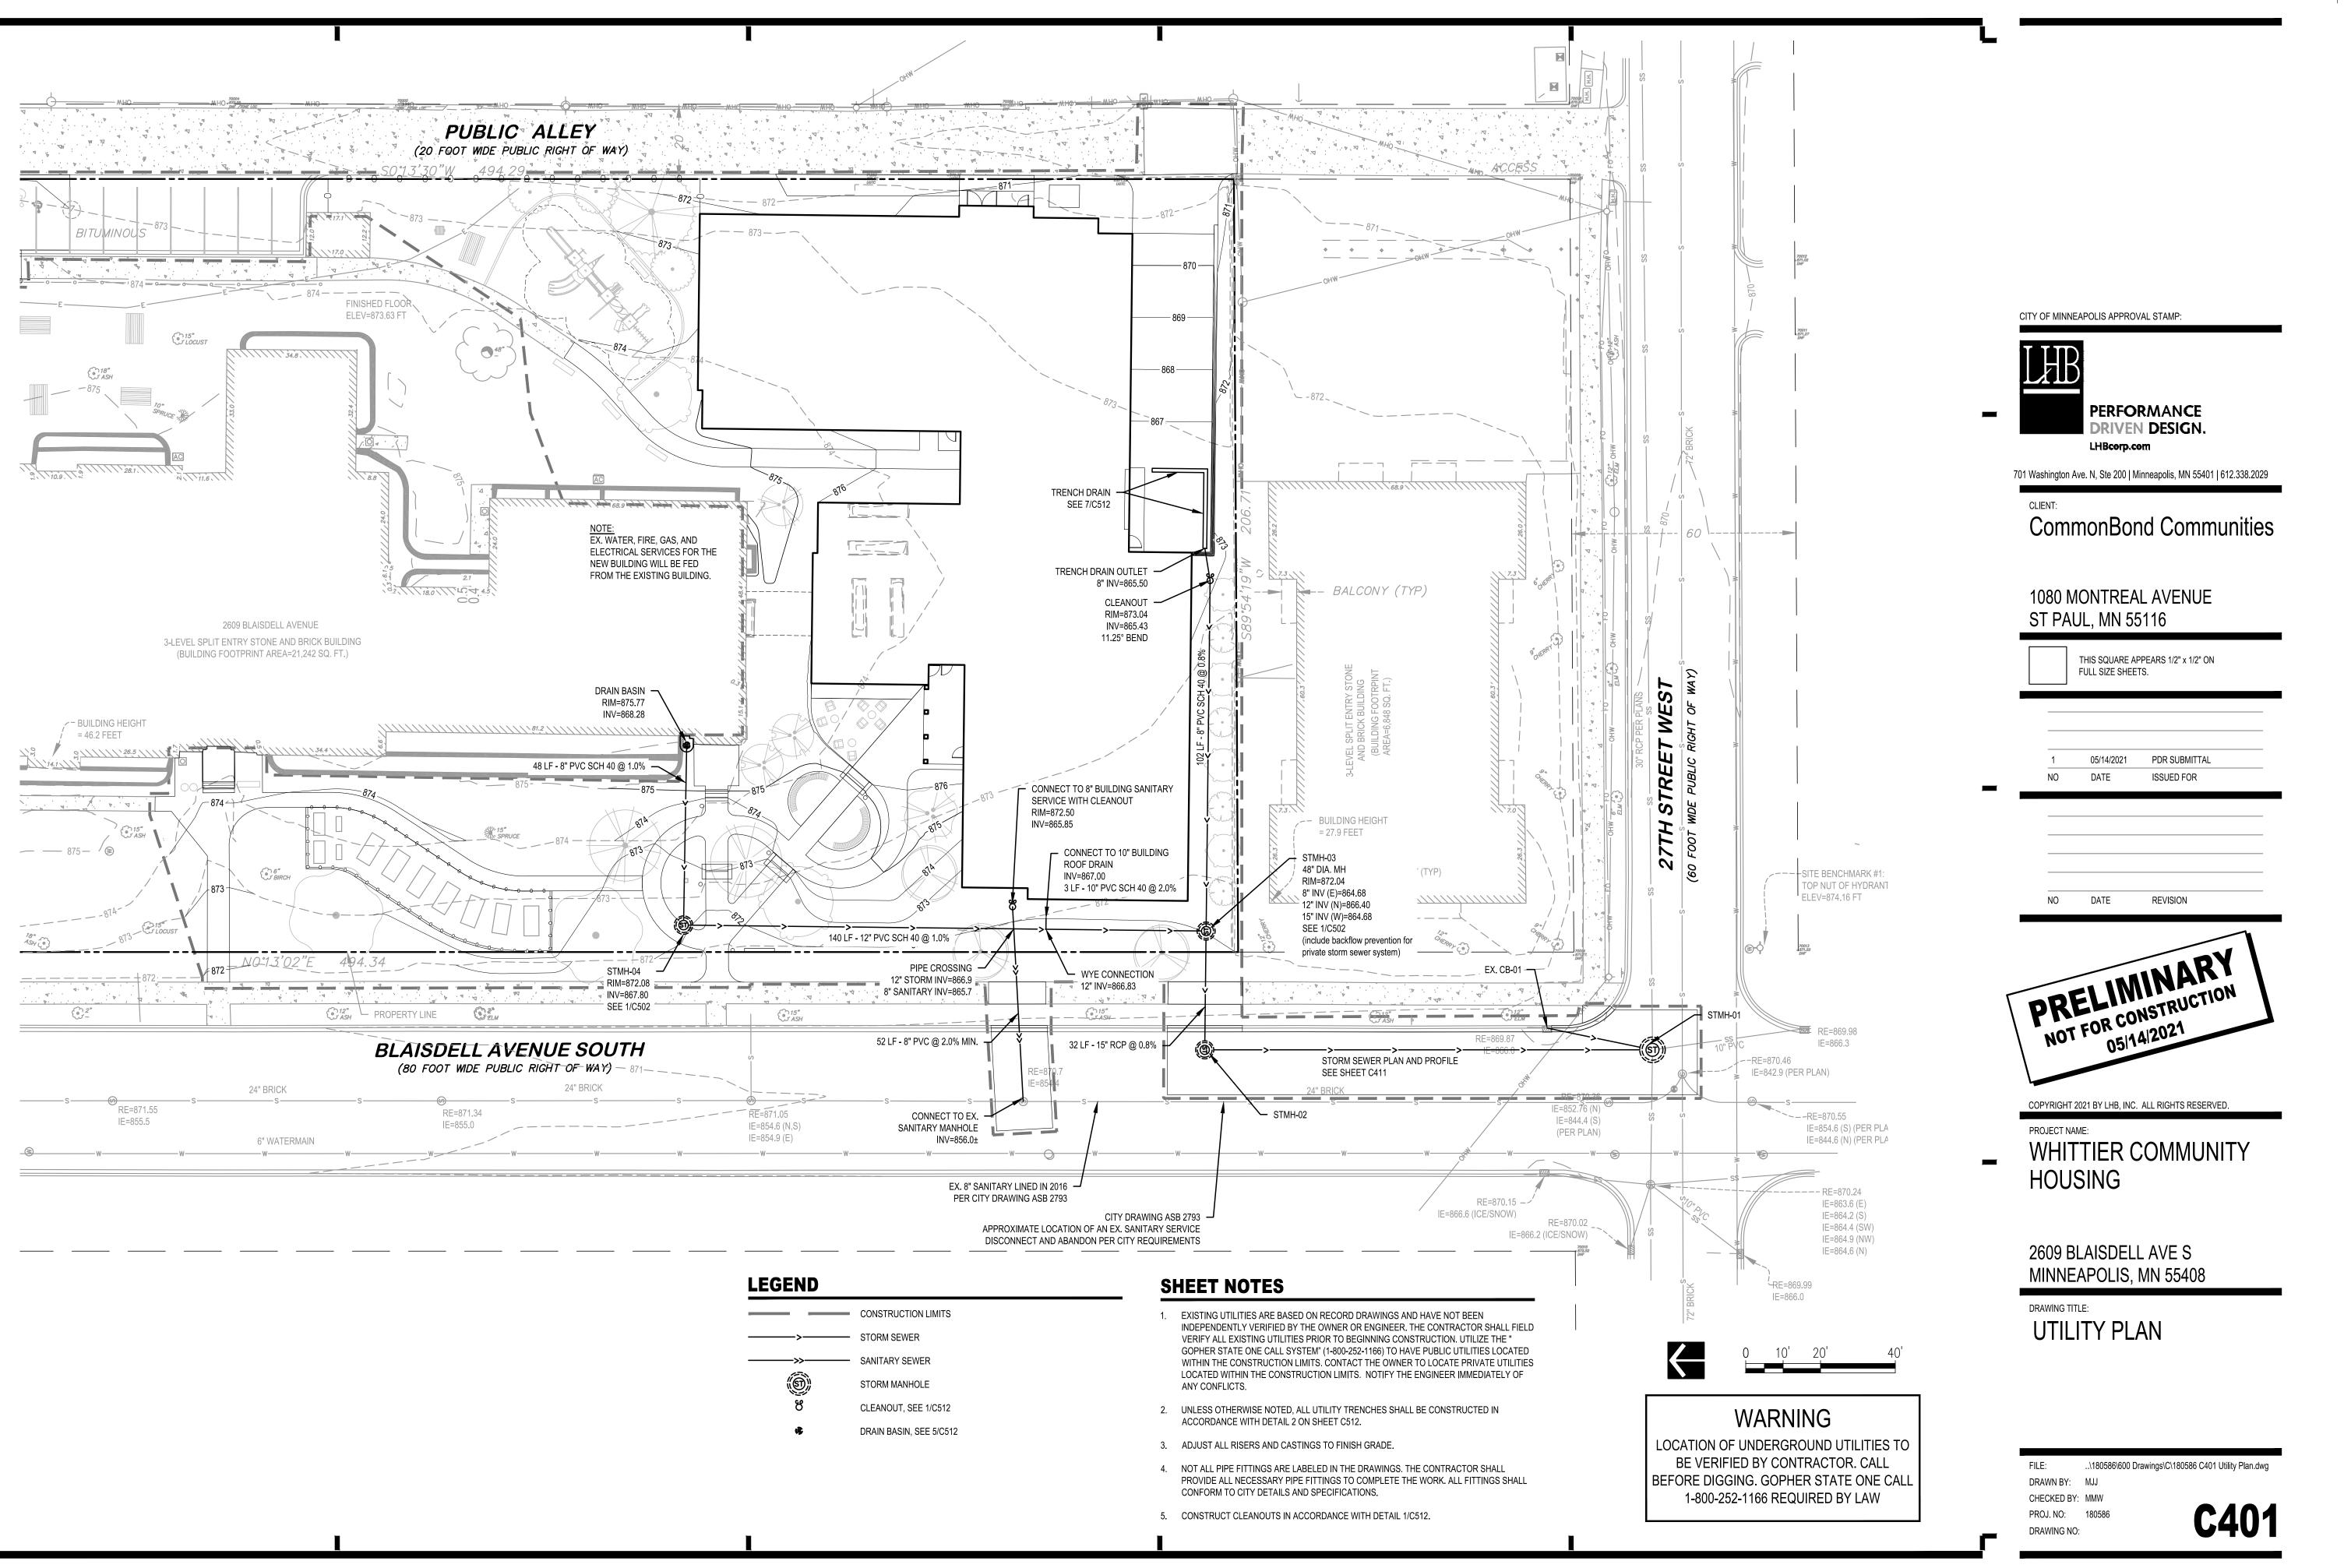

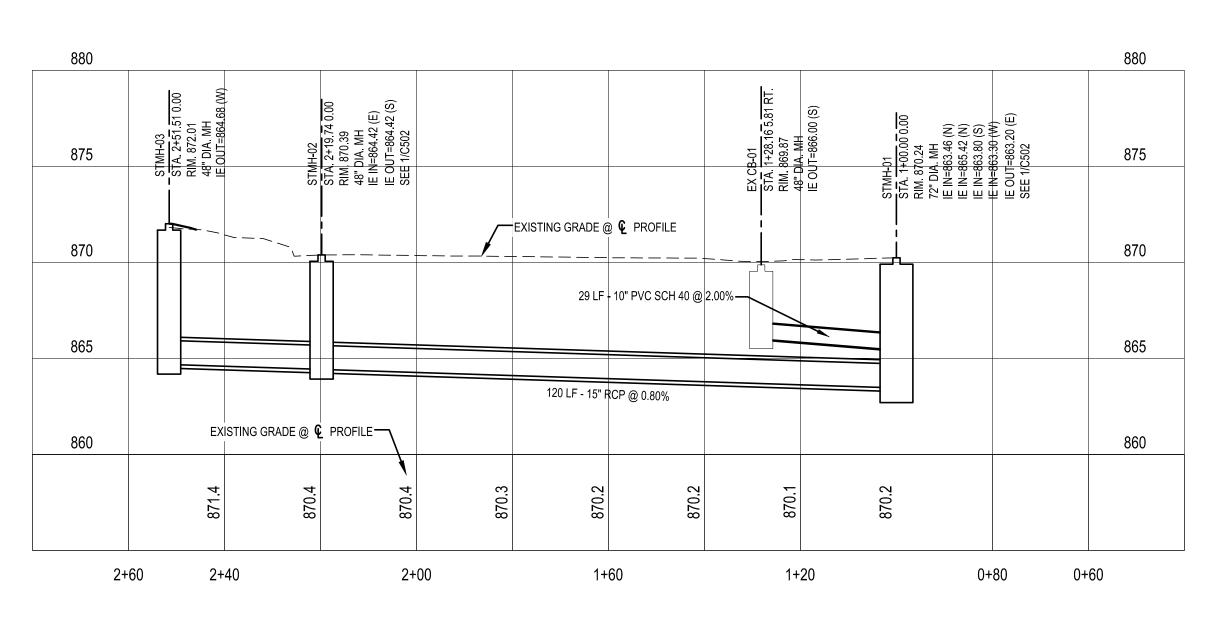

CITY OF MINNEAPOLIS APPROVAL STAMP:




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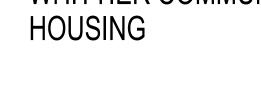
NO DATE REVISION



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PROJECT NAME: WHITTIER COMMUNITY




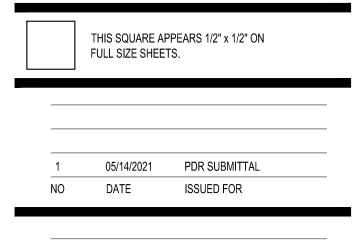

2609 BLAISDELL AVE S MINNEAPOLIS, MN 55408


DRAWING TITLE: STORM SEWER PLAN & PROFILE

FILE: ...\180586\600 Drawings\C\180586 C411 Storm Sewer Plan & Profile.dwg DRAWN BY: MJJ CHECKED BY: MMW C411 PROJ. NO: 180586 DRAWING NO:

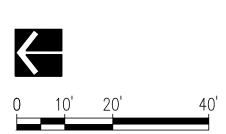

# WARNING

LOCATION OF UNDERGROUND UTILITIES TO BE VERIFIED BY CONTRACTOR. CALL BEFORE DIGGING. GOPHER STATE ONE CALL 1-800-252-1166 REQUIRED BY LAW

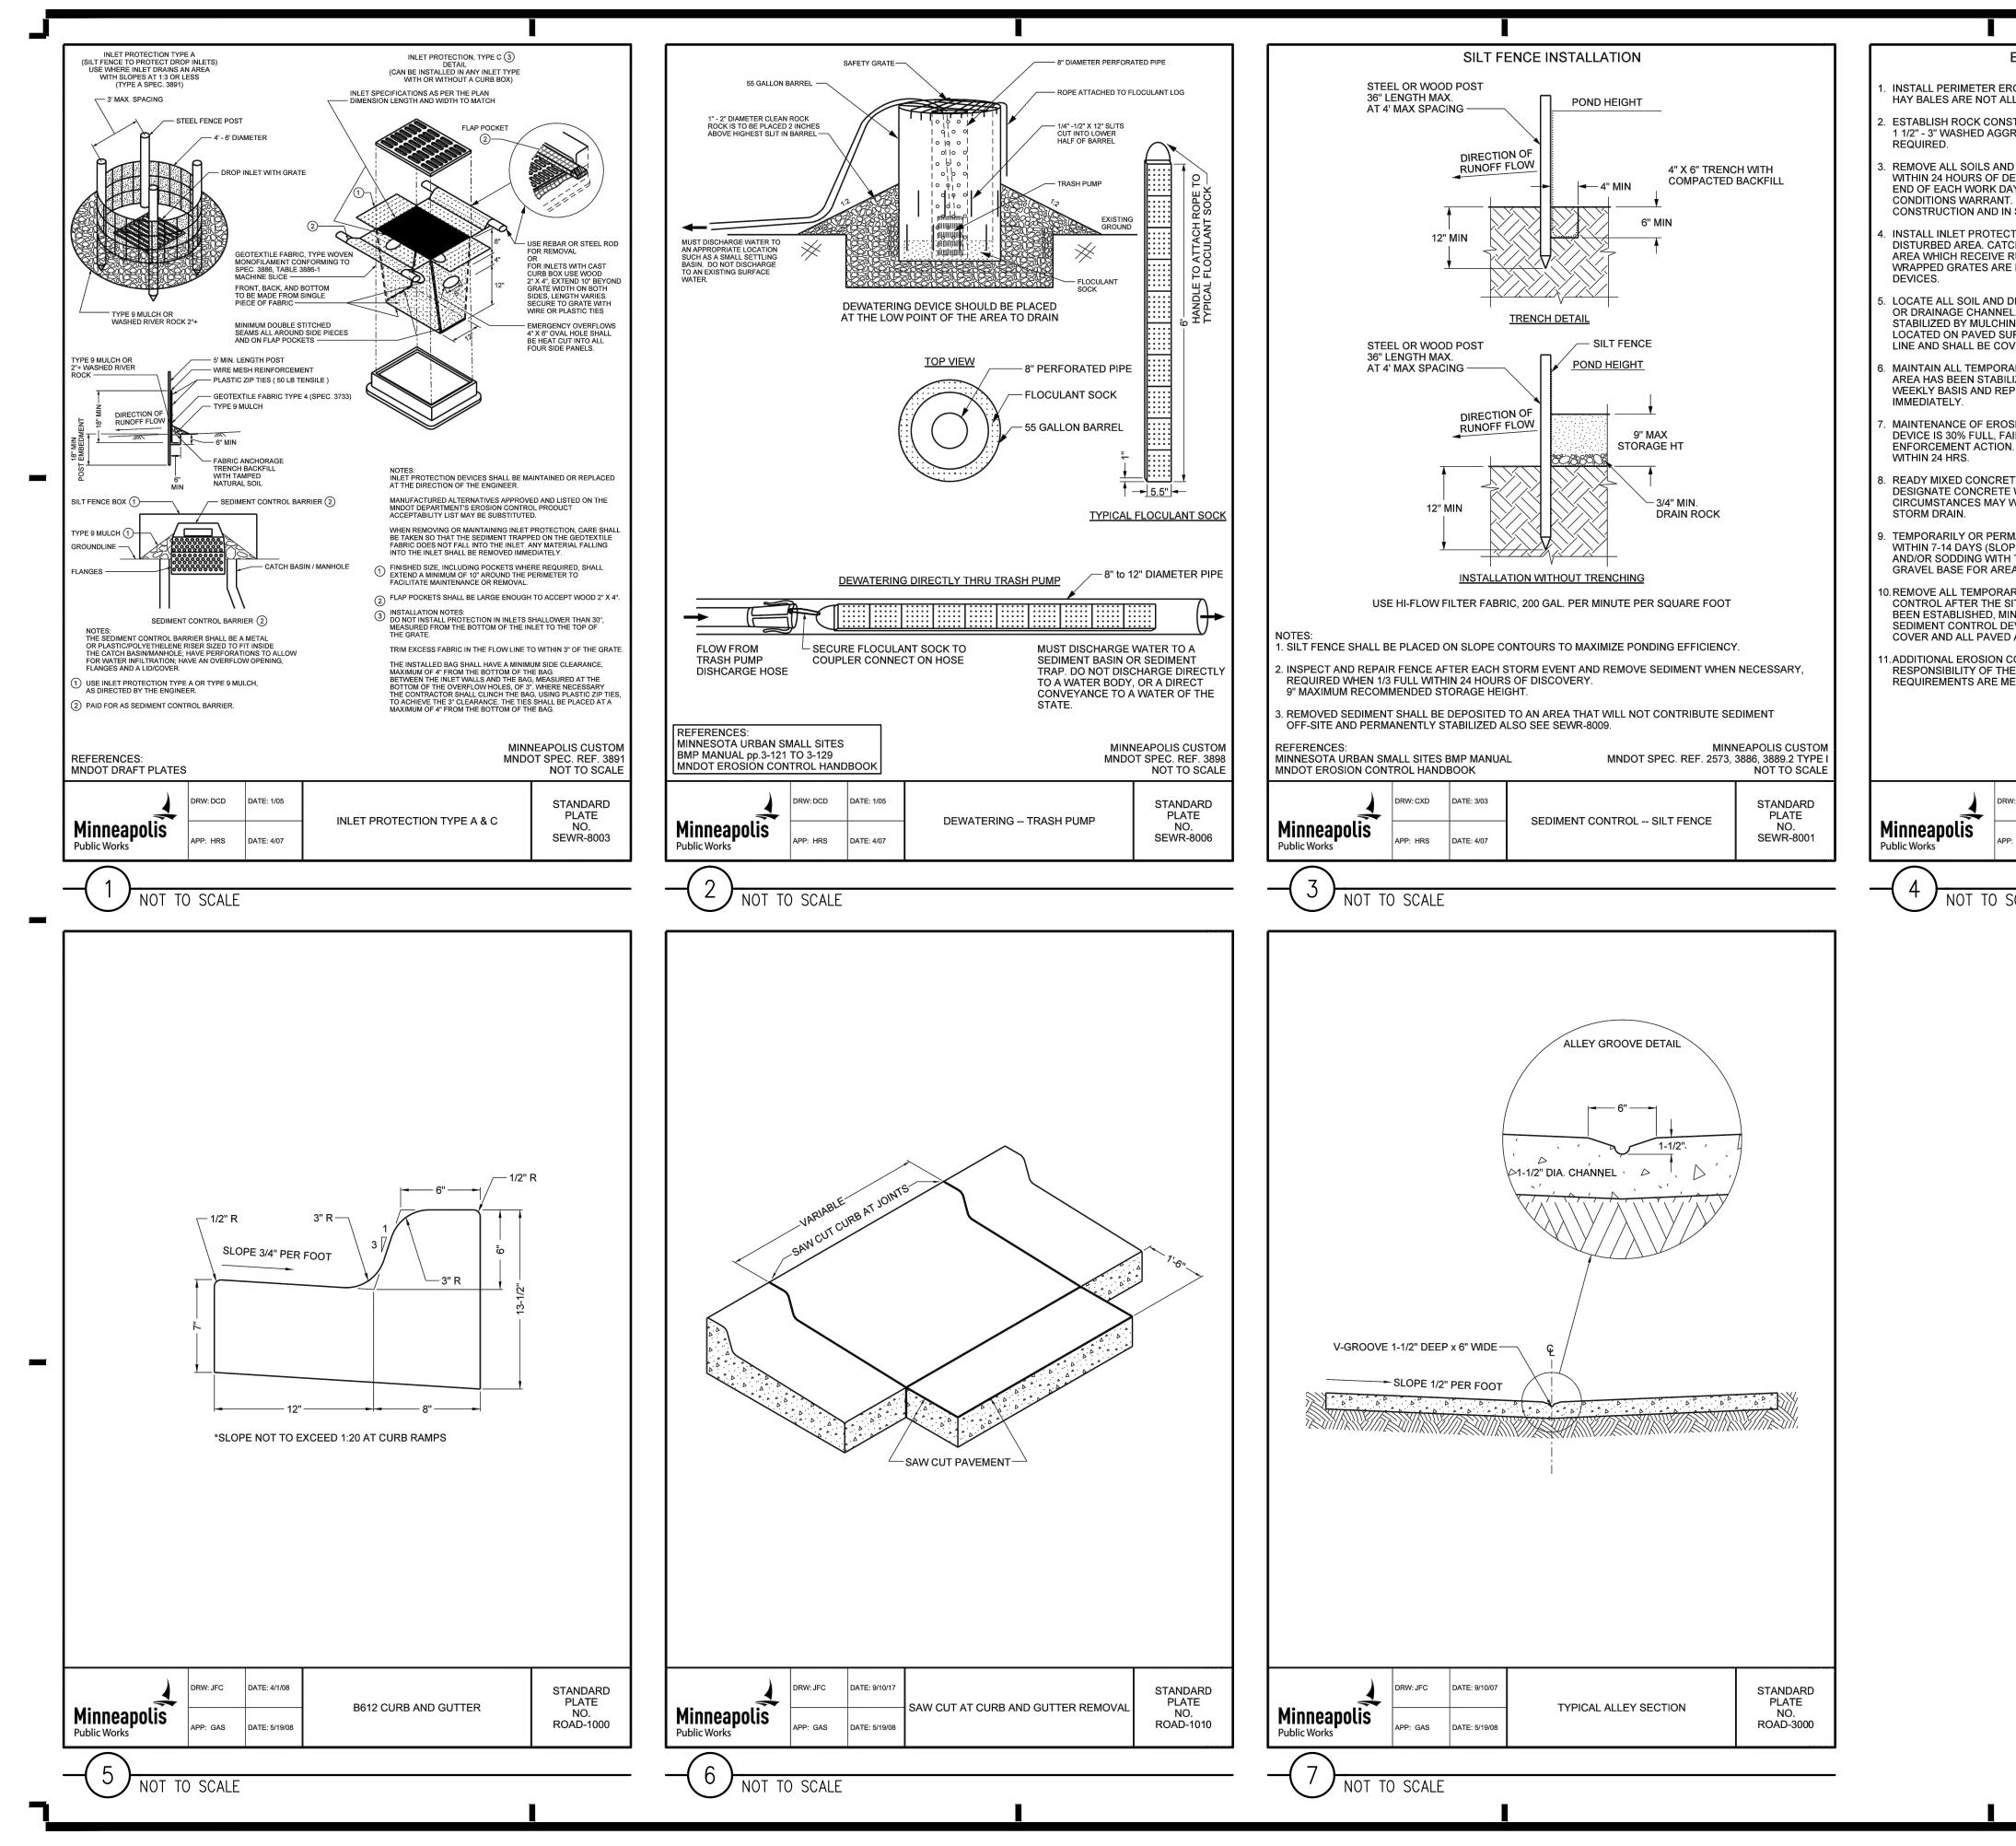

EROS	SION AND	SEDIMENT CONTROL NOTES					
		AS INDICATED IN PLANS PRIOR TO START ( N & SEDIMENT CONTROL DEVICE IN MINNE					
		CES PRIOR TO BEGINNING LAND DISTURBI IENDED FOR ROCK ENTRANCES, A GEOTE					
EPOSIT AY WHE . SWEE	ION. REMOVA N TRACKING PING SHALL I	SITED ONTO PUBLIC AND/OR PRIVATE PAV AL OF TRACKING MATERIALS SHALL BE CO OCCURS. SWEEPING MAY BE ORDERED A BE MAINTAINED THROUGHOUT THE DURAT O PREVENT DUST BEING BLOWN TO ADJAC	MPLETED AT THE T ANY TIME IF FION OF				
CH BAS RUNOF	IN INSERTS A	TREAM CATCH BASINS WHICH RECEIVE RU ARE REQUIRED AT ALL LOCATIONS NOT WI PE C INLET PROTECTION). NOTE HAY BALE ID ARE NOT APPROVED FOR USE AS INLET	THIN THE DISTURBED ES AND SILT FENCE				
L. ALL S NG, VE JRFACE	STOCK PILES GETATIVE CO	THAN 25 FEET FROM ANY PUBLIC OR PRIV THAT REMAIN IN PLACE FOR 7 DAYS OR M OVER, TARPING OR OTHER MEANS. TEMPO IN LEAST 2 FEET OR MORE AWAY FROM TH G MORE THAN 24 HOURS.	ORE SHALL BE RARY STOCK PILES				
		ROL DEVICES IN PLACE UNTIL THE CONTR		CITY O	F MINNEAPOLIS APPRO	OVAL STAMP:	
SION AI	ND SEDIMENT TO MAINTAIN	ED, DAMAGED OR ROTTED EROSION CONT CONTROL DEVICES SHALL BE PERFORME EROSION CONTROL DEVICES MAY LEAD T ONS REQUIRED AND AFTER EACH 1/2" OR	ED WHENEVER THE O FURTHER		Æ		
TE AND	BATCH PLAN	NT WASHOUTS PROHIBITED WITHIN THE PL ING LOCATIONS IN THE EROSION CONTRO IRAIN ONTO THE PUBLIC RIGHT OF WAY OF	JBLIC RIGHT OF WAY, DL PLANS. UNDER NO	-	DRIVE	DRMANCE N DESIGN.	
PE DEP I TEMPO	ENDENT). US DRARY STAKI	E ALL DENUDED AREAS WHICH HAVE BEEN SE SEEDING AND MULCHING, EROSION CON ING IN GREEN SPACE AREAS. USE EARLY A OR PAVED SURFACING.	NTROL MATTING			Minneapolis, MN 55401   612.33	38.2029
SITE HA: INIMUM EVICES	S UNDERGON VEGETATION SHALL BE M/	RUCTURAL AND NON-BIODEGRADABLE ERC NE FINAL STABILIZATION AND PERMANENT N COVER OF 70% REQUIRED, ALL TEMPORA AINTAINED UNTIL THE SITE HAS 70% ESTAB STABILIZED WITH THE SELECTED PAVEME	VEGETATION HAS ARY EROSION AND BLISHED VEGETATIVE			nd Communi	ties
		EQUIRED BY OTHER PERMITTING AGENCIE ER TO VERIFY THAT THE CITY AND ALL OTH		_	80 MONTRE		
				SI	PAUL, MN 5	5116	
			IINNEAPOLIS CUSTOM NDOT SPEC. REF. 2573 NOT TO SCALE		THIS SQUARE /	APPEARS 1/2" x 1/2" ON	
W: DCD	DATE: 8/06		STANDARD			E13.	
P: HRS	DATE: 4/07	EROSION CONTROL NOTES	PLATE NO. SEWR-8007				
SCALE					1 05/14/2021 NO DATE	PDR SUBMITTAL	
				-			
					NO DATE	REVISION	
							1
						DY	
						NSTRUCTION 4/2021	
				\ P	RELING	NSTRUCTION	
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PROJECT NAME: WHITTIER COMMUNITY

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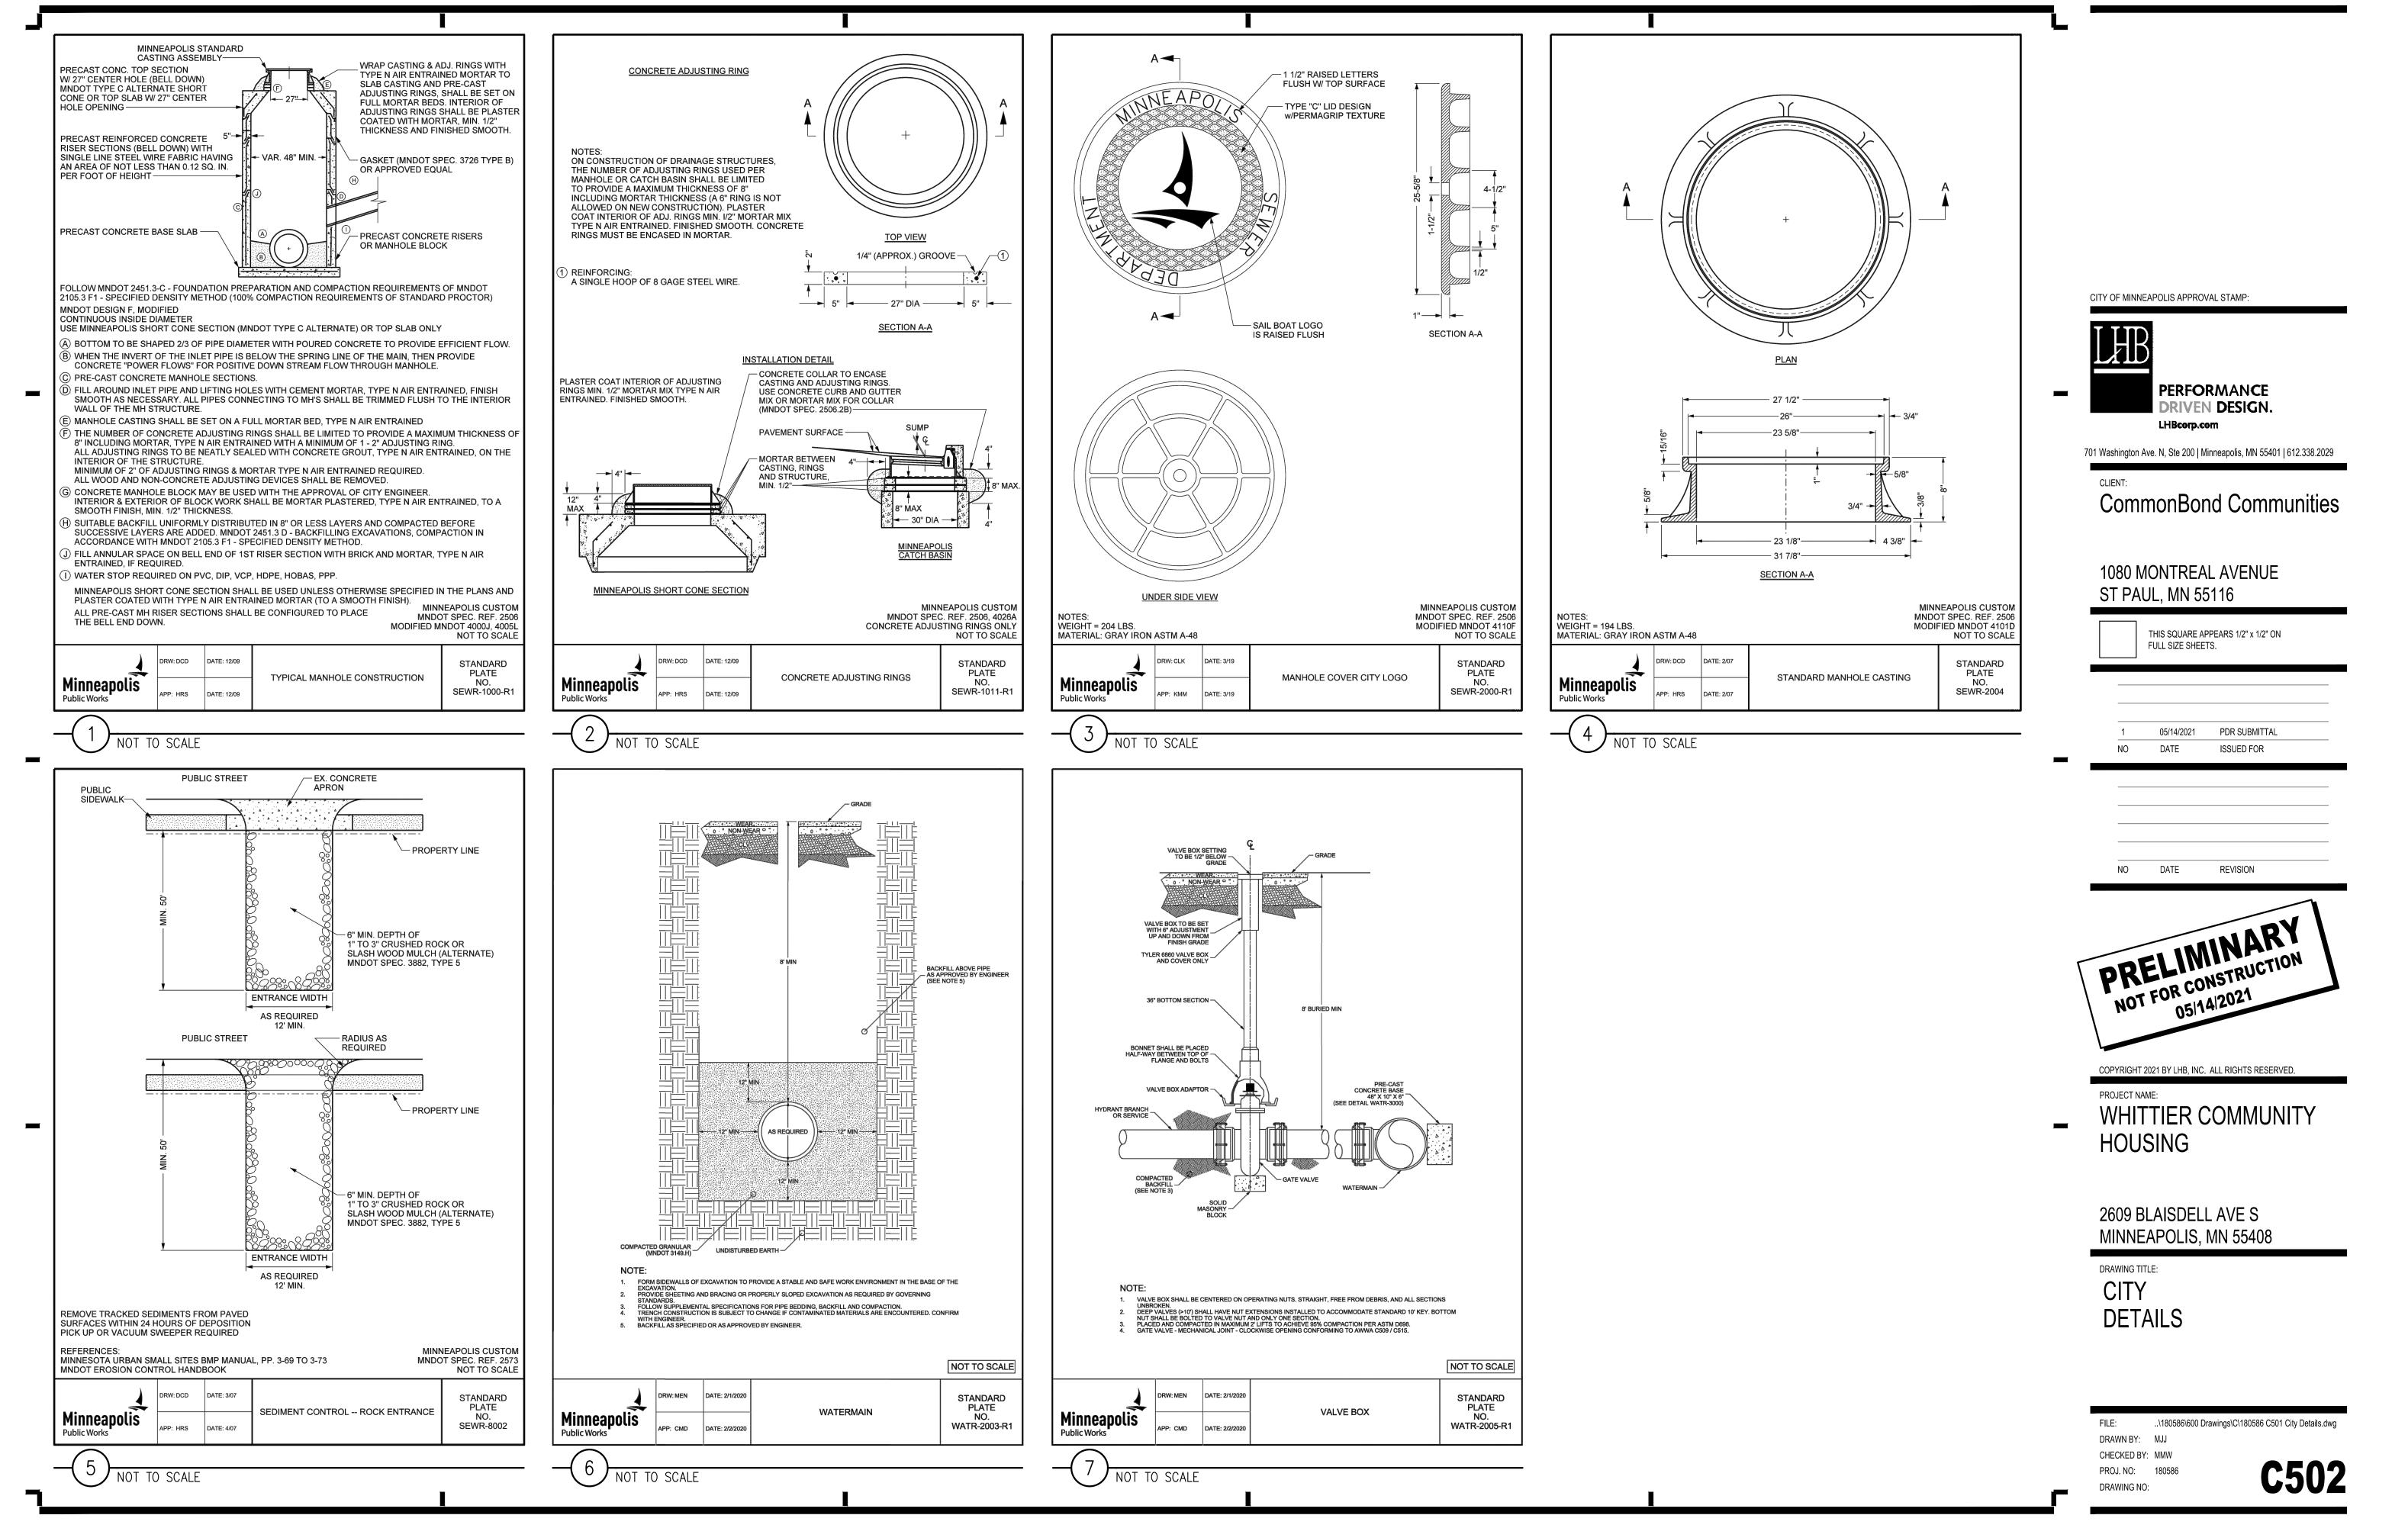
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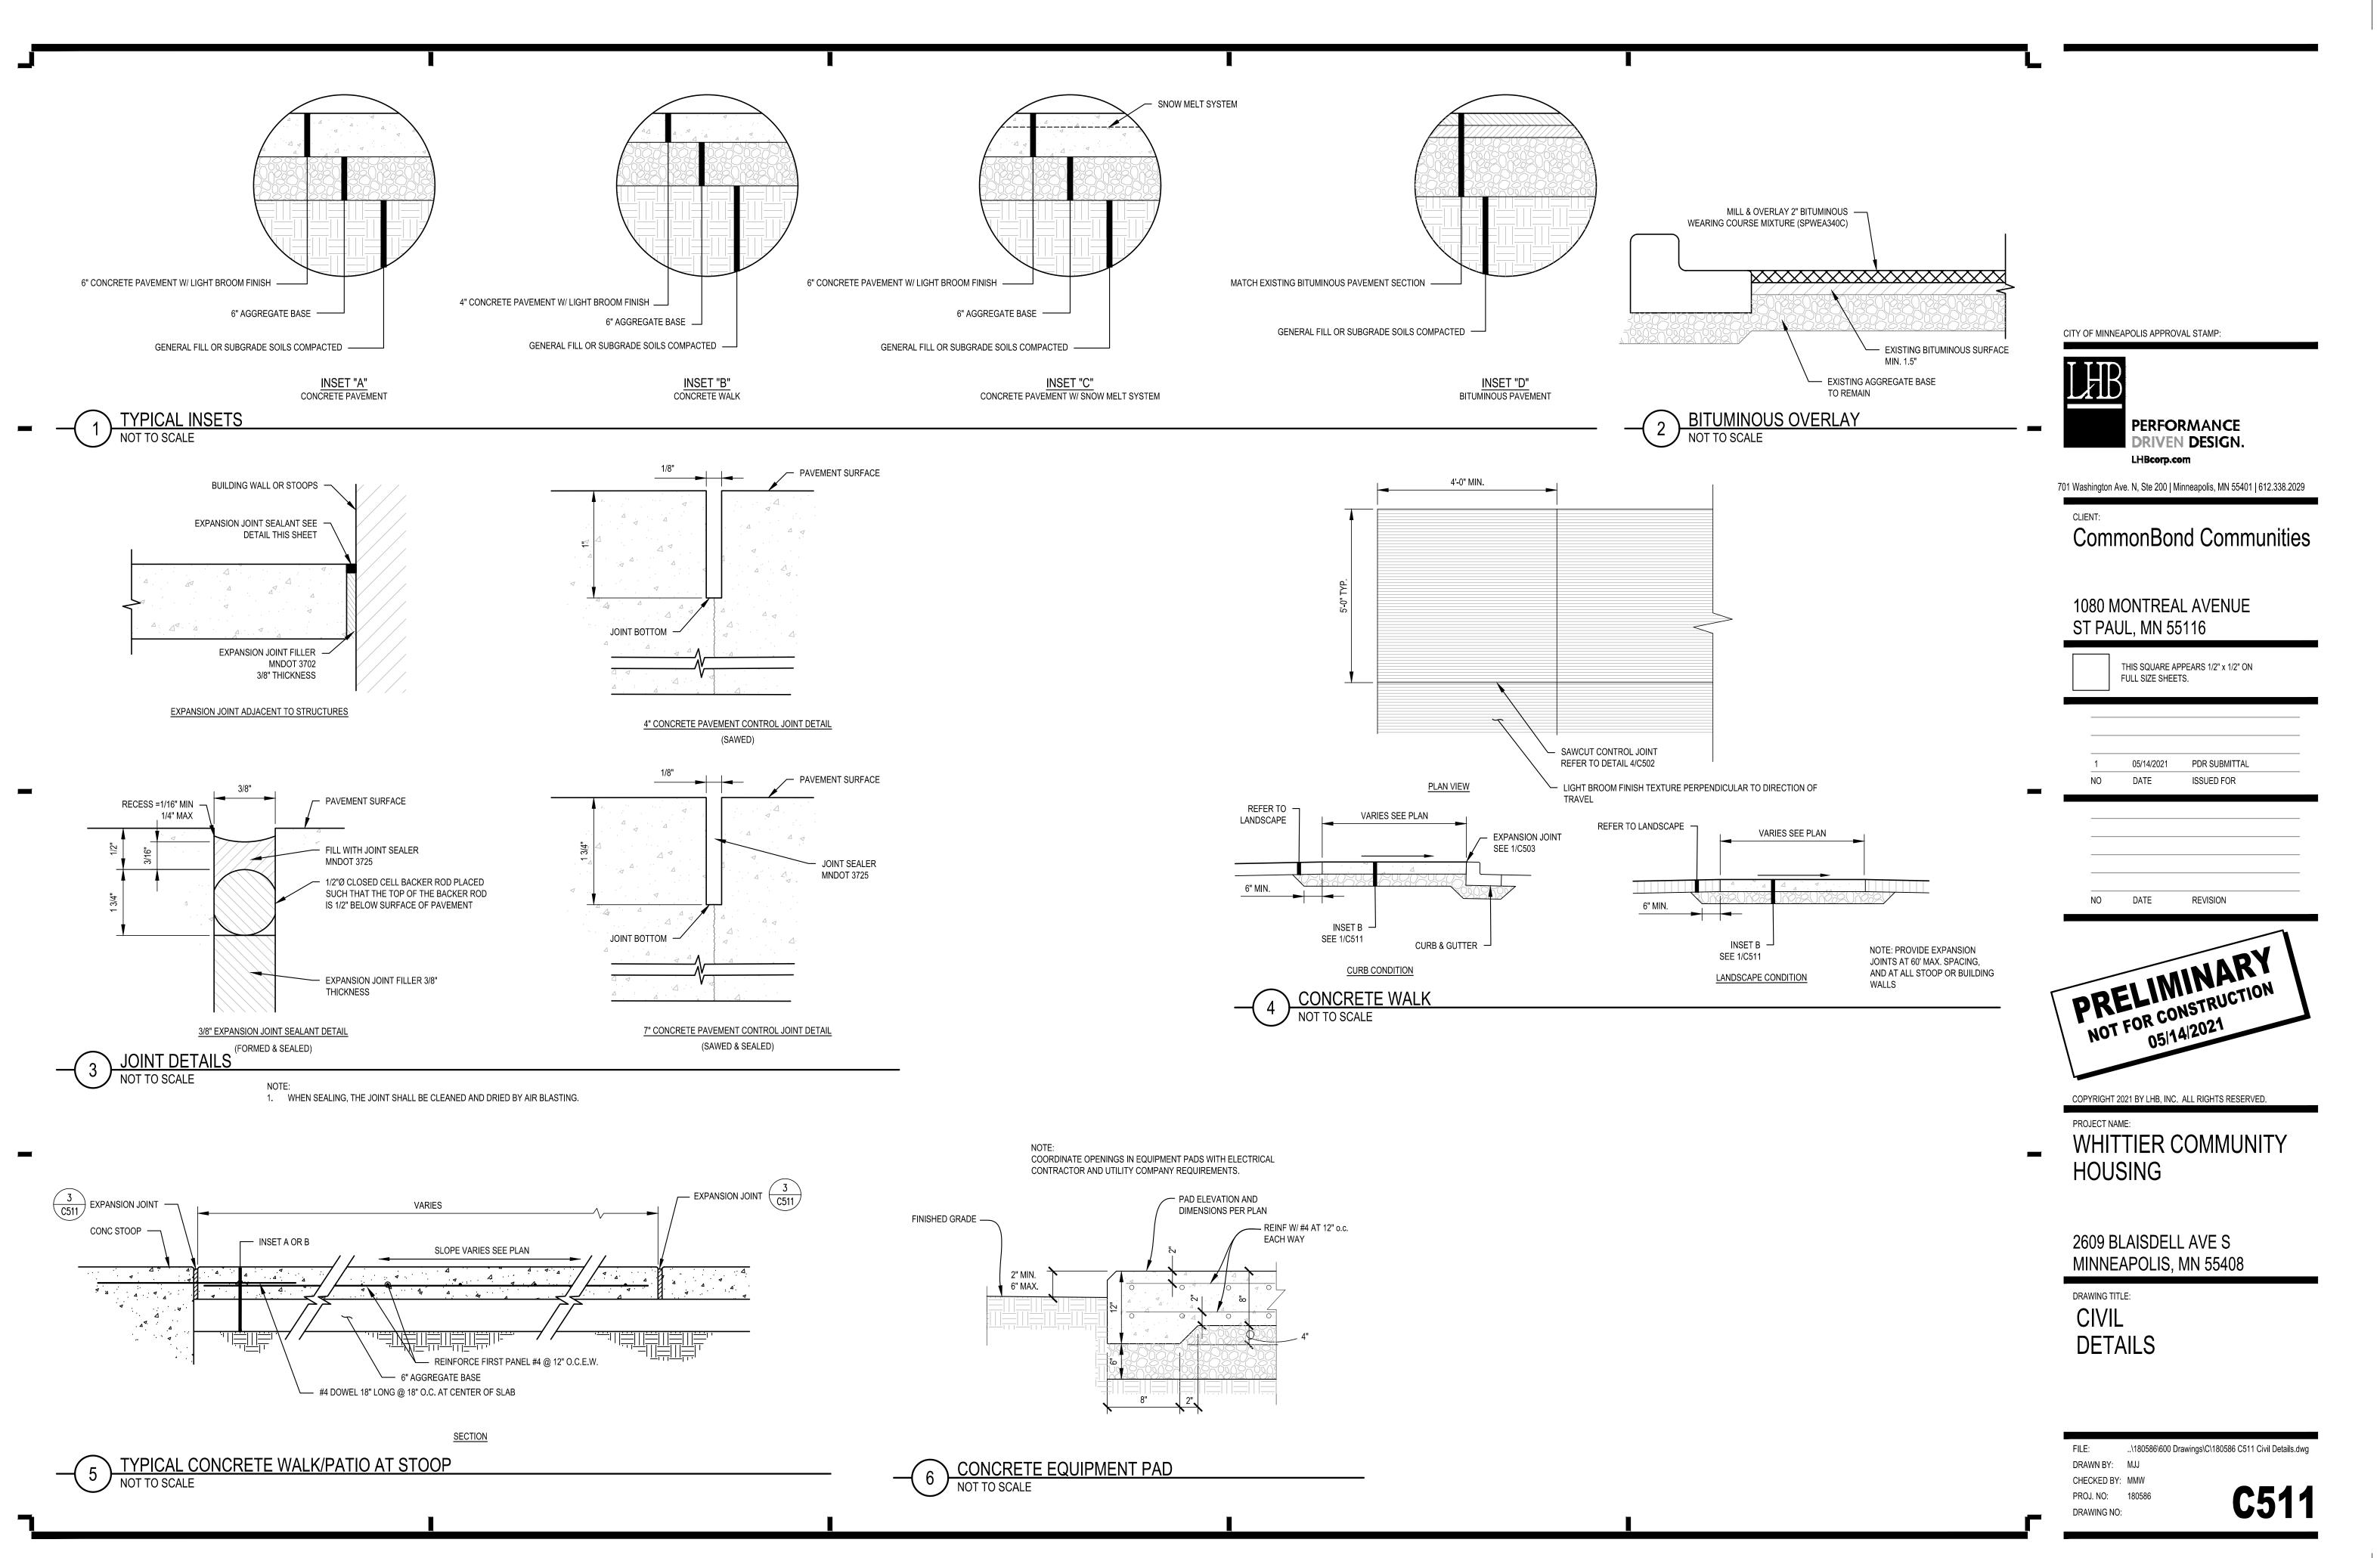
2609 BLAISDELL AVE S MINNEAPOLIS, MN 55408


DRAWING TITLE: CITY DETAILS

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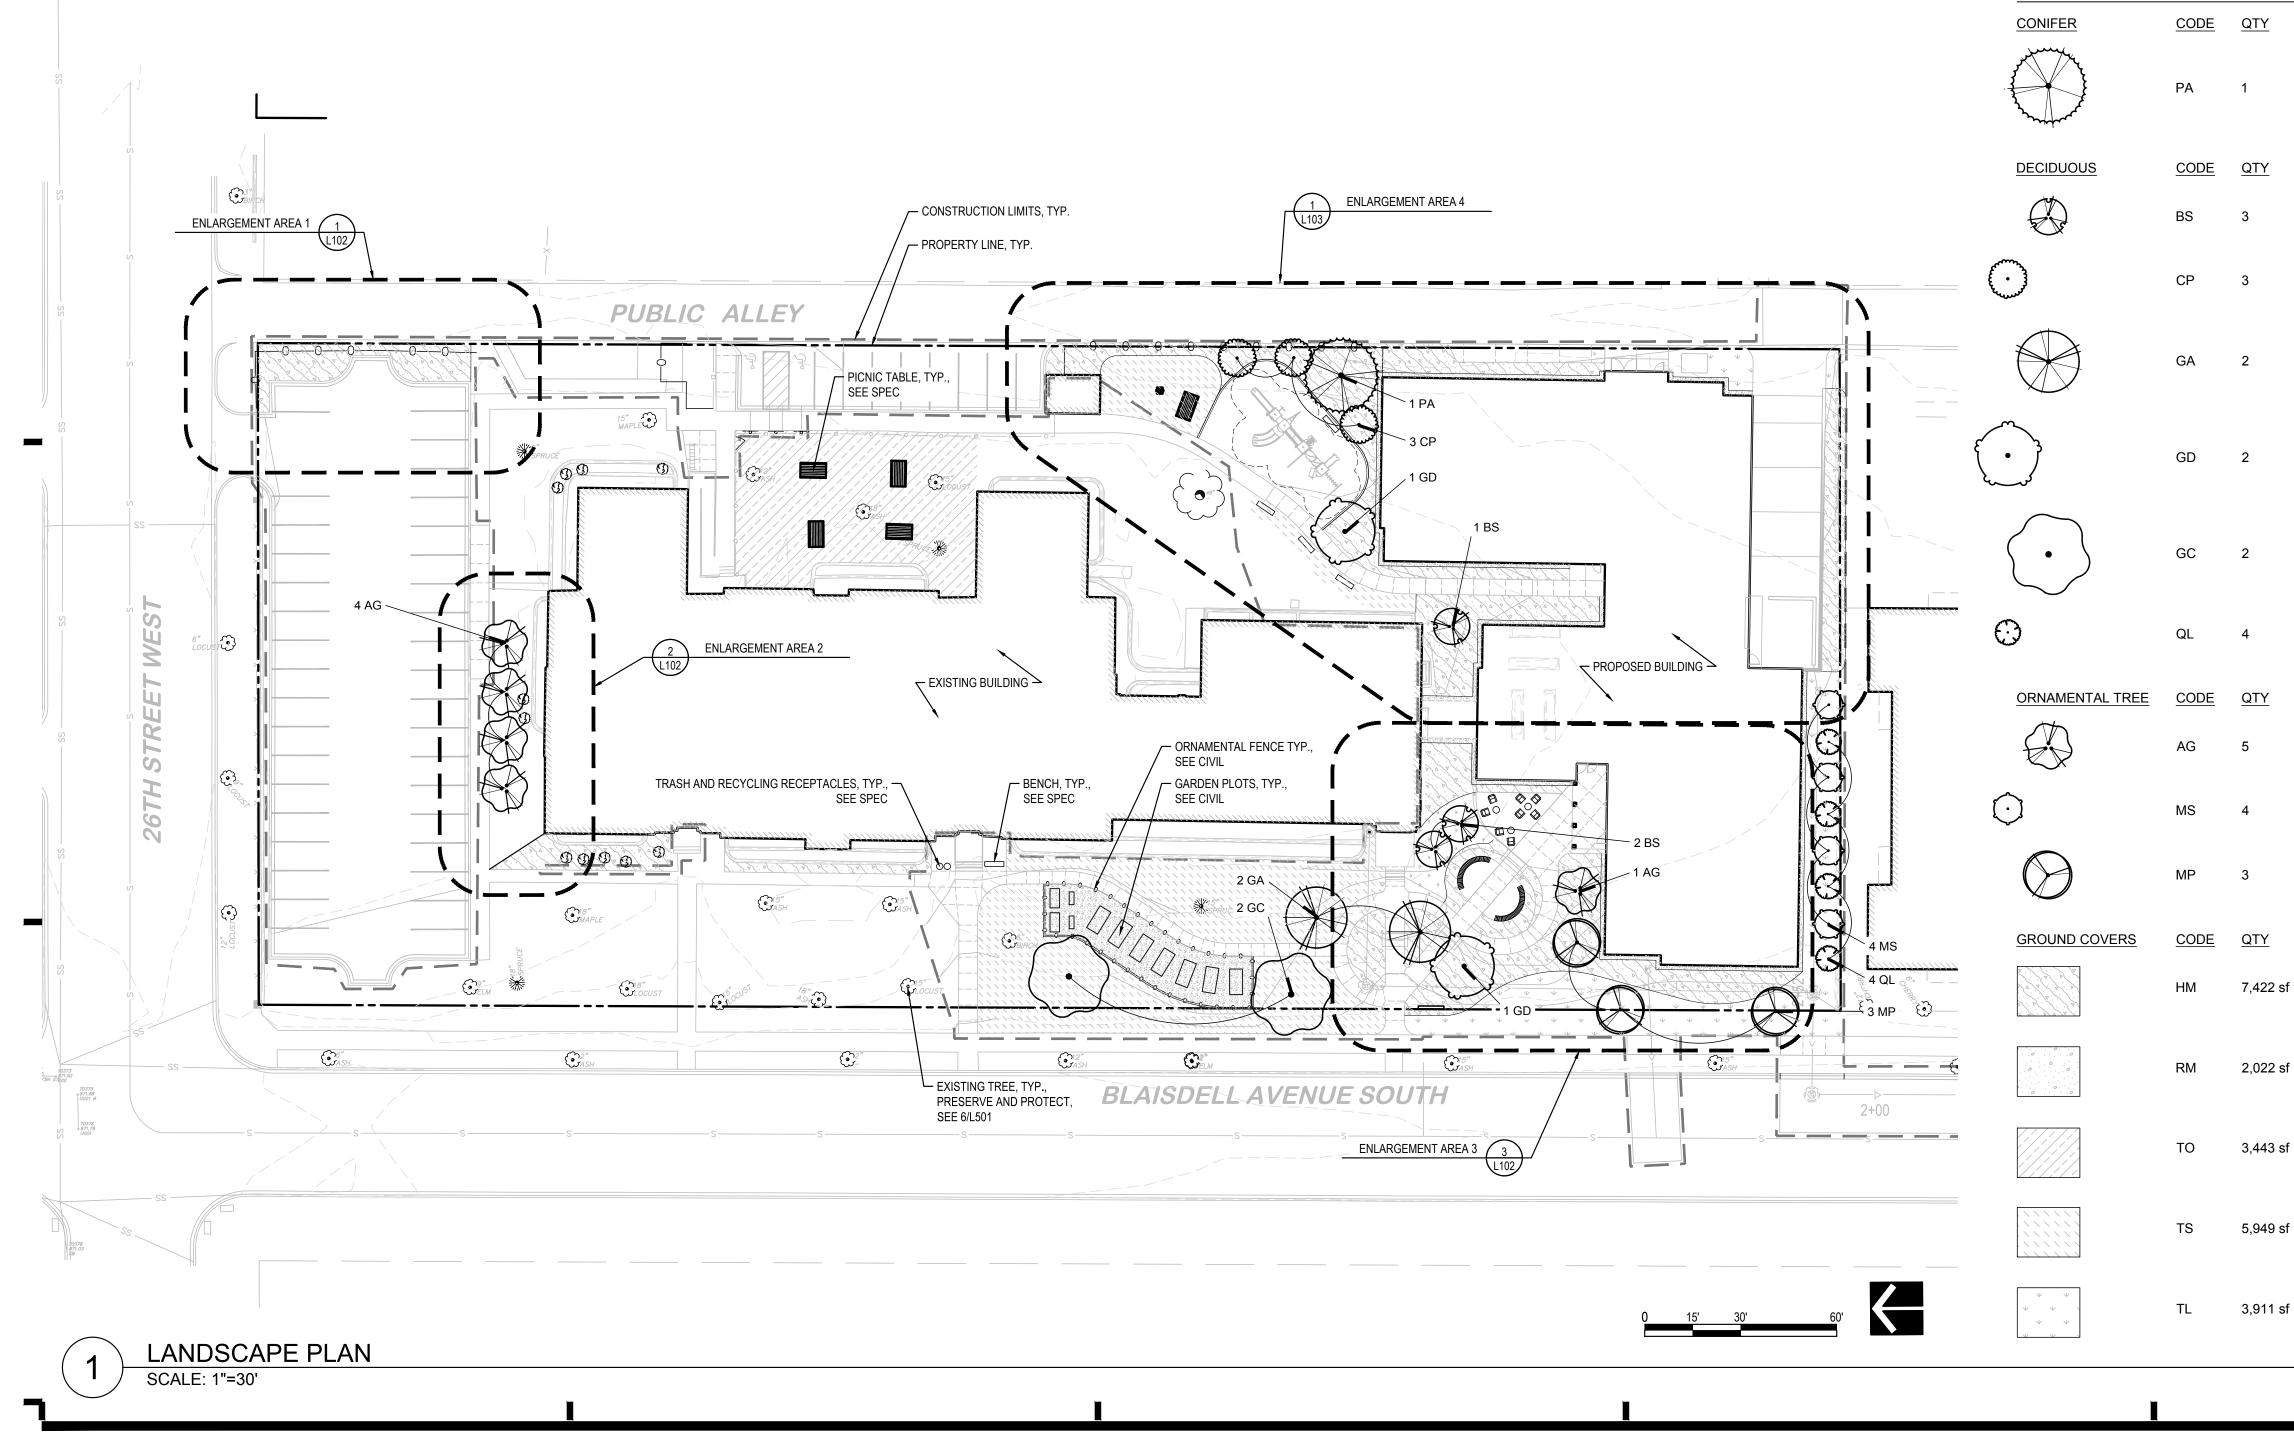




# LANDSCAPE NOTES

- GENERAL LANDSCAPE NOTES: 1. THIS DRAWING DOES NOT CONSTITUTE AN OFFICIAL SURVEY OF THE SITE. CONFIRM ALL LOCATIONS OF SURFACE AND SUB-SURFACE FEATURES BEFORE BEGINNING INSTALLATION. ADVISE LANDSCAPE ARCHITECT OF ANY DISCREPANCIES.
- 2. CONFIRM ALL QUANTITIES, SHAPES AND LOCATIONS OF BEDS, AND ADJUST AS REQUIRED 8. THE CONTRACTOR SHALL KEEP PAVEMENTS, FIXTURES AND BUILDINGS CLEAN AND TO CONFORM TO THE SITE CONDITIONS. CONFIRM ANY ADJUSTMENTS WITH THE LANDSCAPE ARCHITECT.
- 3. LOCATE ALL UTILITIES. NOTIFY THE LANDSCAPE ARCHITECT OF ANY CONFLICTS WITH PLANT INSTALLATION.
- 4. THE CONTRACTOR SHALL BE RESPONSIBLE FOR ALL MULCHES AND PLANTING SOIL QUANTITIES TO COMPLETE THE WORK SHOWN ON THE PLAN. VERIFY ALL QUANTITIES SHOWN ON THE PLANT SCHEDULE.
- 5. THE CONTRACTOR SHALL REMOVE FROM THE SITE ALL SOD/TURF WHICH HAS BEEN REMOVED FOR NEW PLANT BEDS. LONG-TERM STORAGE OF MATERIALS OR SUPPLIES ON-SITE WILL NOT BE ALLOWED. ANY PLANT STOCK NOT PLANTED ON DAY OF DELIVERY SHALL BE HEELED IN AND WATERED UNTIL INSTALLATION. PLANTS NOT MAINTAINED IN THIS MANNER WILL BE REJECTED.
- 6. THE PLAN TAKES PRECEDENCE OVER THE PLANT SCHEDULE IF DISCREPANCIES EXIST. ADVISE LANDSCAPE ARCHITECT OF ANY DISCREPANCIES.

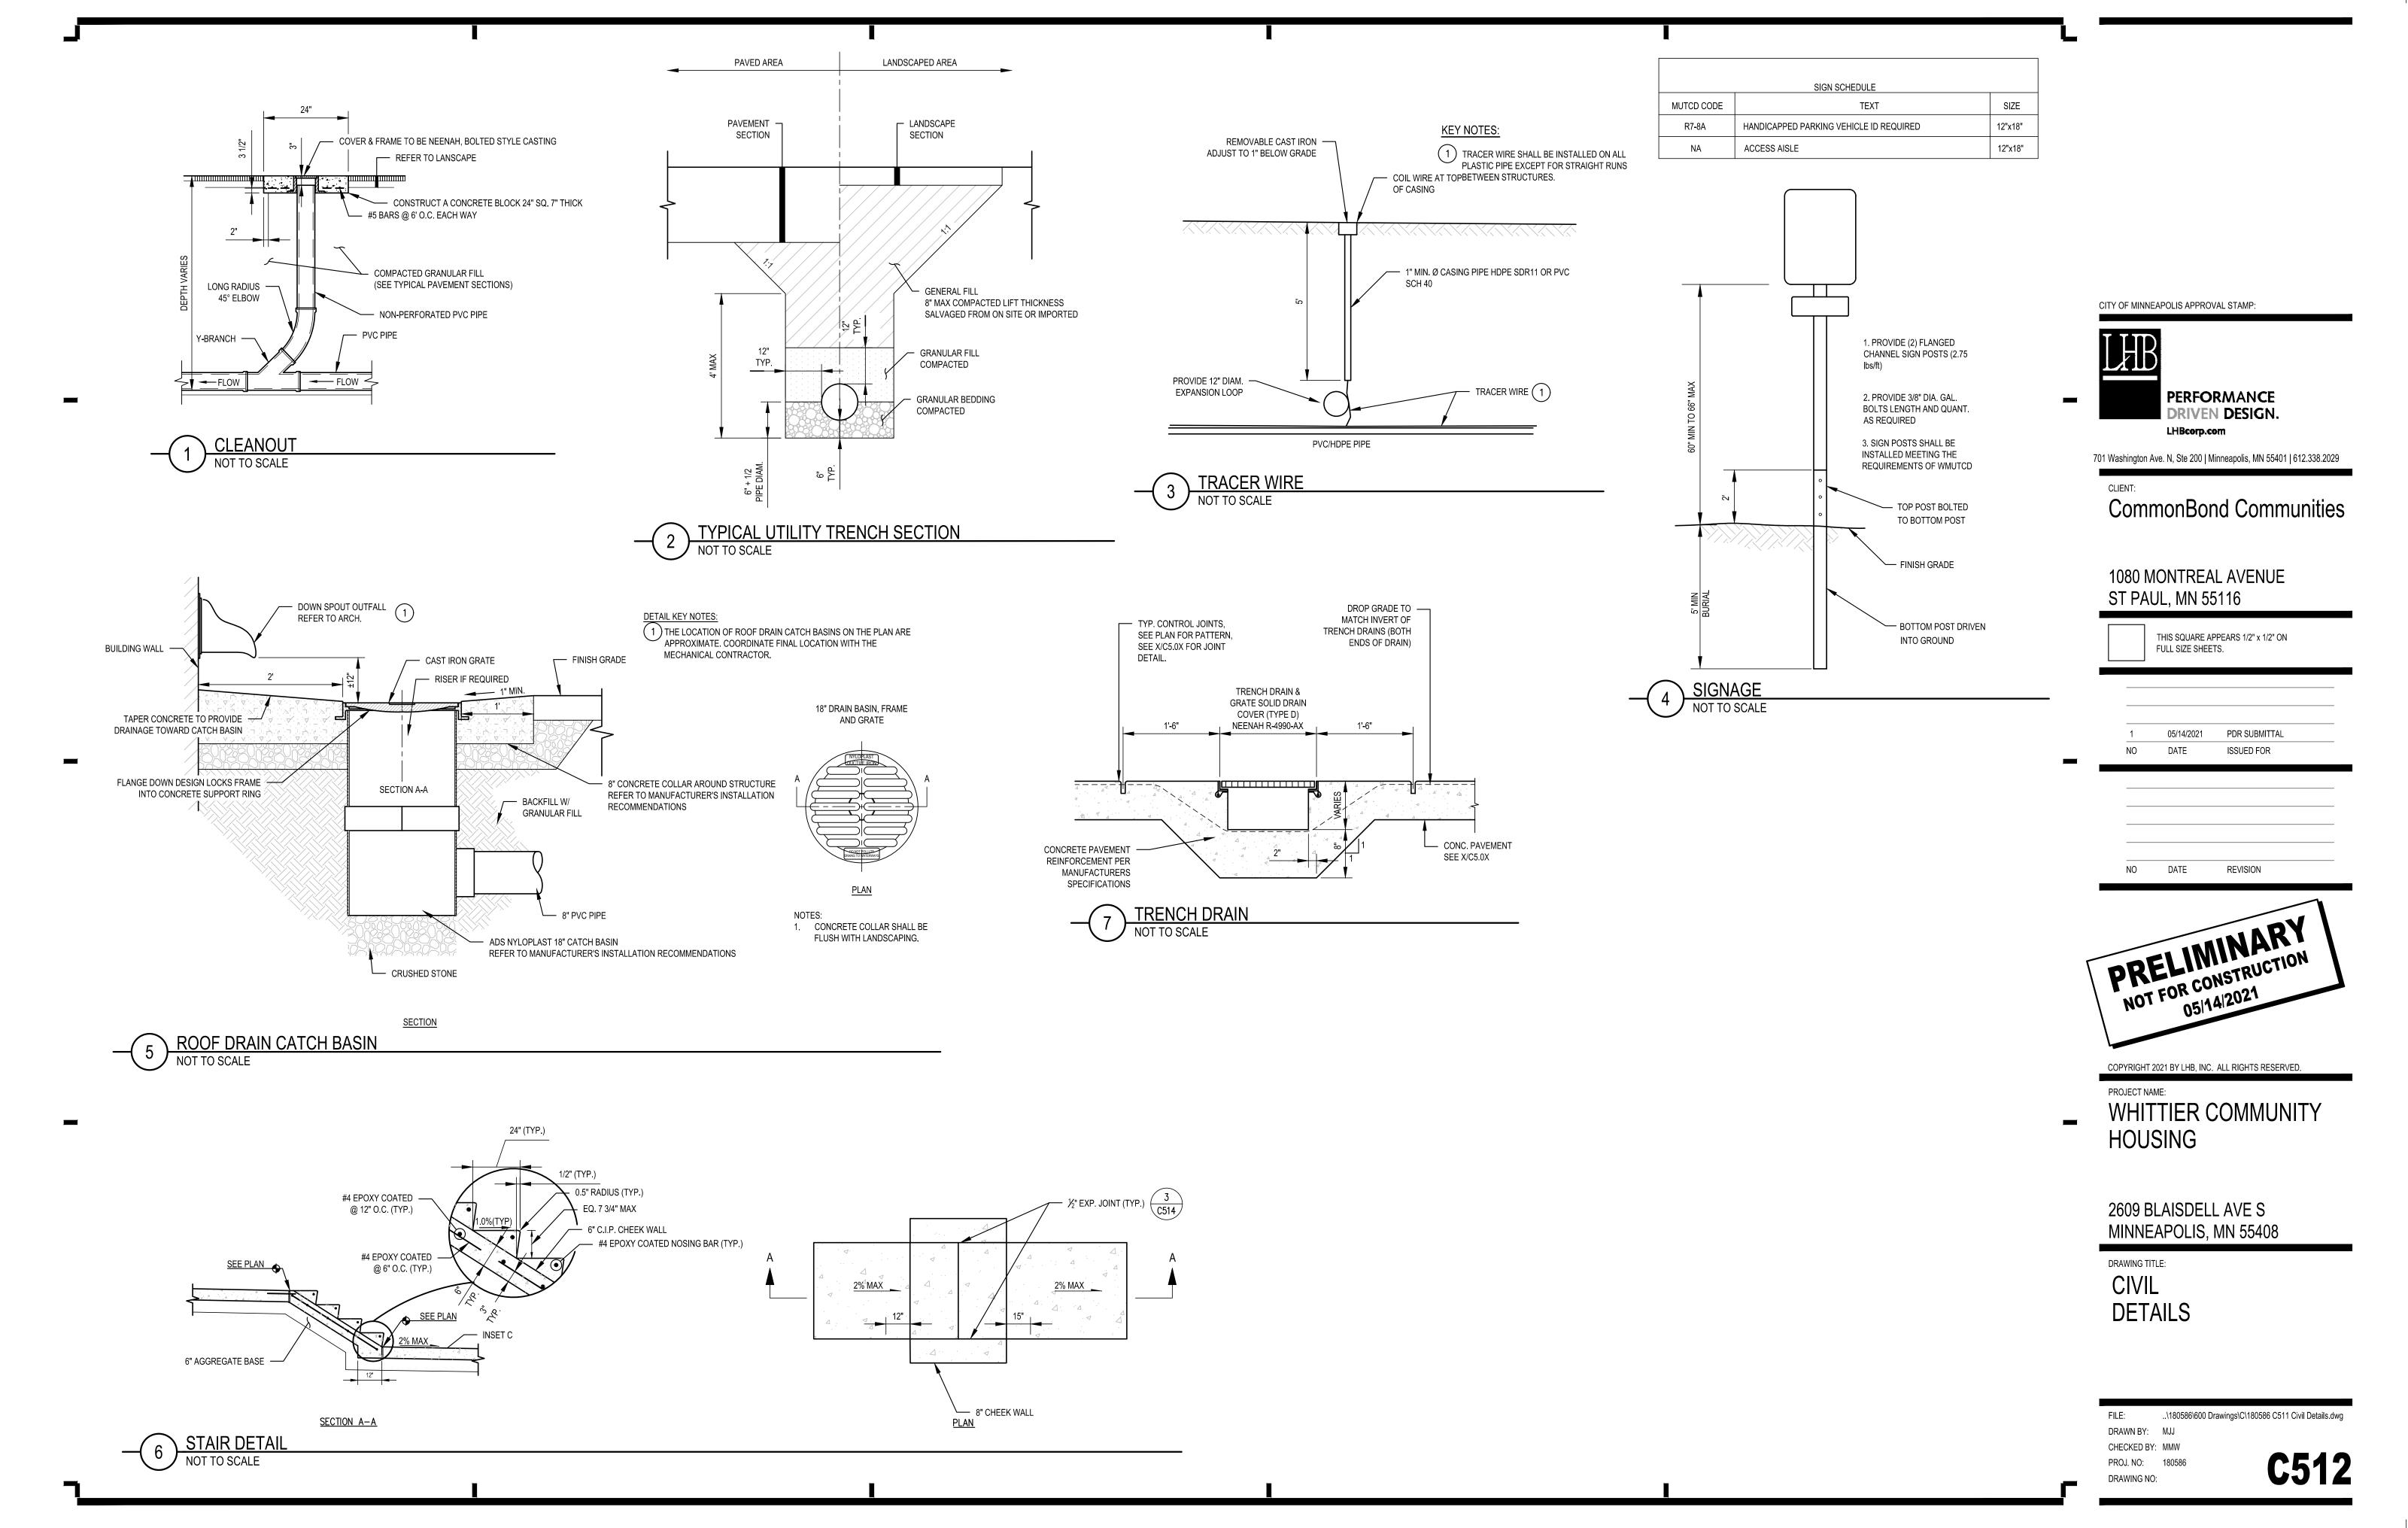- THE CONTRACTOR SHALL AVOID DAMAGING EXISTING TREES. DO NOT STORE OR DRIVE HEAVY MATERIALS OVER TREE ROOTS. DO NOT DAMAGE TREE BARK OR BRANCHES. UNSTAINED. ANY DAMAGE TO EXISTING FACILITIES SHALL BE REPAIRED AT THE CONTRACTOR'S EXPENSE. THE PROJECT SITE SHALL BE KEPT CLEAR OF CONSTRUCTION WASTES AND DEBRIS.
- PROVIDE SILT FENCE IF NECESSARY TO PROTECT STREET FROM EROSION. 10. SOD ALL AREAS DISTURBED BY CONSTRUCTION. TPI CERTIFIED TURFGRASS SOD QUALITY; 80% KENTUCKY BLUE GRASS, 20% PERENNIAL RYE; WITH STRONG FIBROUS ROOT SYSTEM, FREE OF STONES, BURNED OR BARE SPOTS; CONTAINING NO MORE THAN 5 WEEDS PER 1000 SQ FT. MINIMUM AGE OF 18 MONTHS, WITH ROOT DEVELOPMENT THAT WILL SUPPORT ITS OWN WEIGHT WITHOUT TEARING WHEN SUSPENDED VERTICALLY BY HOLDING THE UPPER TWO CORNERS.
- PLANT MATERIAL 11. NO SUBSTITUTIONS OF PLANT MATERIAL SHALL BE ACCEPTED UNLESS APPROVED IN WRITING BY THE LANDSCAPE ARCHITECT. THE LANDSCAPE ARCHITECT RESERVES THE
- RIGHT TO REJECT ANY PLANTS WHICH ARE DEEMED UNSATISFACTORY. 12. ALL PLANTING STOCK SHALL CONFORM TO THE "AMERICAN STANDARD FOR NURSERY STOCK", ANSI-Z60. LATEST EDITION, OF THE AMERICAN ASSOCIATION OF NURSERYMEN,
- INC 13. ALL PLANTS SHALL BE GUARANTEED FOR TWO COMPLETE GROWING SEASONS (APRIL 1-NOVEMBER 1 OF FOLLOWING YEAR), UNLESS OTHERWISE SPECIFIED. THE GUARANTEE SHALL COVER THE FULL COST OF REPLACEMENT INCLUDING LABOR AND PLANTS.



- 14. WALK AND BENCH PADS WILL BE 4" THICK EXPOSED AGGREGATE CONCRETE SET ON 4" COMPACTED CLASS 5 AGGREGATE BASE. CONTROL JOINTS SHALL BE SAW CUT AND LAID OUT AS SPECIFIED IN PLANS.
- 15. EXPANSION JOINT FILLER : FLEXIBLE, COMPRESSIBLE, CLOSED CELL POLYETHYLENE FOAM.
- 16. EXPANSION JOINT SEALANT: SILICONE JOINT SEALANT DOW CORNING #888, COLOR, GRAY. 17. ALL CONCRETE SHALL BE EXPOSED AGGREGATE: 8 DAY COMPRESSIVE STRENGTH 4000 PSI PORTLAND CEMENT TYPE LAFARGE MAX. COARSE AGGREGATE SIZE <del>]</del>", #7 MAX. SLUMP AIR CONTENT 6% +/- 1% SURFACE RETARDER TYPE S

# OTHER MATERIA

18. PROVIDE SHREDDED HARDWOOD MULCH, CLEAN AND FREE OF NOXIOUS WEEDS OR OTHER DELETERIOUS MATERIAL, DELIVER MULCH ON DAY OF INSTALLATION. USE 2" DEPTH FOR PERENNIAL/GROUND COVER BEDS, UNLESS OTHERWISE DIRECTED. APPLY PELLET WEED PREVENTER UNDER MULCH BEDS IN SHRUB AREAS.

# SOILS AND GROUND

- 19. SOIL CORRECTION FOR TREES, SHRUBS AND TURF: DISC SOIL TO A FULL 5" DEPTH IN ALL AREAS TO BE PLANTED TO LOOSEN COMPACTED SOILS. IDENTIFY AND PROTECT ROOTS OF EXISTING TREES.
- 20. THE INTENT IS TO USE EXISTING TOPSOIL FOR ALL PLANTING SOIL IN TREE, SHRUB AND PERENNIAL AREAS. IF THE EXISTING TOPSOIL DOES NOT MEET REQUIREMENTS FOR PLANTING, IMPORTED PLANTING SOIL SHOULD BE USED THAT MEETS TESTING AGENCY'S REQUIREMENTS AND AT A MINIMUM SHOULD BE COMPOSED OF:
- 0 A UNIFORM MIXTURE OF 1 PART SAND, 1 PART RE-PEET, AND 1 PART TOPSOIL BY VOLUME.

# MAINTENANCE AND CARE

- MAINTENANCE SHALL BEGIN IMMEDIATELY AFTER EACH PORTION OF THE WORK IS IN PLACE. PLANT MATERIAL SHALL BE PROTECTED AND MAINTAINED UNTIL THE INSTALLATION OF PLANTINGS IS COMPLETE, INSPECTION HAS BEEN MADE AND PLANTING IS ACCEPTED EXCLUSIVE OF THE GUARANTEE.
- 22. MAINTENANCE SHALL INCLUDE WATERING, WEEDING, MULCHING, REMOVAL OF DEAD MATERIAL PRIOR TO GROWING SEASON, RE-SETTING PLANTS AND PROPER GRADE, AND KEEPING PLANTS IN A PLUMB POSITION. AFTER ACCEPTANCE, THE OWNER SHALL ASSUME MAINTENANCE RESPONSIBILITIES. HOWEVER, THE CONTRACTOR SHALL CONTINUE TO BE RESPONSIBLE FOR KEEPING THE TREES PLUMB THROUGHOUT THE GUARANTEE PERIOD.
- 23. WATERING: MAINTAIN A WATERING SCHEDULE WHICH WILL THOROUGHLY WATER ALL PLANTS ONCE A WEEK. IN EXTREMELY HOT, DRY WEATHER, WATER MORE OFTEN AS REQUIRED BY INDICATIONS OF HEAT STRESS SUCH AS WILTING LEAVES. CHECK MOISTURE UNDER MULCH PRIOR TO WATERING TO DETERMINE NEED. CONTRACTOR SHALL MAKE THE NECESSARY ARRANGEMENTS FOR WATER.

# **BID ALTERNATES**

24. PROVIDE SEPARATE, PER UNIT COSTS FOR THE FOLLOWING BID ADD ALTERNATES:

# PLANT SCHEDULE

# WARNING

LOCATION OF ALL UNDERGROUND UTILITIES SHALL BE VERIFIED BY THE CONTRACTOR. CALL BEFORE DIGGING

MINNESOTA ONE-CALL SYSTEM -800-252-1166 REQUIRED BY MN STATUTE 216D

**BOTANICAL / COMMON NAME** 

Picea abies

Norway Spruce

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<u>CONT</u>

#10 CONT

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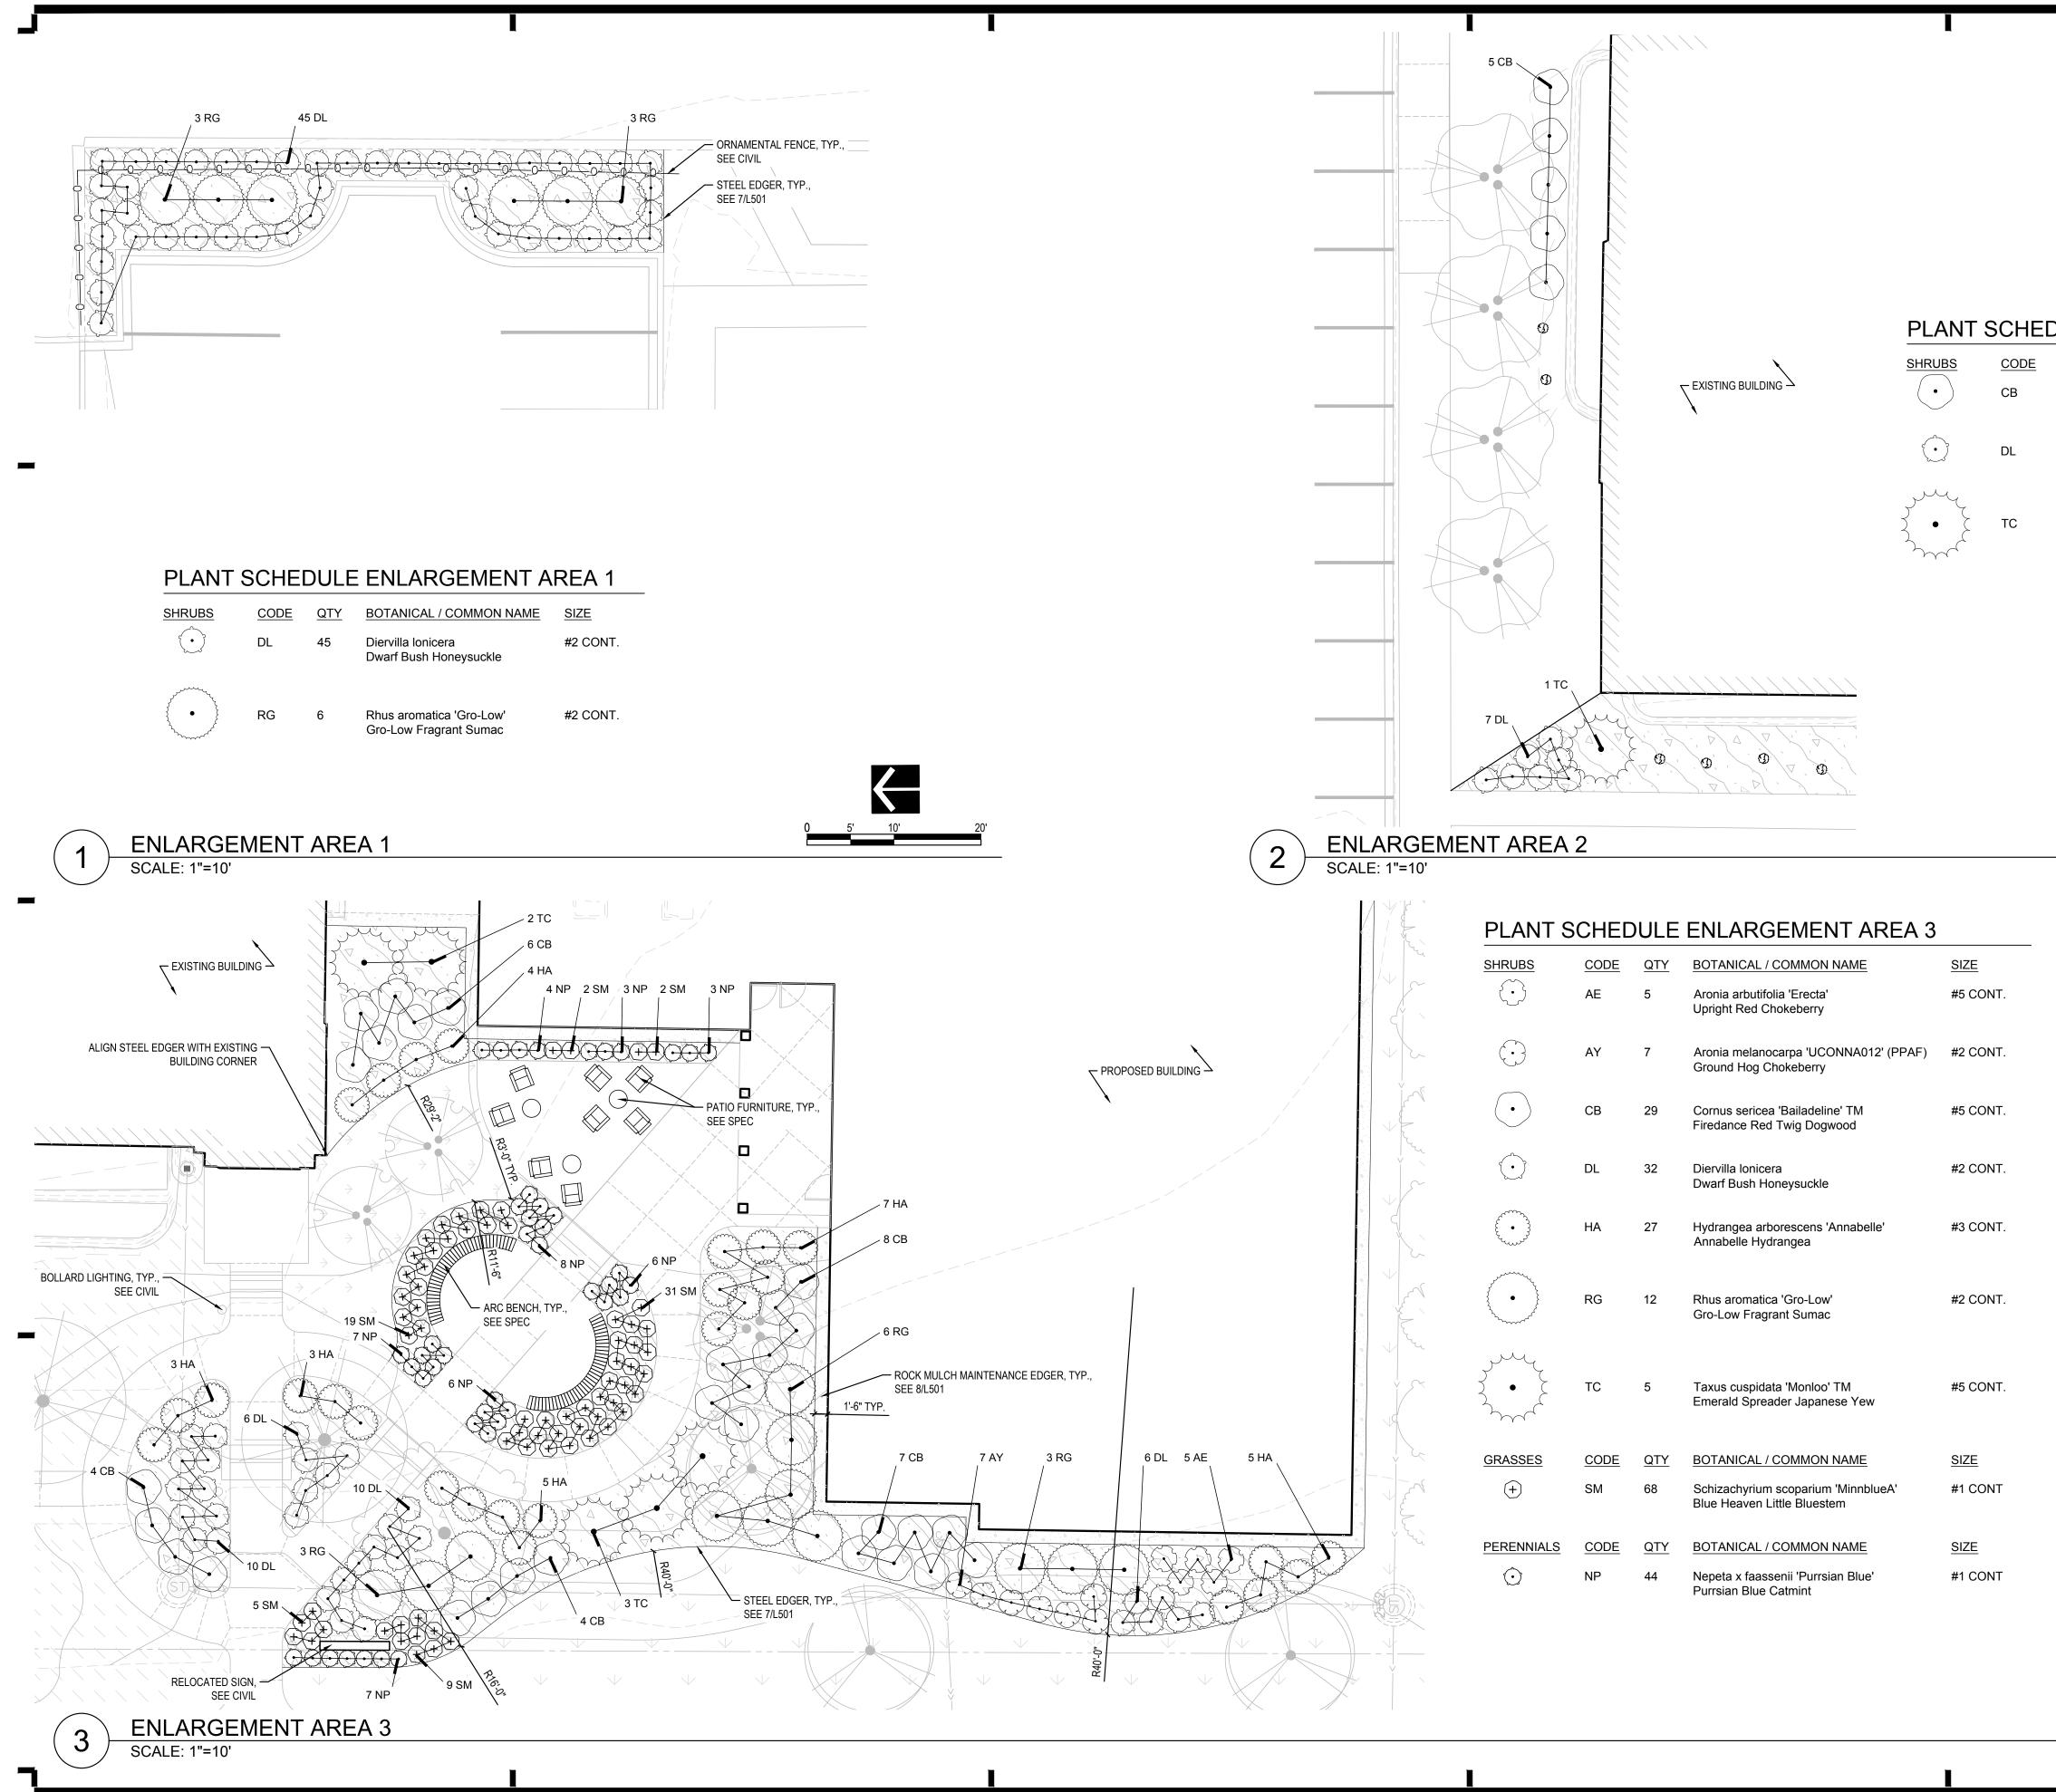
701 Washington Ave. N, Ste 200 | Minneapolis, MN 55401 | 612.338.2029

# CLIENT CommonBond Communities

# 1080 MONTREAL AVENUE ST PAUL, MN 55116

В		THIS SQUARE A FULL SIZE SHEE	PPEARS 1/2" x 1/2" ON TS.	
В				
-	1 NO	05/14/2021 DATE	PDR SUBMITTAL	
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В	 NO	DATE	REVISION	
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	PROJECT NA		Communi	
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BOTANICAL / COMMON NAME	CONT
Betula nigra 'Shiloh Splash' Shiloh Splash Birch	8` CLUMP
Celtis occidentalis 'JFS-KSU1' TM Prairie Sentinel Common Hackberry	2" B&B
Ginkgo biloba `Autumn Gold` TM Autumn Gold Maidenhair Tree	2" B&B
Gleditsia triacanthos inermis 'Draves' TM Street Keeper Honey Locust	2" B&B
Gymnocladus dioicus 'UMNSynergy' TM Kentucky True North	2" B&B
Quercus robur x alba 'JFS-KW2QX' TM Skinny Genes Oak	#10 CONT
BOTANICAL / COMMON NAME	CONT
Amelanchier x grandiflora 'Autumn Brilliance' Autumn Brilliance Apple Serviceberry	8` CLUMP
Maackia amurensis 'Summertime' Summertime Maackia	2" B&B
Malus x 'Purple Prince' Purple Prince Crabapple	#10 CONT
BOTANICAL / COMMON NAME	<u>CONT</u>
Hardwood Mulch Refer to Spec	Mulch
Rock Mulch Refer to Detail Sheet L501	Mulch
Turf Overseeding Refer to Spec	Seed
Turf Seed Refer to Spec	Seed
Turf Seed Low Grow Mix Refer to Spec	Seed



# PLANT SCHEDULE ENLARGEMENT AREA 2

<u>QTY</u>	BOTANICAL / COMMON NAME	SIZE
5	Cornus sericea 'Bailadeline' TM Firedance Red Twig Dogwood	#5 CONT.
7	Diervilla lonicera Dwarf Bush Honeysuckle	#2 CONT.
1	Taxus cuspidata 'Monloo' TM Emerald Spreader Japanese Yew	#5 CONT.

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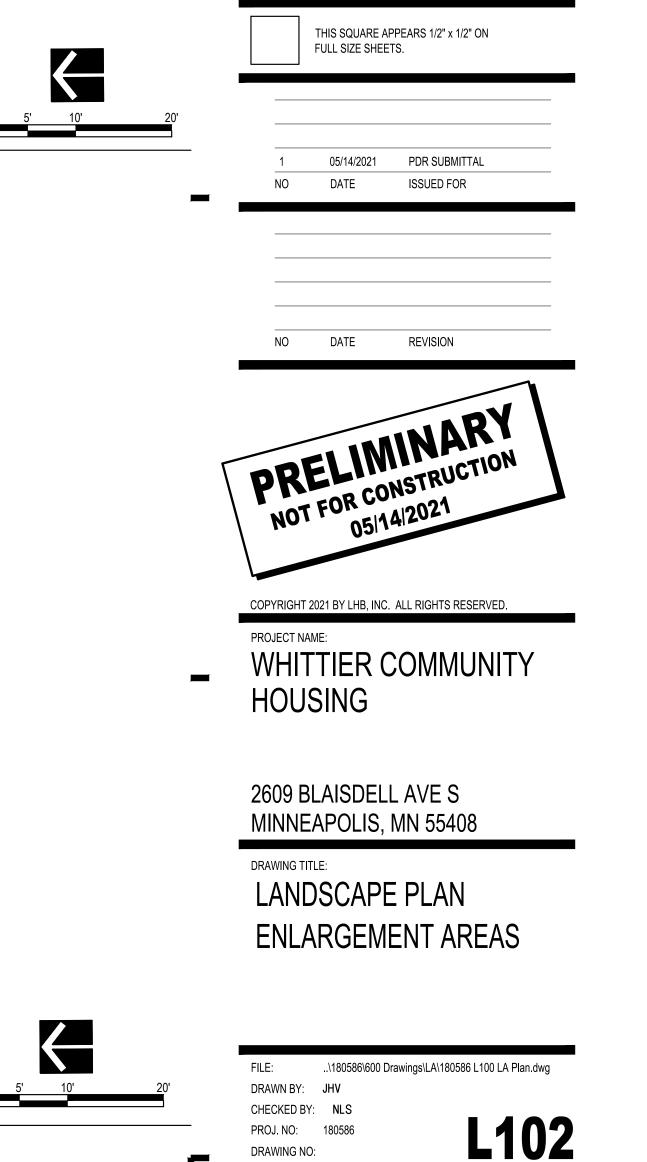



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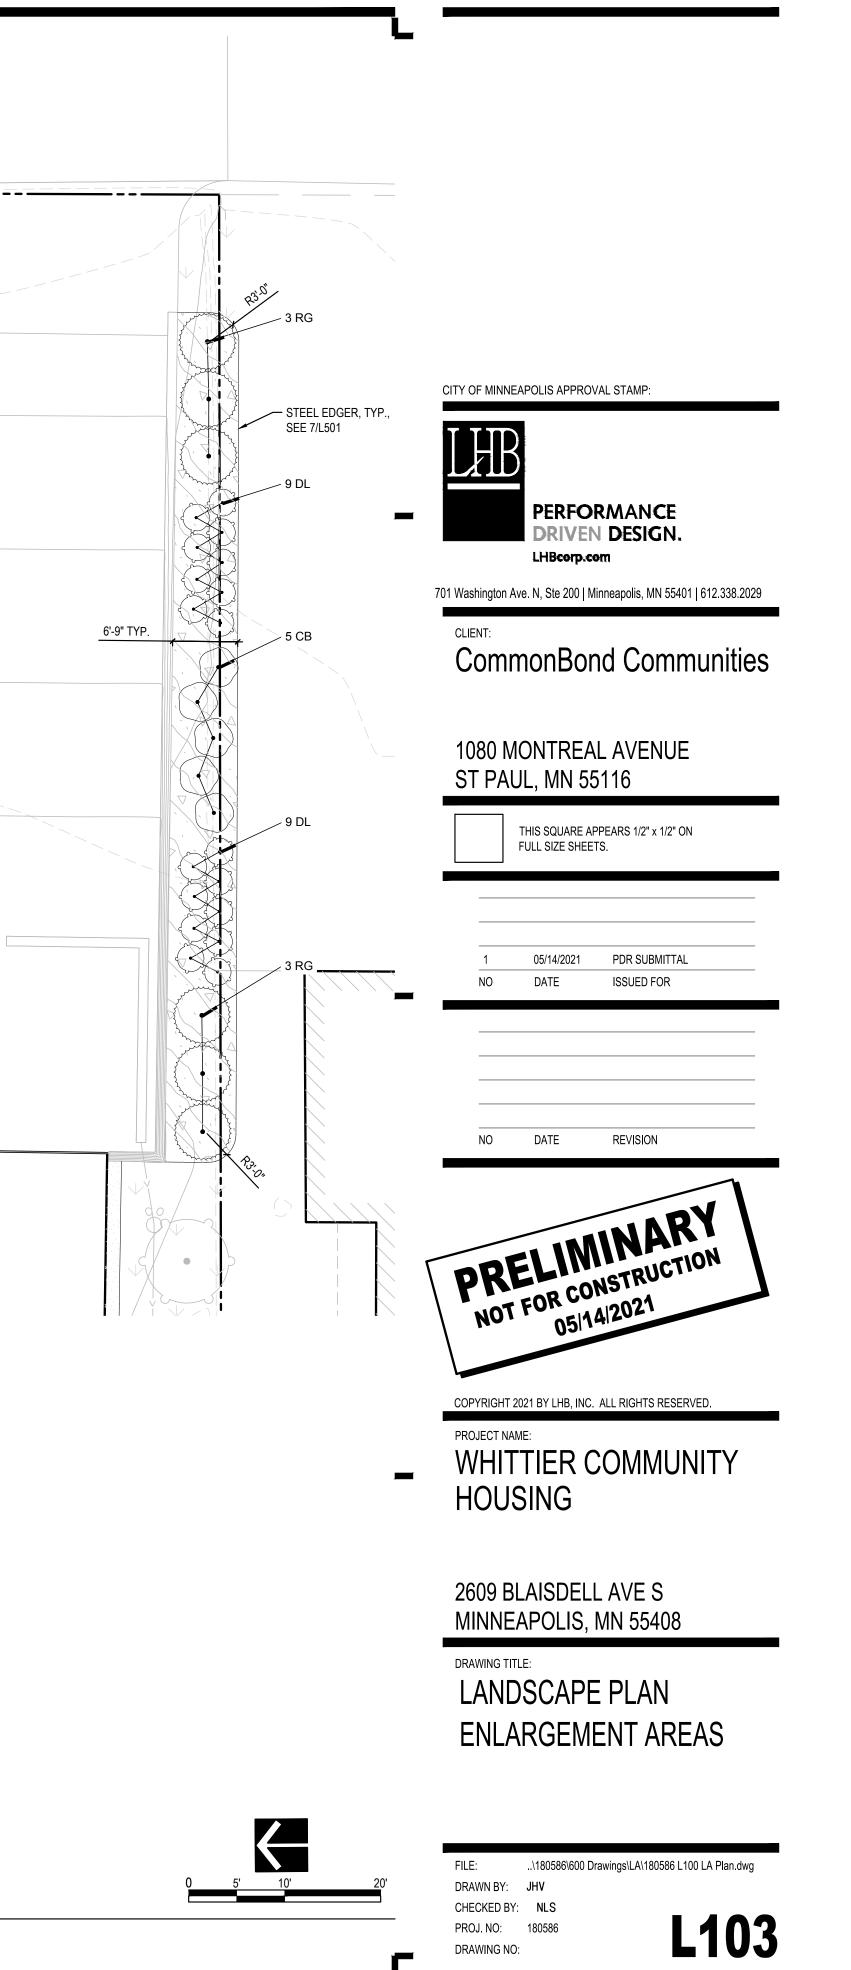
# 1080 MONTREAL AVENUE ST PAUL, MN 55116







SHRUBS	CODE	<u>QTY</u>	BOTANICAL / COMMON NAME	SIZE
$\textcircled{\cdot}$	AE	23	Aronia arbutifolia 'Erecta' Upright Red Chokeberry	#5 CONT.
$\left( \cdot \right)$	AY	21	Aronia melanocarpa 'UCONNA012' (PPAF) Ground Hog Chokeberry	#2 CONT.
$\textcircled{\bullet}$	СВ	40	Cornus sericea 'Bailadeline' TM Firedance Red Twig Dogwood	#5 CONT.
	DL	55	Diervilla lonicera Dwarf Bush Honeysuckle	#2 CONT.
	HA	13	Hydrangea arborescens 'Annabelle' Annabelle Hydrangea	#3 CONT.
•	RG	20	Rhus aromatica 'Gro-Low' Gro-Low Fragrant Sumac	#2 CONT.
	TC	10	Taxus cuspidata 'Monloo' TM Emerald Spreader Japanese Yew	#5 CONT.



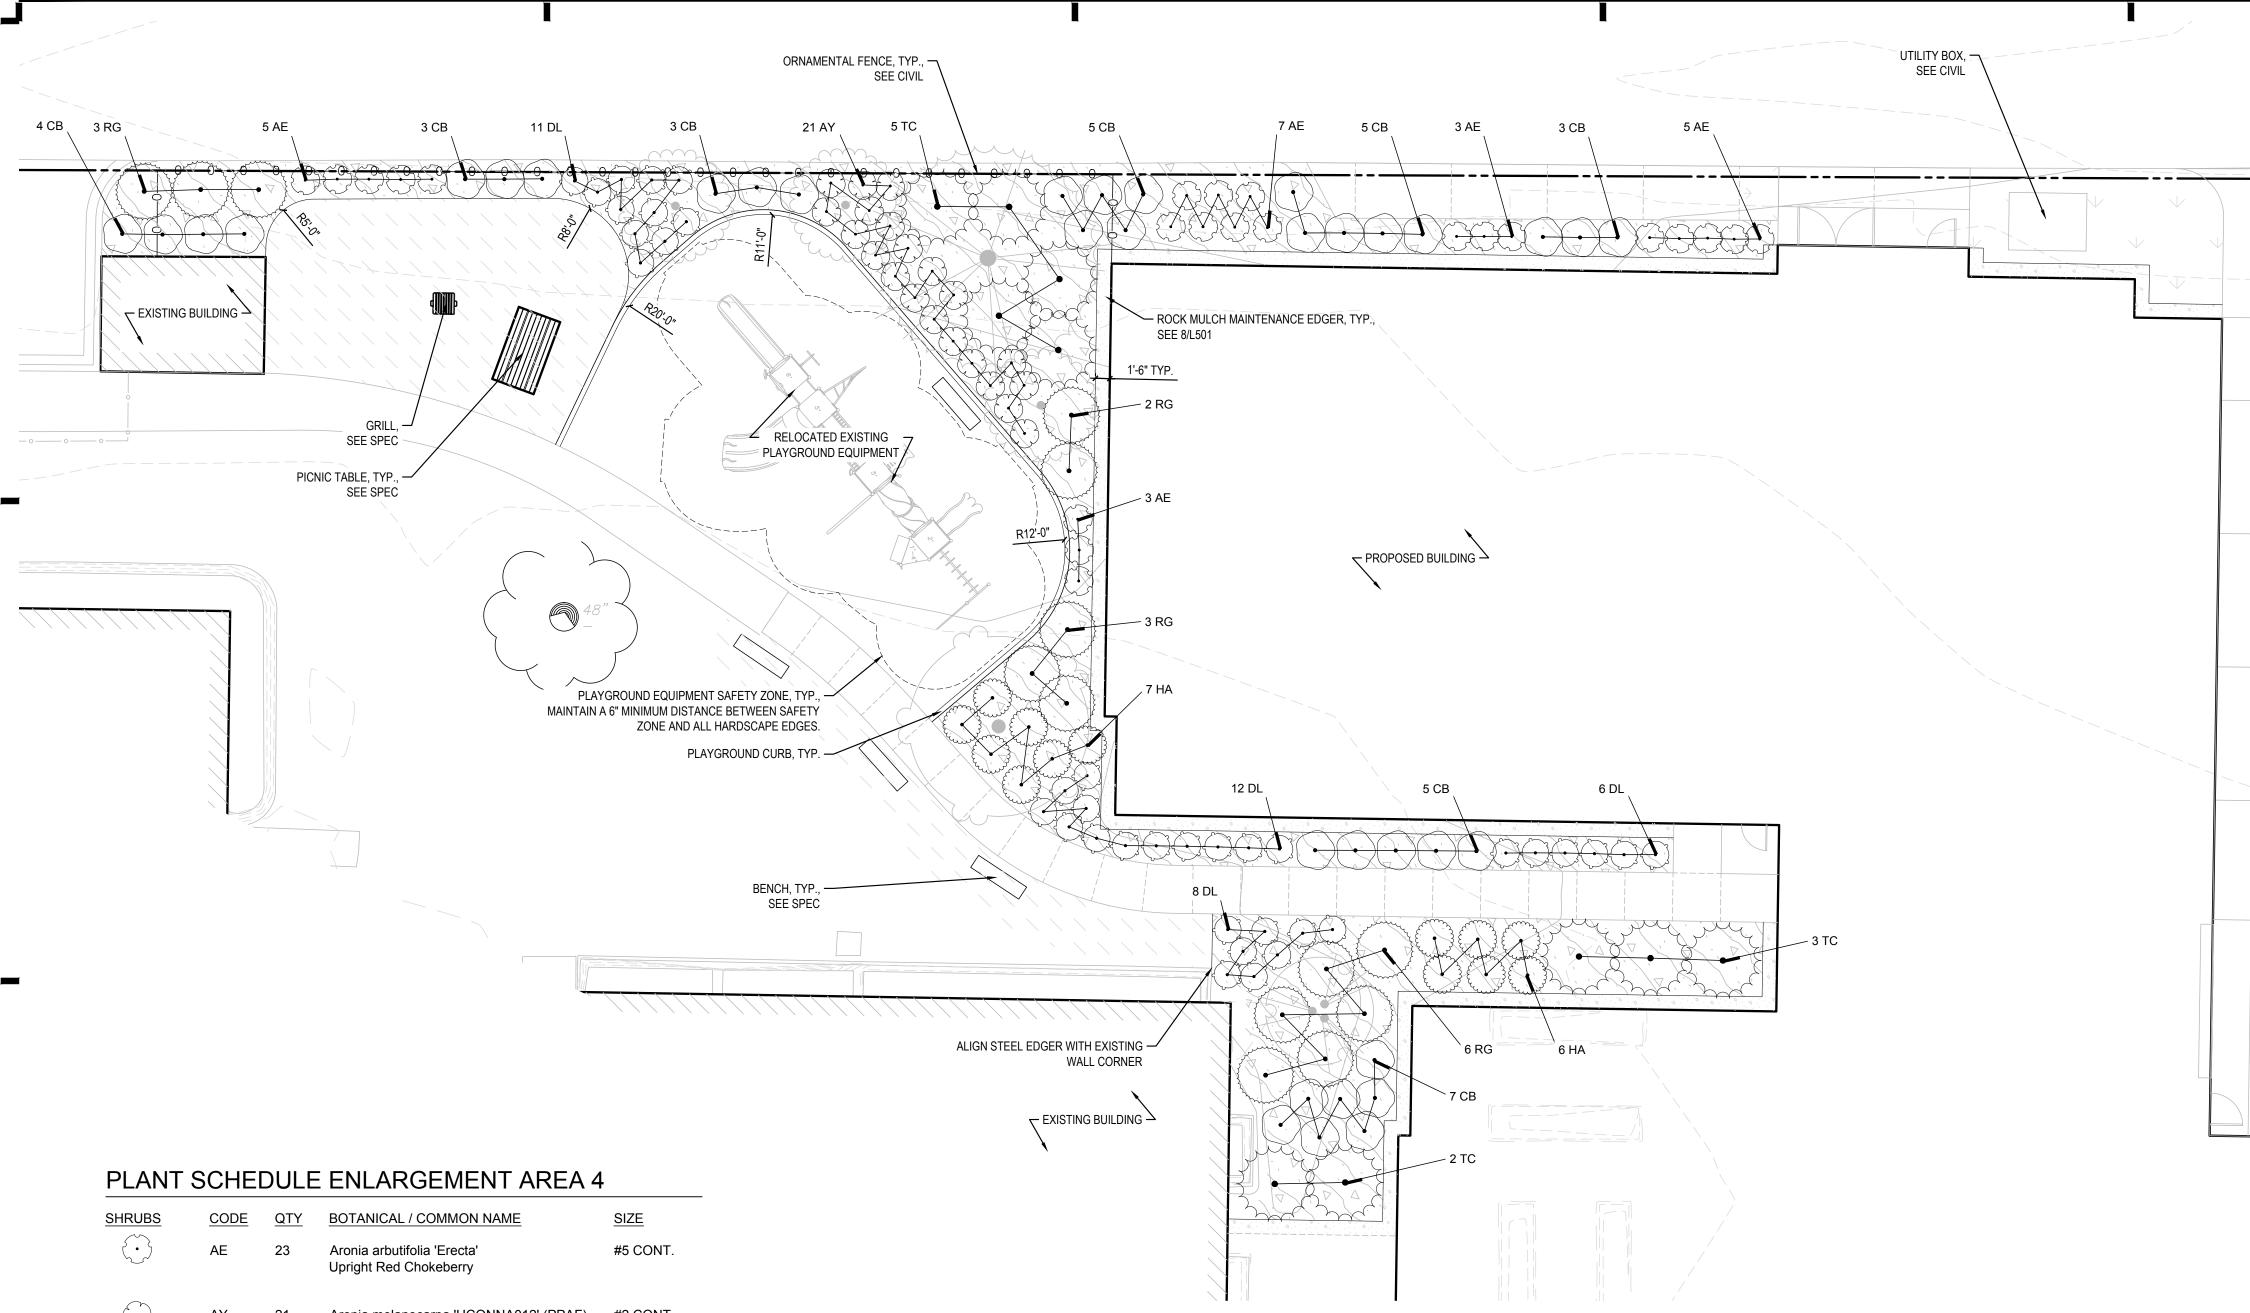



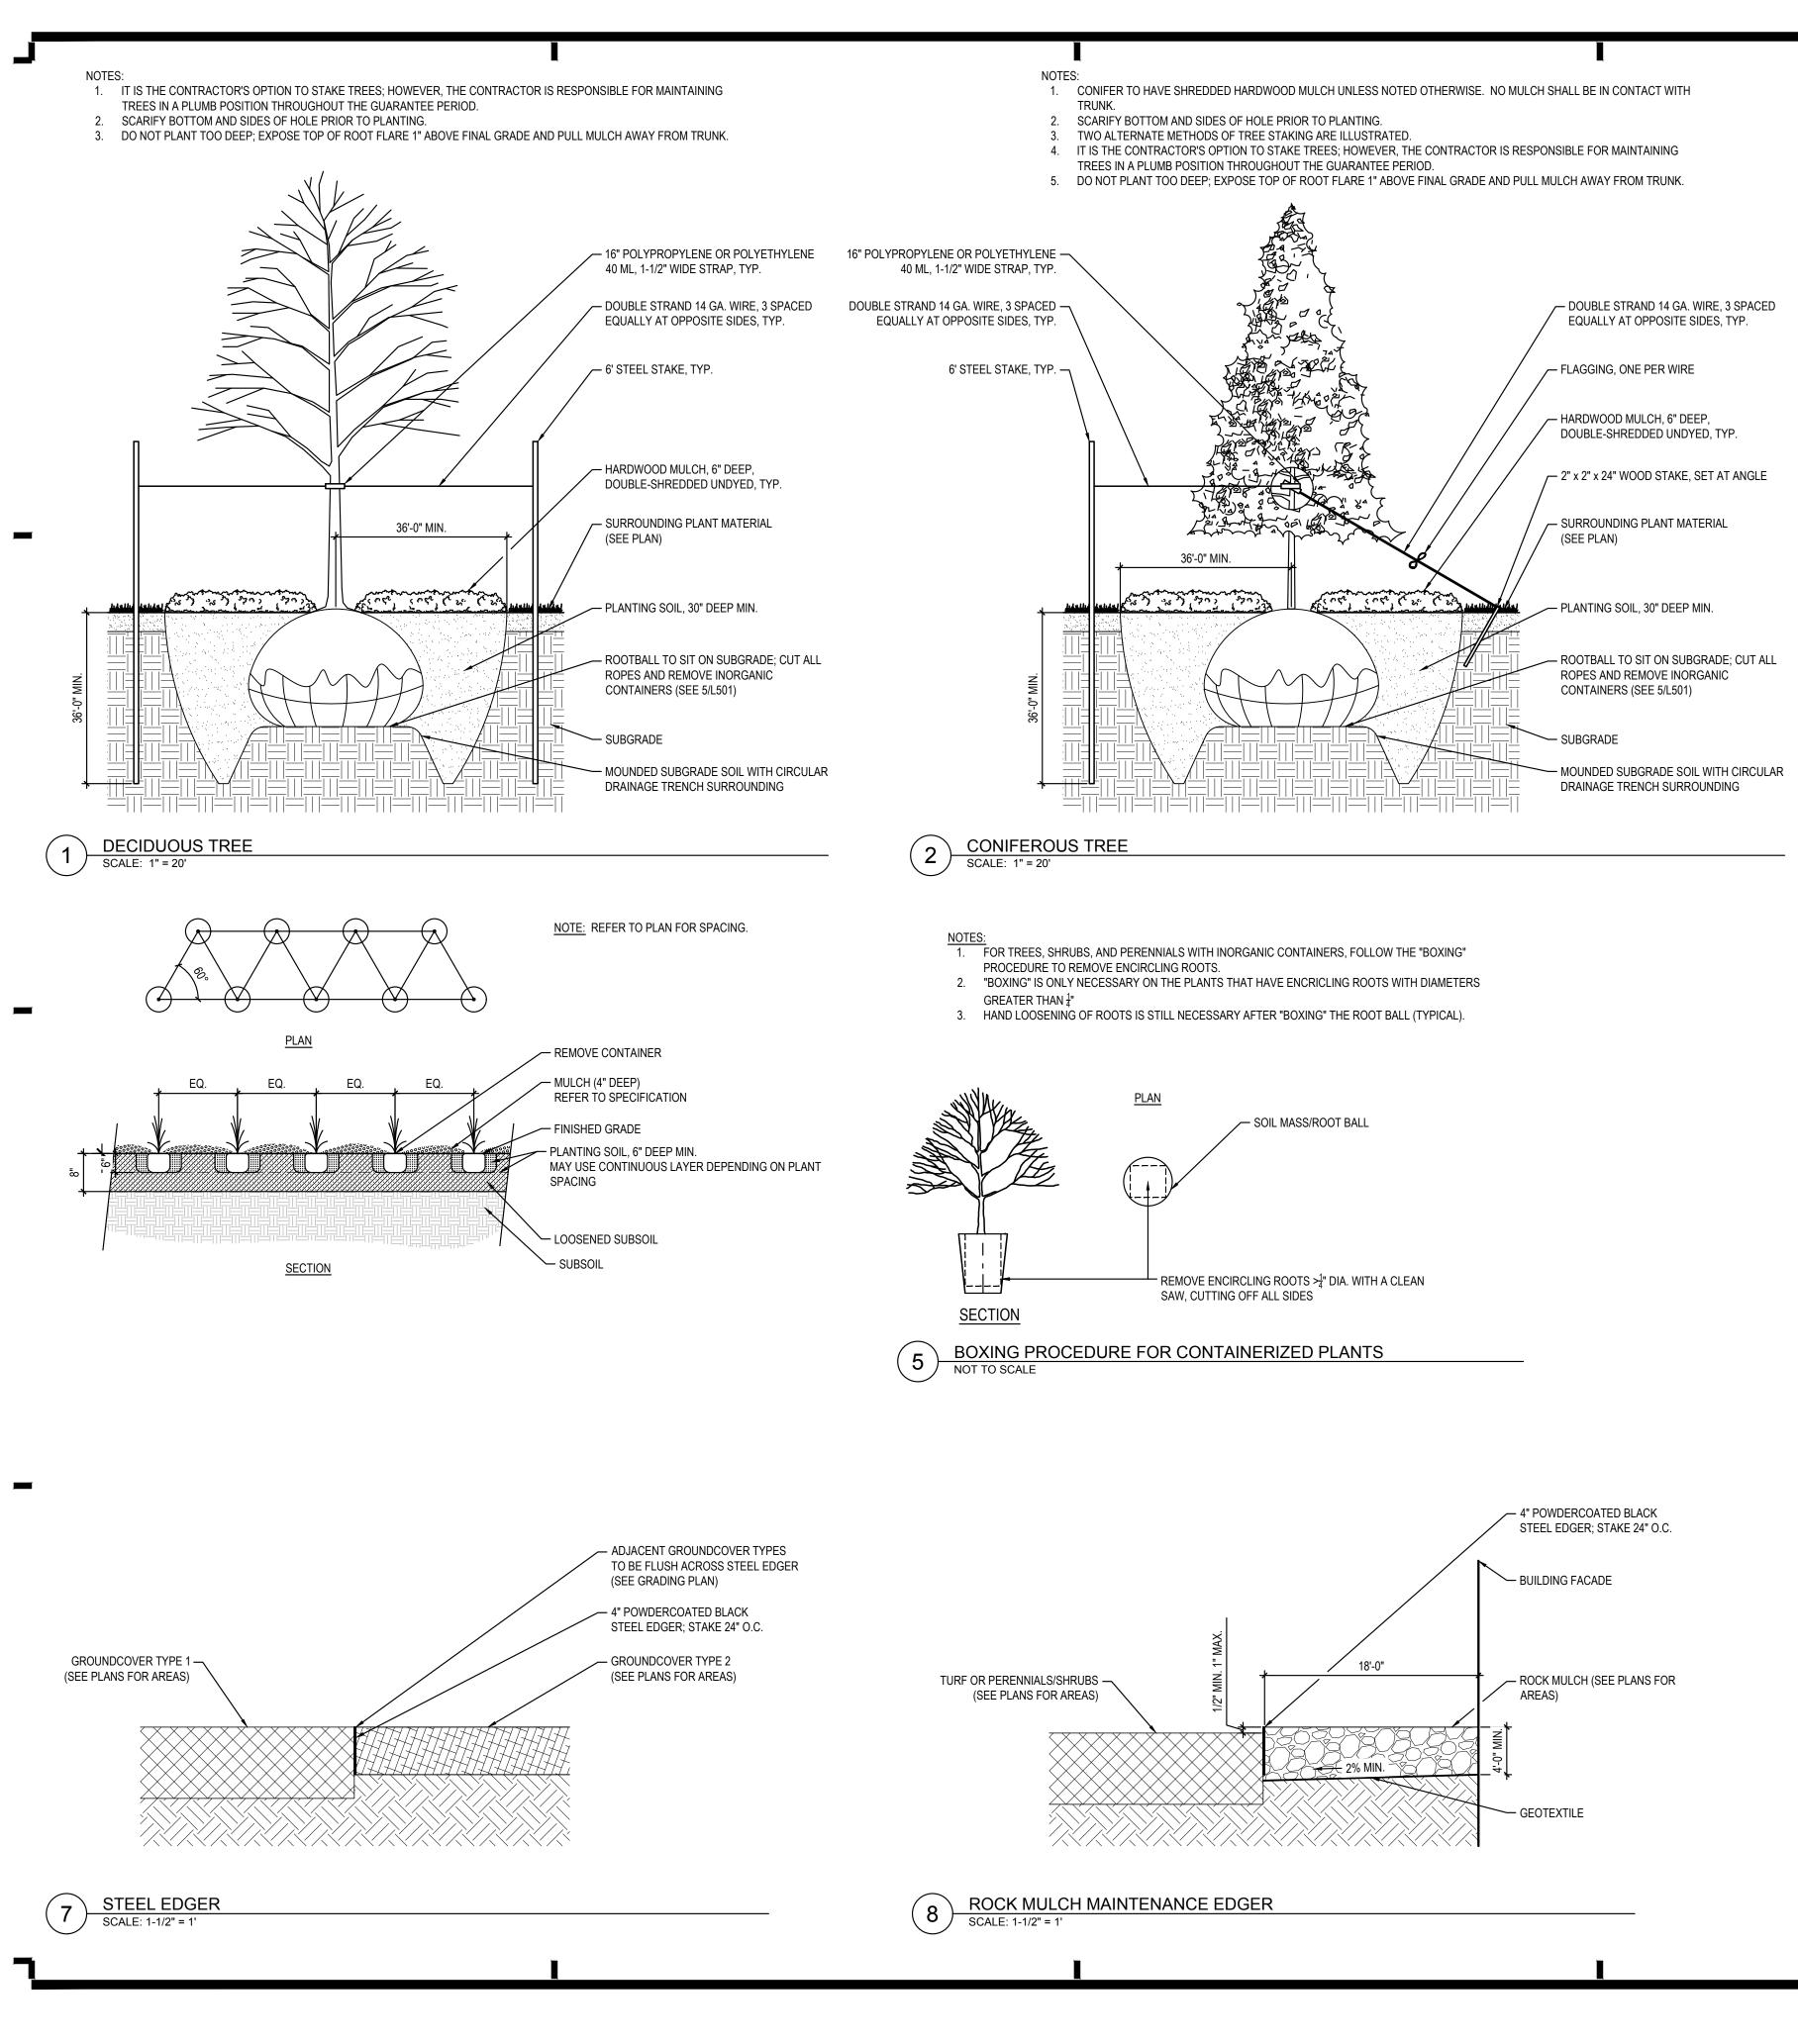

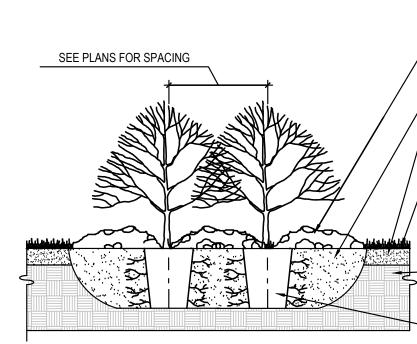

1. HAND LOOSEN ROOTS OF CONTAINERIZED MATERIAL (TYPICAL).

4. SCARIFY BOTTOM AND SIDES OF HOLE PRIOR TO PLANTING.


6. APPLY PELLET WEED PREVENTER PRIOR TO MULCHING.

SHRUBS TO SIT ON SUBGRADE.



NOTES:

5.

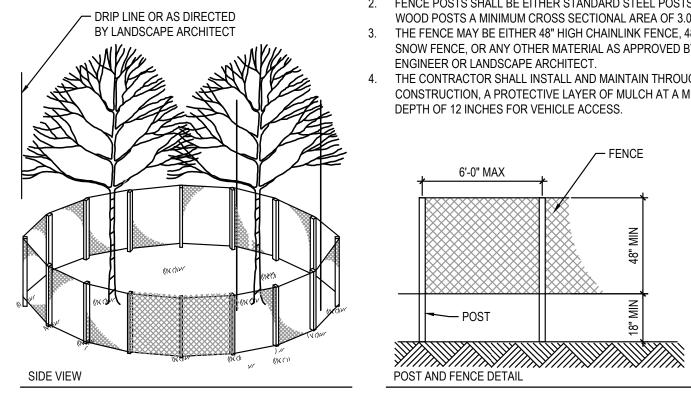

TREE PROTECTION 6 NOT TO SCALE

# 2. HAND REMOVE EXCESS SOIL AT TOP OF ROOT BALL TO EXPOSE TOP OF ROOT FLARE. TYPICALLY REQUIRES THE REMOVAL OF 1-6" OF SOIL FROM CONTAINER OR B&B. ENSURE THAT FIRST MAIN LATERAL ROOT IS LESS THAN 1" BELOW THE FINAL PLANTING SURFACE.

- HARDWOOD MULCH (4" DEEP) – PLANTING SOIL, 12" DEEP MIN, - TOPSOIL, 4" DEEP – GROUNDCOVER, PER PLAN

APPROVED SUBGRADE

- SLIT ORGANIC CONTAINER, OR REMOVE INORGANIC CONT. AND SEE DETAIL 6/L501

- NOTES: 1. THE FENCE SHALL BE LOCATED AT THE DRIP LINE OF THE TREE TO BE SAVED.
- 2. FENCE POSTS SHALL BE EITHER STANDARD STEEL POSTS OR WOOD POSTS A MINIMUM CROSS SECTIONAL AREA OF 3.0 SQ. IN. 3. THE FENCE MAY BE EITHER 48" HIGH CHAINLINK FENCE, 48" HIGH
- SNOW FENCE, OR ANY OTHER MATERIAL AS APPROVED BY THE 4. THE CONTRACTOR SHALL INSTALL AND MAINTAIN THROUGHOUT
- CONSTRUCTION, A PROTECTIVE LAYER OF MULCH AT A MINIMUM

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CITY OF MINNEAPOLIS APPROVAL STAMP:

701 Washington Ave. N, Ste 200 | Minneapolis, MN 55401 | 612.338.2029

CLIENT: CommonBond Communities

# 1080 MONTREAL AVENUE ST PAUL, MN 55116

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> 2609 BLAISDELL AVE S MINNEAPOLIS, MN 55408

DRAWING TITLE: LANDSCAPE DETAILS


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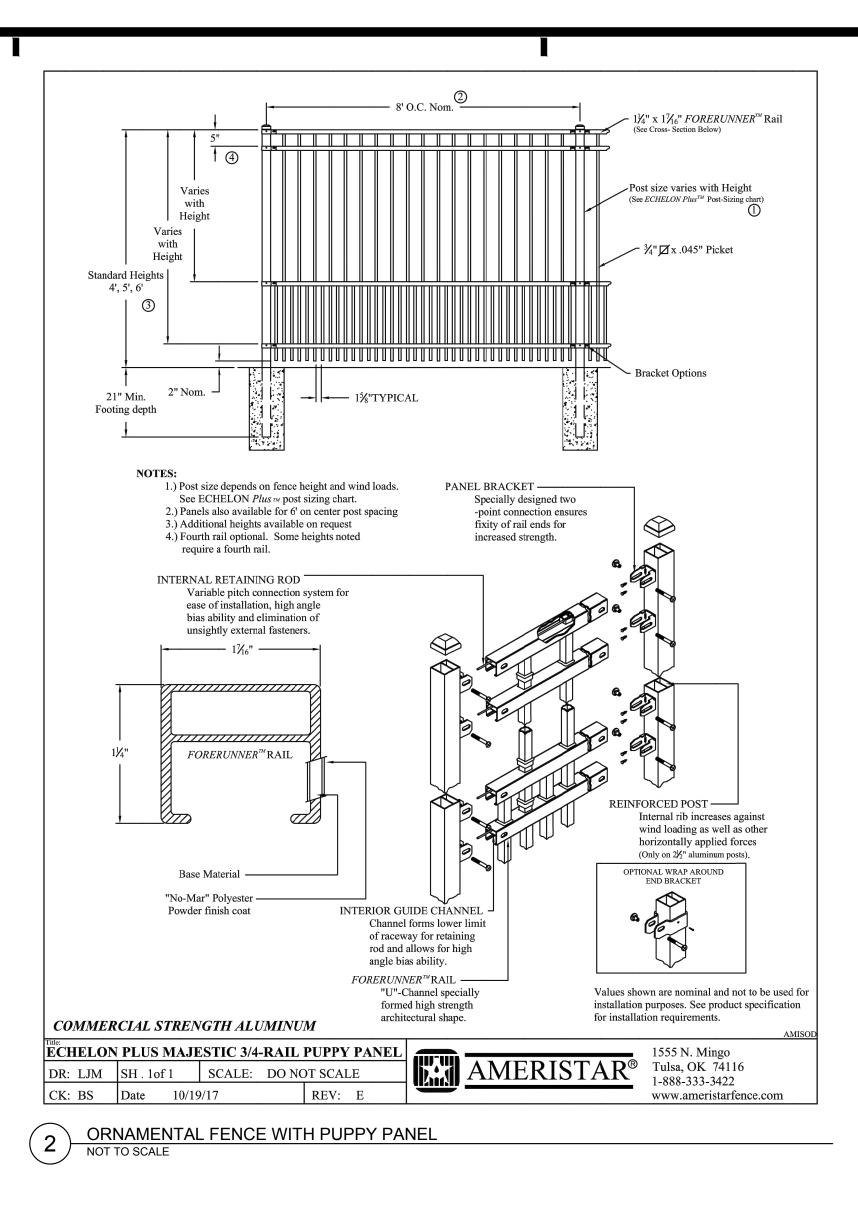
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701 Washington Ave. N, Ste 200 | Minneapolis, MN 55401 | 612.338.2029

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PR	FOR CO 05/1	INARY NSTRUCTION 4/2021
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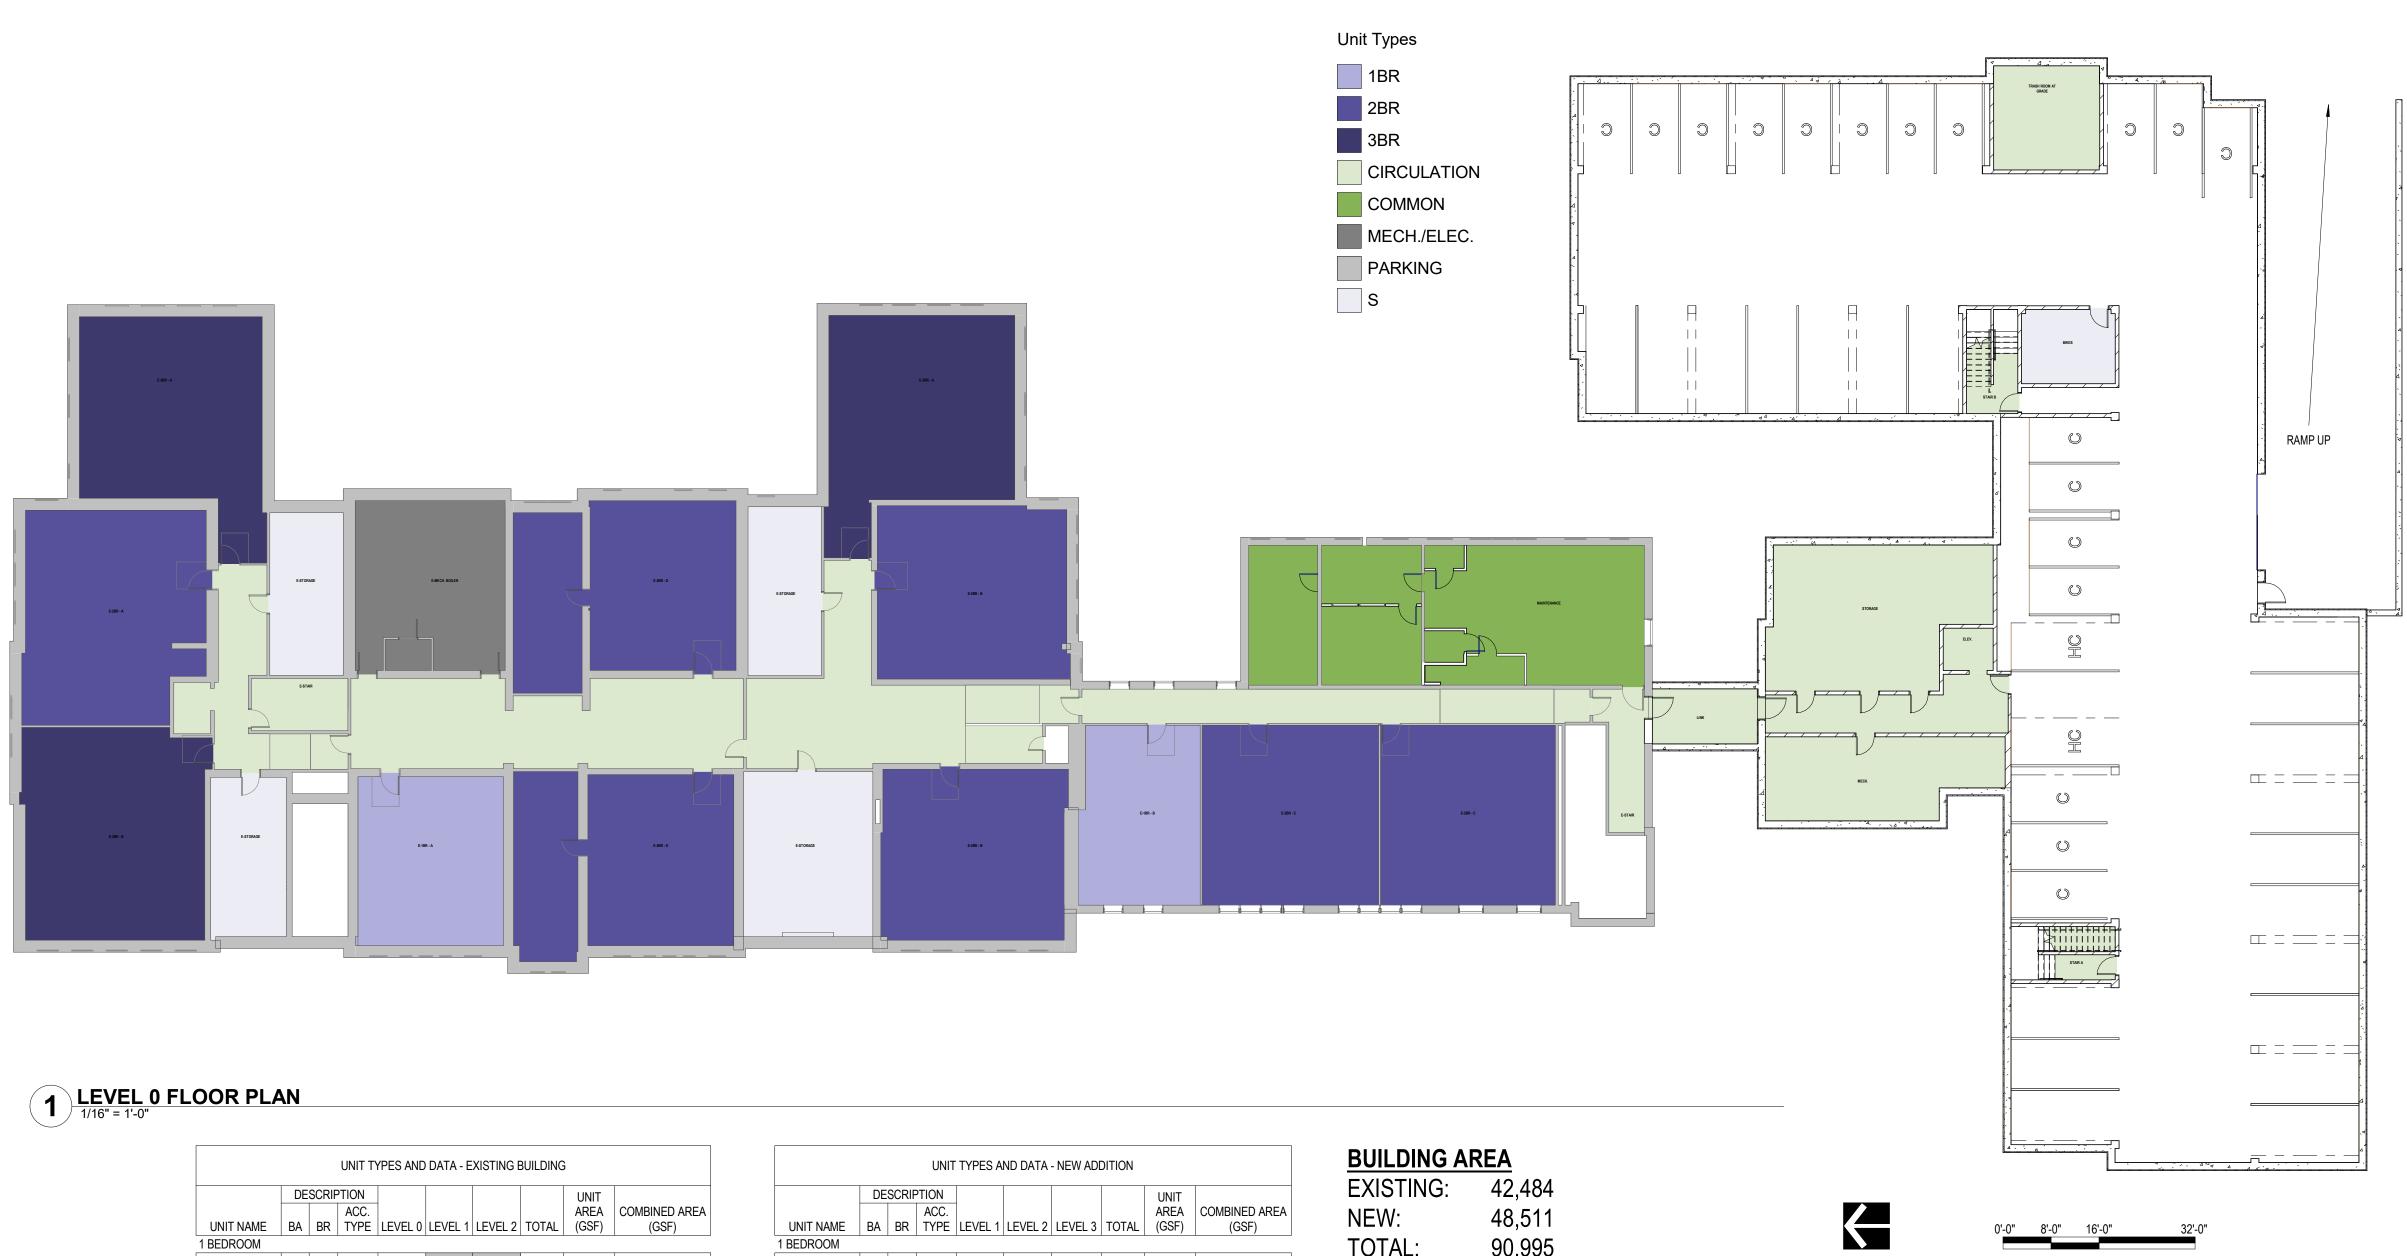
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	DE	SCRIF	PTION					UNIT	
			ACC.	1				AREA	COMBINED AR
UNIT NAME	BA	BR	TYPE	LEVEL 0	LEVEL 1	LEVEL 2	TOTAL	(GSF)	(GSF)
1 BEDROOM									
E-1BR - A	1	1	В	1	0	0	1	680 SF	680 SF
E-1BR - B	1	1	В	1	1	1	3	590 SF	1,770 SF
E-1BR - C	1	1	В	0	1	0	1	620 SF	620 SF
				2	2	1	5		3,070 SF
2 BEDROOM									
E-2BR - A	1	2	В	1	1	1	3	1,000 SF	3,000 SF
E-2BR - B	1	2	В	2	2	2	6	870 SF	5,220 SF
E-2BR - C	1	2	В	2	2	2	6	880 SF	5,280 SF
E-2BR - D	1	2	В	2	0	0	2	1,080 SF	2,160 SF
E-2BR - E	1	2	В	0	2	0	2	950 SF	1,900 SF
E-2BR - F	1	2	Α	0	2	2	4	930 SF	3,720 SF
E-2BR - G	1	2	В	0	1	0	1	780 SF	780 SF
E-2BR - H	1	2	В	0	0	2	2	970 SF	1,940 SF
			•	7	10	9	26	r	24,000 SF
3 BEDROOM									
E-3BR - A	1	3	В	2	2	2	6	1,010 SF	6,060 SF
E-3BR - B	1	3	В	1	1	1	3	1,065 SF	3,195 SF
E-3BR - C	1	3	В	0	0	1	1	1,075 SF	1,075 SF
				3	3	4	10		10,330 SF
				12	15	14	41		37,400 SF

2



1

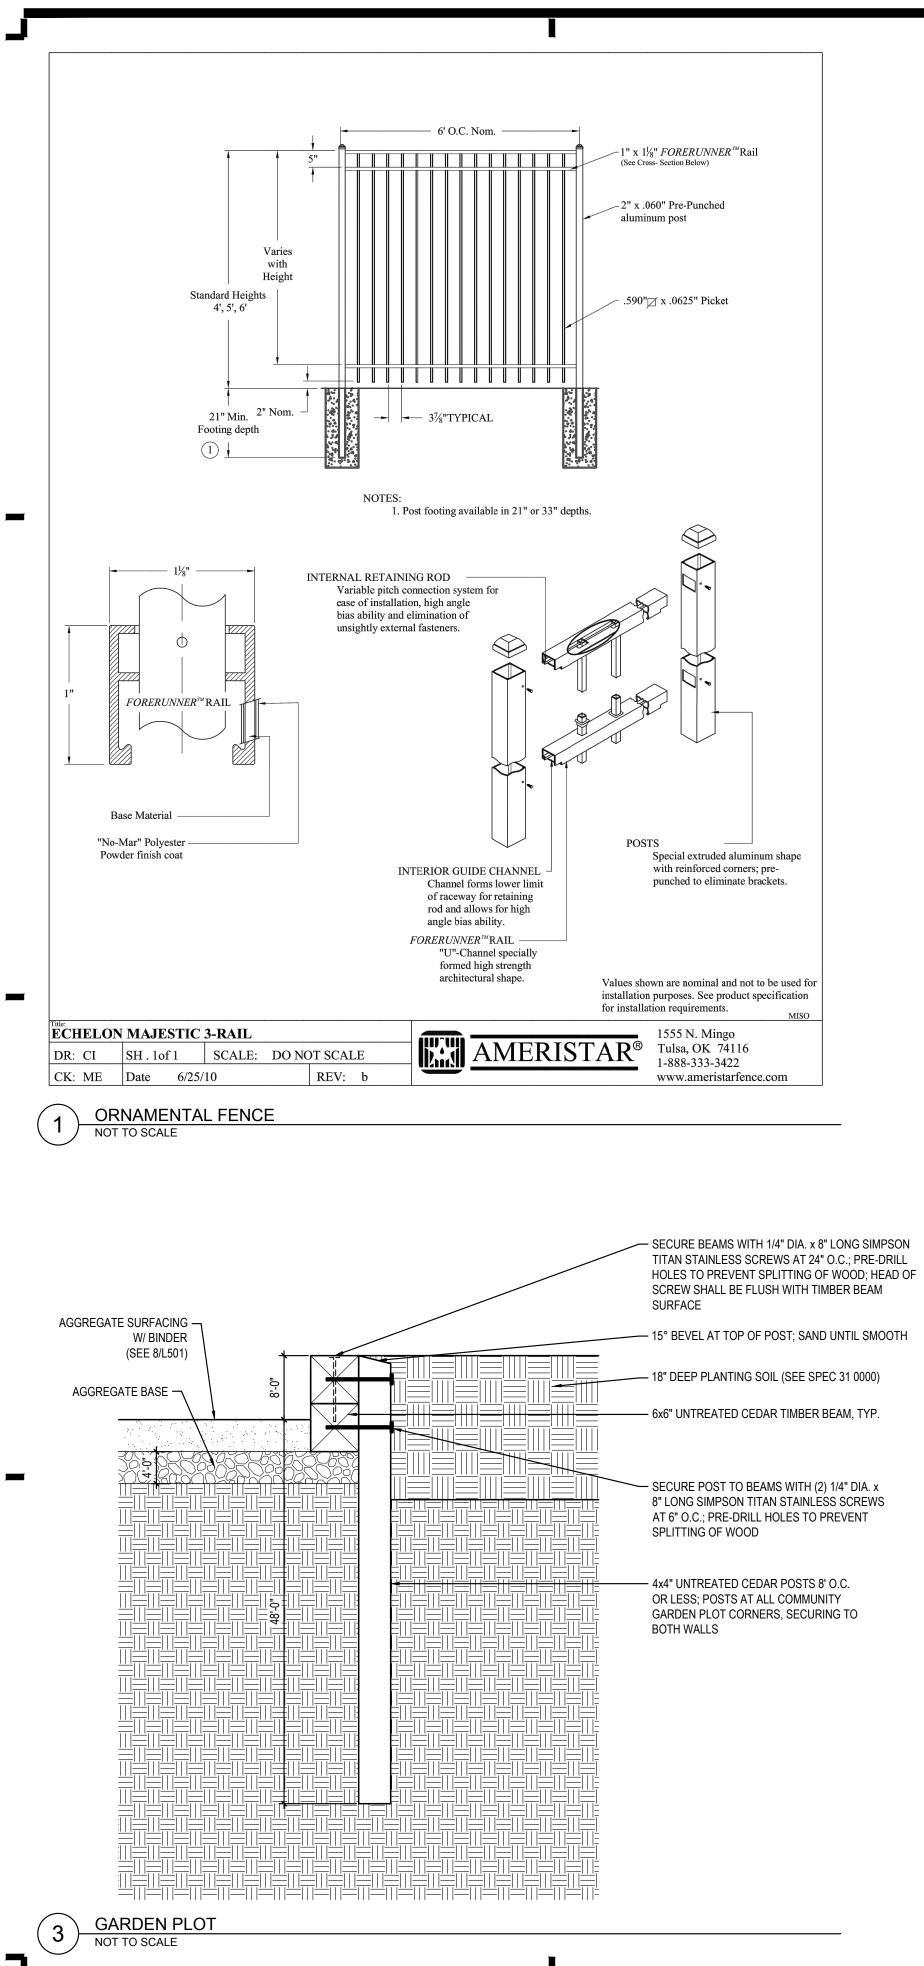

			UNIT	TYPES A	ND DATA	- NEW ADI	DITION		
	DE	SCRIF	TION					UNIT	
			ACC.					AREA	COMBINED AREA
UNIT NAME	BA	BR	TYPE	LEVEL 1	LEVEL 2	LEVEL 3	TOTAL	(GSF)	(GSF)
1 BEDROOM									
1BR-1	1	1	В	1	1	1	3	635 SF	1,905 SF
1BR-2 (TYPE 'A')	1	1	А	0	1	1	2	710 SF	1,420 SF
1BR-3	1	1	В	1	1	1	3	595 SF	1,785 SF
				2	3	3	8		5,110 SF
2 BEDROOM									
2BR-1	1	2	В	2	2	2	6	890 SF	5,340 SF
2BR-2	1	2	В	1	1	1	3	885 SF	2,655 SF
2BR-3	1	2	В	2	2	2	6	890 SF	5,340 SF
2BR-4	1	2	В	1	1	1	3	915 SF	2,745 SF
2BR-5	1	2	В	1	1	1	3	815 SF	2,445 SF
2BR-6	1	2	Α	0	1	1	2	885 SF	1,770 SF
				7	8	8	23		20,295 SF
3 BEDROOM									
3BR-1 (TYPE 'A')	2	3	В	1	1	1	3	1,100 SF	3,300 SF
3BR-2	2	3	В	1	1	1	3	1,085 SF	3,255 SF
3BR-3	2	3	В	1	1	1	3	1,070 SF	3,210 SF
				3	3	3	9		9,765 SF
				12	14	14	40		35,170 SF


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B	UI	LD	ING	AREA	

EXISTING:	42,484
NEW:	48,511
TOTAL:	90,995

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UNIT TYPES AND DATA - EXISTING BUILDING										
	DE	SCRIF	PTION	-				UNIT		
UNIT NAME	BA	BR	ACC. TYPE		I FVFI 1	LEVEL 2	TOTAL	AREA (GSF)	COMBINED ARE (GSF)	
1 BEDROOM	271	Div					101712	(00)		
E-1BR - A	1	1	В	1	0	0	1	680 SF	680 SF	
E-1BR - B	1	1	B	1	1	1	3	590 SF	1,770 SF	
E-1BR - C	1	1	B	0	1	0	1	620 SF	620 SF	
-	<u> </u>	I	I	2	2	1	5		3,070 SF	
2 BEDROOM									,	
E-2BR - A	1	2	В	1	1	1	3	1,000 SF	3,000 SF	
E-2BR - B	1	2	В	2	2	2	6	870 SF	5,220 SF	
E-2BR - C	1	2	В	2	2	2	6	880 SF	5,280 SF	
E-2BR - D	1	2	В	2	0	0	2	1,080 SF	2,160 SF	
E-2BR - E	1	2	В	0	2	0	2	950 SF	1,900 SF	
E-2BR - F	1	2	Α	0	2	2	4	930 SF	3,720 SF	
E-2BR - G	1	2	В	0	1	0	1	780 SF	780 SF	
E-2BR - H	1	2	В	0	0	2	2	970 SF	1,940 SF	
				7	10	9	26		24,000 SF	
3 BEDROOM										
E-3BR - A	1	3	В	2	2	2	6	1,010 SF	6,060 SF	
E-3BR - B	1	3	В	1	1	1	3	1,065 SF	3,195 SF	
E-3BR - C	1	3	В	0	0	1	1	1,075 SF	1,075 SF	
				3	3	4	10		10,330 SF	
				12	15	14	41		37,400 SF	

# **1 LEVEL 1 FLOOR PLAN** 1/16" = 1'-0"

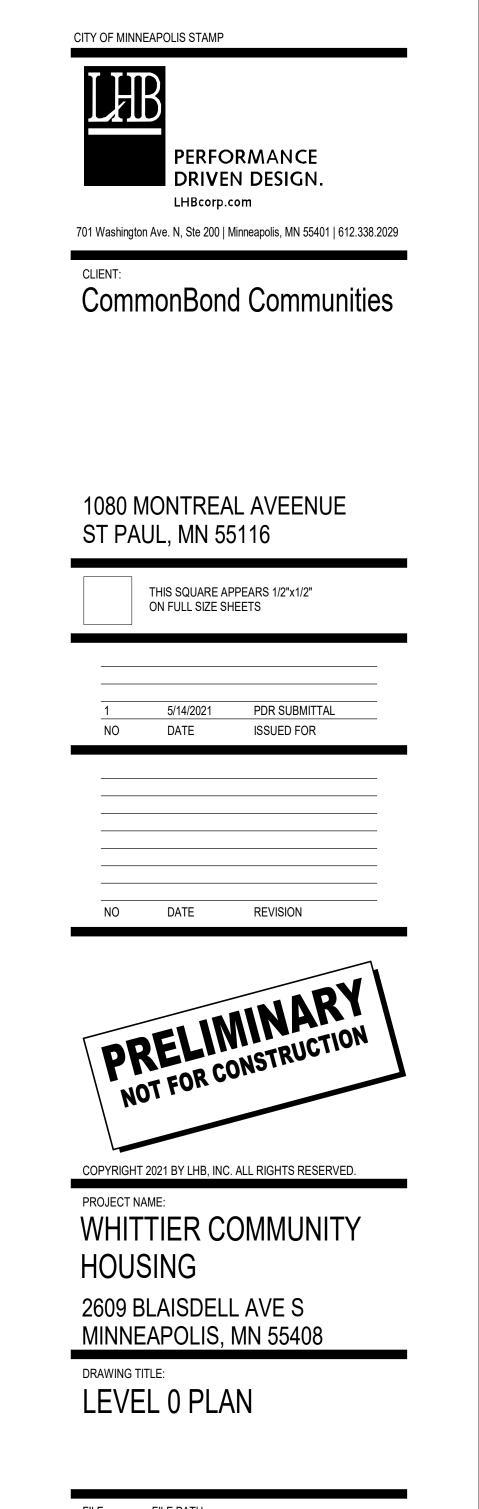

			UNIT	TYPES A	ND DATA	- NEW ADI	DITION		
	DE	SCRIF	TION					UNIT	
			ACC.					AREA	COMBINED AREA
UNIT NAME	BA	BR	TYPE	LEVEL 1	LEVEL 2	LEVEL 3	TOTAL	(GSF)	(GSF)
1 BEDROOM									
1BR-1	1	1	В	1	1	1	3	635 SF	1,905 SF
1BR-2 (TYPE 'A')	1	1	А	0	1	1	2	710 SF	1,420 SF
1BR-3	1	1	В	1	1	1	3	595 SF	1,785 SF
				2	3	3	8		5,110 SF
2 BEDROOM									
2BR-1	1	2	В	2	2	2	6	890 SF	5,340 SF
2BR-2	1	2	В	1	1	1	3	885 SF	2,655 SF
2BR-3	1	2	В	2	2	2	6	890 SF	5,340 SF
2BR-4	1	2	В	1	1	1	3	915 SF	2,745 SF
2BR-5	1	2	В	1	1	1	3	815 SF	2,445 SF
2BR-6	1	2	А	0	1	1	2	885 SF	1,770 SF
				7	8	8	23		20,295 SF
3 BEDROOM									
3BR-1 (TYPE 'A')	2	3	В	1	1	1	3	1,100 SF	3,300 SF
3BR-2	2	3	В	1	1	1	3	1,085 SF	3,255 SF
3BR-3	2	3	В	1	1	1	3	1,070 SF	3,210 SF
				3	3	3	9		9,765 SF
				12	14	14	40		35,170 SF

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# 

<u>BUILDING AREA</u>								
EXISTING:	42,484							
NEW:	48,511							
TOTAL:	90,995							


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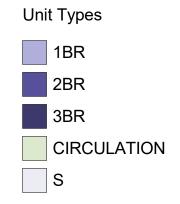
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UNIT NAME	BA	BR	ACC. TYPE	LEVEL 0	LEVEL 1	LEVEL 2	TOTAL	AREA (GSF)	COMBINED AREA (GSF)
1 BEDROOM		_							
E-1BR - A	1	1	В	1	0	0	1	680 SF	680 SF
E-1BR - B	1	1	В	1	1	1	3	590 SF	1,770 SF
E-1BR - C	1	1	В	0	1	0	1	620 SF	620 SF
				2	2	1	5		3,070 SF
2 BEDROOM									
E-2BR - A	1	2	В	1	1	1	3	1,000 SF	3,000 SF
E-2BR - B	1	2	В	2	2	2	6	870 SF	5,220 SF
E-2BR - C	1	2	В	2	2	2	6	880 SF	5,280 SF
E-2BR - D	1	2	В	2	0	0	2	1,080 SF	2,160 SF
E-2BR - E	1	2	В	0	2	0	2	950 SF	1,900 SF
E-2BR - F	1	2	Α	0	2	2	4	930 SF	3,720 SF
E-2BR - G	1	2	В	0	1	0	1	780 SF	780 SF
E-2BR - H	1	2	В	0	0	2	2	970 SF	1,940 SF
				7	10	9	26		24,000 SF
3 BEDROOM									
E-3BR - A	1	3	В	2	2	2	6	1,010 SF	6,060 SF
E-3BR - B	1	3	В	1	1	1	3	1,065 SF	3,195 SF
E-3BR - C	1	3	В	0	0	1	1	1,075 SF	1,075 SF
				3	3	4	10		10,330 SF
				12	15	14	41		37,400 SF

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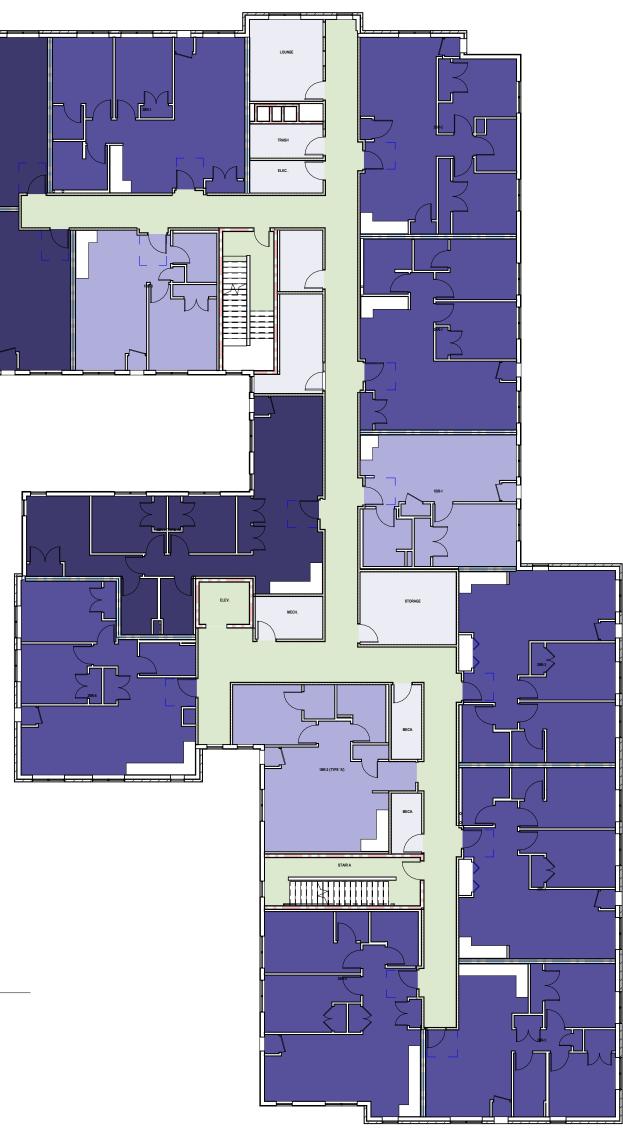
# **1 LEVEL 2 FLOOR PLAN** 1/16" = 1'-0"

1





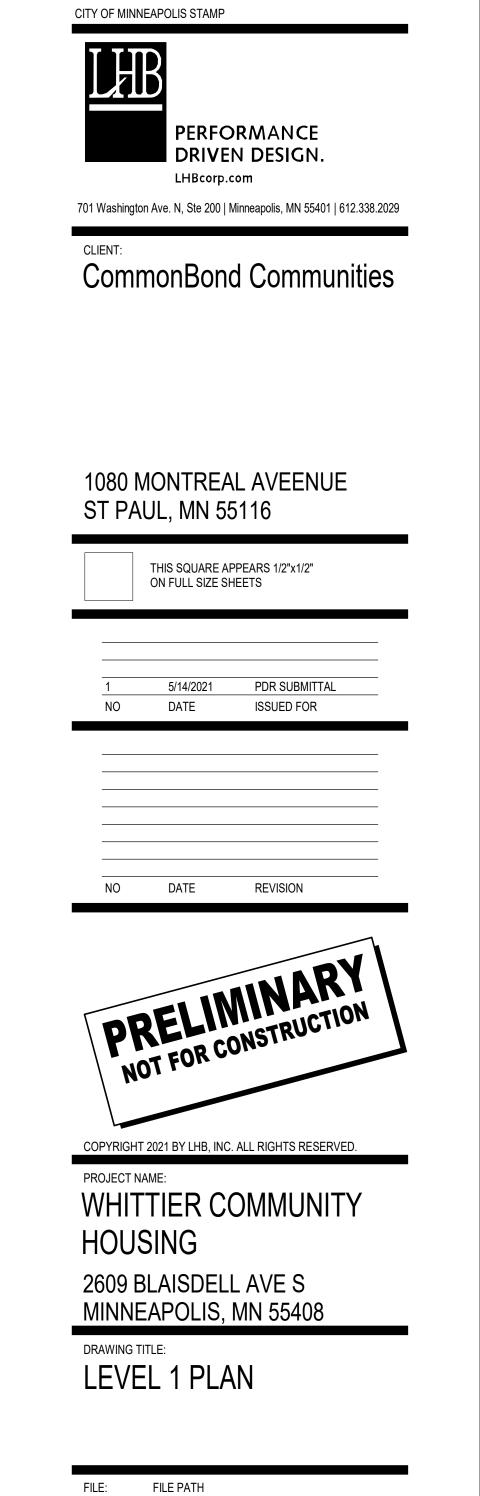



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			UNIT	TYPES A	ND DATA	- NEW ADI	DITION		
	DE	SCRIF	PTION					UNIT	
UNIT NAME	BA	BR	ACC. TYPE	LEVEL 1	LEVEL 2	LEVEL 3	TOTAL	AREA (GSF)	COMBINED AREA (GSF)
1 BEDROOM									
1BR-1	1	1	В	1	1	1	3	635 SF	1,905 SF
1BR-2 (TYPE 'A')	1	1	Α	0	1	1	2	710 SF	1,420 SF
1BR-3	1	1	В	1	1	1	3	595 SF	1,785 SF
				2	3	3	8		5,110 SF
2 BEDROOM									
2BR-1	1	2	В	2	2	2	6	890 SF	5,340 SF
2BR-2	1	2	В	1	1	1	3	885 SF	2,655 SF
2BR-3	1	2	В	2	2	2	6	890 SF	5,340 SF
2BR-4	1	2	В	1	1	1	3	915 SF	2,745 SF
2BR-5	1	2	В	1	1	1	3	815 SF	2,445 SF
2BR-6	1	2	Α	0	1	1	2	885 SF	1,770 SF
				7	8	8	23		20,295 SF
3 BEDROOM									
3BR-1 (TYPE 'A')	2	3	В	1	1	1	3	1,100 SF	3,300 SF
3BR-2	2	3	В	1	1	1	3	1,085 SF	3,255 SF
3BR-3	2	3	В	1	1	1	3	1,070 SF	3,210 SF
				3	3	3	9		9,765 SF
				12	14	14	40		35,170 SF

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<b>BUILDING ARI</b>	FΔ

EXISTING:	42,484
NEW:	48,511
TOTAL:	90,995

4



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CITY OF MINNEAPOLIS STAMP

LHB

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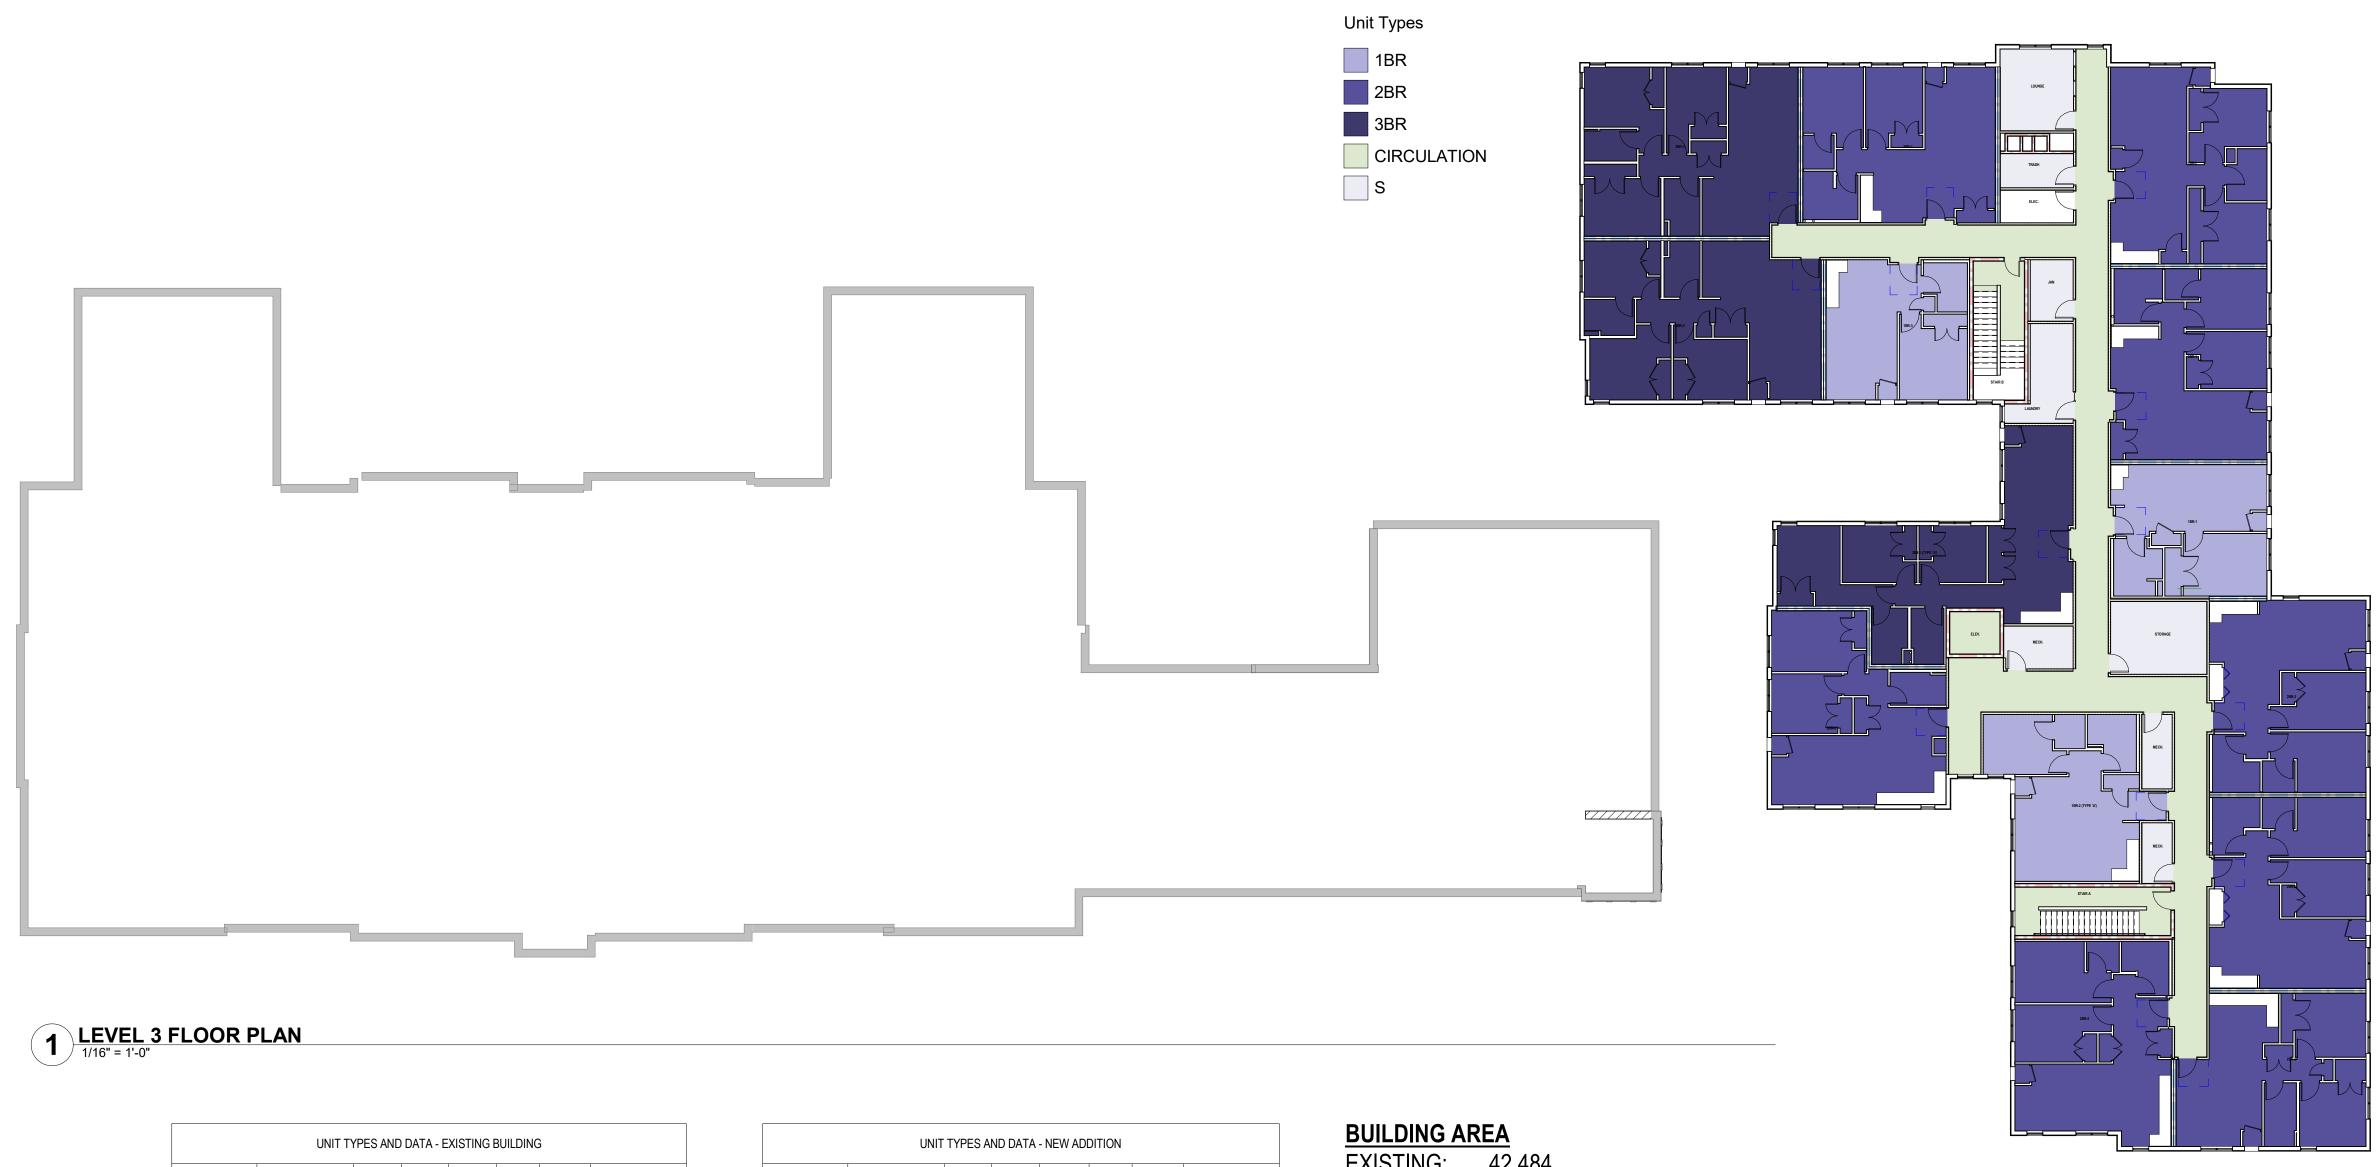
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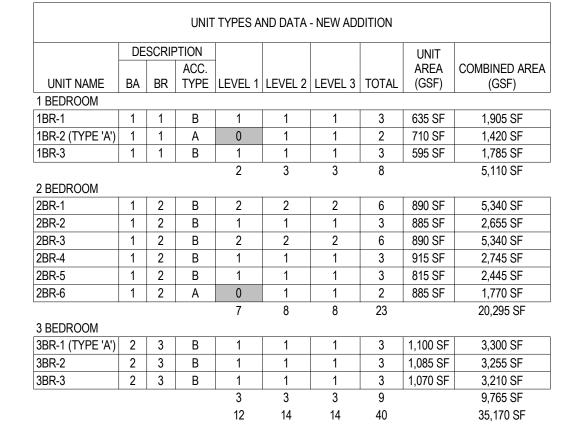
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	DE	SCRIF	PTION					UNIT	
UNIT NAME	BA	BR	ACC. TYPE	LEVEL 0	LEVEL 1	LEVEL 2	TOTAL	AREA (GSF)	COMBINED ARE/ (GSF)
1 BEDROOM									
E-1BR - A	1	1	В	1	0	0	1	680 SF	680 SF
E-1BR - B	1	1	В	1	1	1	3	590 SF	1,770 SF
E-1BR - C	1	1	В	0	1	0	1	620 SF	620 SF
2 BEDROOM				2	2	1	5		3,070 SF
E-2BR - A	1	2	В	1	1	1	3	1,000 SF	3,000 SF
E-2BR - B	1	2	В	2	2	2	6	870 SF	5,220 SF
E-2BR - C	1	2	В	2	2	2	6	880 SF	5,280 SF
E-2BR - D	1	2	В	2	0	0	2	1,080 SF	2,160 SF
E-2BR - E	1	2	В	0	2	0	2	950 SF	1,900 SF
E-2BR - F	1	2	A	0	2	2	4	930 SF	3,720 SF
E-2BR - G	1	2	В	0	1	0	1	780 SF	780 SF
E-2BR - H	1	2	В	0	0	2	2	970 SF	1,940 SF
3 BEDROOM				7	10	9	26		24,000 SF
E-3BR - A	1	3	В	2	2	2	6	1,010 SF	6,060 SF
E-3BR - B	1	3	В	1	1	1	3	1,065 SF	3,195 SF
E-3BR - C	1	3	В	0	0	1	1	1,075 SF	1,075 SF
				3	3	4	10		10,330 SF
				12	15	14	41		37,400 SF

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42,484
48,511
90,995

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CLIENT: CommonBond Communities

PERFORMANCE

DRIVEN DESIGN.

701 Washington Ave. N, Ste 200 | Minneapolis, MN 55401 | 612.338.2029

LHBcorp.com

CITY OF MINNEAPOLIS STAMP

LHB

# 1080 MONTREAL AVEENUE ST PAUL, MN 55116

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WEST ELEVATION



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4

# EXTERIOR ELEVATION KEY

B1	BRICK (MODULAR)
BCD	BRICK COURSING DETAIL
C1	CORNICE 1 (PREFINISHED
	SHEET METAL)
C2	CORNICE 2 (PREFINISHED
	SHEET METAL)
CONC1	CONCRETE
EC1	ENTRANCE CANOPY
	(FABRICATED STEEL)
ML1	COLOR-MATCHED LOUVER
MP1	PREFINISHED METAL PANEL
OHD	OVERHEAD DOOR

CITY OF MINNEAPOLIS STAMP



CLIENT: CommonBond Communities

# 1080 MONTREAL AVEENUE ST PAUL, MN 55116

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BIM 360://180586 Commond Bond Whittier Site Assessment/180586 Whittier Apartment 5/14/2021 12:10:20 PM

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С

В

# NORTH ELEVATION

- BCD

- MP1

CONC1

2

# EAST ELEVATION

CONC1

1

BR1

C1



3



4

# EXTERIOR ELEVATION KEY

B1	BRICK (MODULAR)
BCD	BRICK COURSING DETAIL
C1	CORNICE 1 (PREFINISHED
	SHEET METAL)
C2	CORNICE 2 (PREFINISHED
	SHEET METAL)
CONC1	CONCRETE
EC1	ENTRANCE CANOPY
	(FABRICATED STEEL)
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5



	NORTH ELEVATION		EVATION SOUTH ELEVATION		EAST ELEVATION		WEST EL	EVATION	TOTAL	
	AREA	PERCENTAGE	AREA	PERCENTAGE	AREA	PERCENTAGE	AREA	PERCENTAGE	AREA	PERCENTAGE
BRICK	1460	25.34%	1566	26.31%	2305	38.94%	1316	24.11%	6647	28.78%
METAL PANEL	3772	65.47%	3414	57.35%	2625	44.34%	3640	66.68%	13451	58.25%
GLAZING	220	3.82%	187	3.14%	207	3.50%	258	4.73%	872	3.78%
CONCRETE	309	5.36%	786	13.20%	783	13.23%	245	4.49%	2123	9.19%

# MATERIAL CALCULATIONS PER BUILDING FACADE





2

SOUTH ELEVATION 1/16" = 1'-0"

1

Α 12:10:21 360://

D

С

В



4



3



0' 8' 16'

5

1080 MONTREAL AVEENUE ST PAUL, MN 55116

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# **PHOTOS** NEW BUILDING SITE EXISTING CONDITIONS



Existing Yard Facing Alley Looking SE

D

В



Existing Playground



New Building Site Looking SW

1



3

New Building SIte Looking West

2



New Building Site Looking SE



New Building Site Looking SW at Adjacent Building

New Building Slte Looking NW



4

Housing Across Blaisdell and Sidewalk to Existing Southern Entrance

5





# PHOTOS SITE CONTEXT



Existing Front Yard Looking N Along Blaisdell Near Existing Southern Most Entrance to Building



Front of Existing Building Looking North



Existing Parking Lot Entry/Entrance to Alley From 26th Street

1



Existing Parking Lot Looking NW

2

D

С


В



Existing Front Yard Looking NW Along Blaisdell



Existing Front Yard Looking South Along Blaisdell

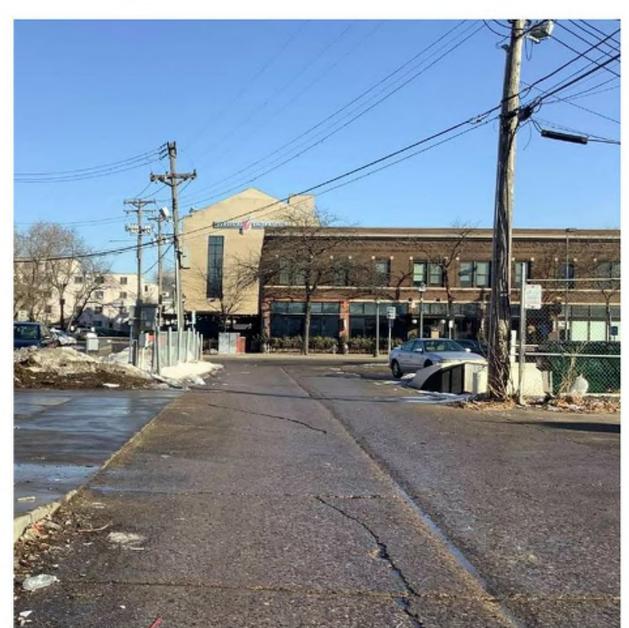

4


Alley Looking North to 26th Street

3



5

Alley Looking South to 27th Street

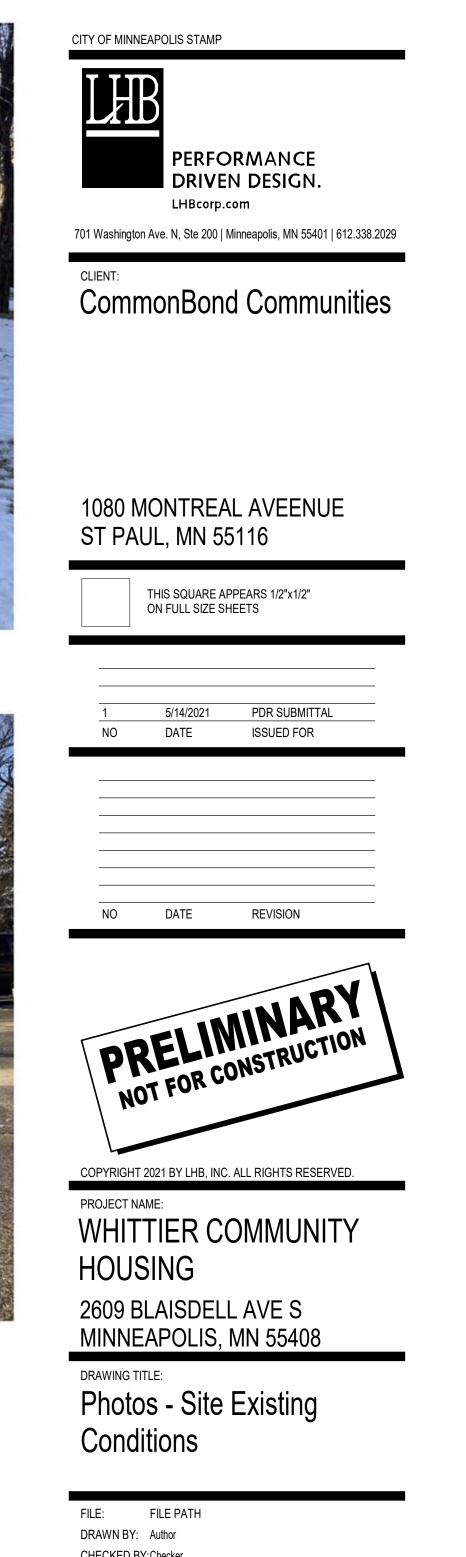

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